

### SET 1 OF 2

### PROJECT TEAM:

OWNER/DEVELOPER:
TRINITY WASHINGTON VILLAGE LIMITED
PARTNERSHIP

**Š** 

THE NORWALK HOUSING AUTHORITY

#### **ARCHITECT:**

ICON ARCHITECTURE, INC 101 SUMMER STREET, BOSTON, MA 02110 (617) 451-3333

### **CIVIL ENGINEER:**

TIGHE & BOND 100 BRIDGEPORT AVENUE SUITE 320 SHELTON, CT, 06484 (203) 712-1100

### **GEOTECHNICAL ENGINEER:**

MCPHAIL ASSOCIATES, LLC 30 NORFOLK STREET CAMBRIDGE, MA, 02139 (617) 868-1420

## MECHANICAL / FIRE PROTECTION, ELECTRICAL / TEL/DATA ENGINEER:

CENTEK ENGINEERING, INC 63-2 NORTH BRANFORD ROAD, BRANFORD, CT 06405 (203) 488-0580

#### STRUCTURAL ENGINEER:

GNCB CONSULTING ENGINEERS 130 ELM STREET, OLD SAYBROOK, CT, 06475 (860) 388-1224

#### LANDSCAPE ARCHITECT:

ERIC RAINS LANDSCAPE ARCHITECTURE
33 NORTH WATER STREET, SOUTH NORWALK, CT,
06854
(203) 853-7600

#### **SURVEY ENGINEER:**

WILLIAM SEYMOUR & ASSOCIATES, PC 170 NOROTON AVENUE, DARIEN, CT, 06820 (203) 655-3331

# Washington Village PHASE 1

13 Day Street/ Parcel 1 / Building A South Norwalk, CT

PERMIT / PRICING SET SEPTEMBER 15, 2014

SYMBOLS	۸RR	REVIATION	us.	
STWIDULS	ADD			Janitor
	CL. O.	Centerline	JAN. CLO. JT.	Janitor Closet Joint
	#	Pound or Number	KIT.	Kitchen
	(E). ACT.		LAB. LAM.	Laboratory Laminate
	ACST.	Acoustic	LAV.	Lavatory
	AD. ADJ.		LKR. LT.	Locker Light
COLUMN LINE	AGGR.	Aggregate		Light Gage Maximum
COLUMN LINE	ALUM. APPROX.	Approximate	MC.	Medicine Cabinet
	ARCH. ASB.		MECH. MEMB.	Mechanical Membrane
	ASPH.	Asphalt	MTL.	Metal
O DOOR TYPE	AT. BD.		MFR. MH.	Manufacturer Manhole
IDENTIFIER	BITUM.	Bituminous	MIN.	Minimum
✓ WINDOW TYPE	BLDG. BLK.		MIRR. MISC.	Mirror Miscellaneous
IDENTIFIER	BLKG. BM.	Blocking Beam	MO. MR.	Masonry Opening Moisture Resistant
	B.O.	Bottom	MTD.	Mounted
WALL TAG	BR. CAB.		MULL. N.	Mullion North
TITLE MARK	CB. CBB.	Catch Basin Cementitious Backer Board	NIC.	Not In Contract Number
DRAWING BLOCK TITLE	CEM.	Cement	NOM.	Nominal
10-10	CG. Cl.	Corner Guard Cast Iron	NTS. OA.	Not To Scale Overall
0 4' 8' 16' BAR SCALE	CLG.	Ceiling	OBS.	Obscure
SCALE: 1/8" = 1'-0"	q CLKG.	Centerline Caulking	OC. OD.	On Center Outside Diameter
DETAIL KEY	CLO. CLR.	Closet Clear	OD. OFF.	Outside Dimension Office
SHOWN ON SHEET	CMU.	Concrete Block	OPNG.	Opening
SECTION INDICATOR	CO. COL.	Cased Opening Column	OPP. PL.	Opposite Plate
FOR PARTIAL	CONC.	Concrete	PLAM.	Plastic Laminate
BUILDING  SECTION	CONN. CONSTR.	Connect Construction	PLAS. PLYWD.	Plaster Plywood
INDICATOR	CONT. CORR.	Continue Corrugated	PNT. PR.	Paint Pair
FOR BUILDING	C.PT.	Carpet	PRCST.	Pre-cast
© DETAIL	C.SK. C.TOP	Countersunk Countertop	PT. P.T.	Point Pressure Treated
INDICATOR	CTR.	Center	PTD.	Paper Towel Dispenser
© DETAIL	CT. DBL.	Ceramic Tile Double	PTDR. PTN.	Paper Towel Dispenser & Receptacle Partition
INDICATOR	DEPT. DET.	Department Detail	PTR. QT.	Paper Towel Receptacle Quarry Tile
Δ	DF.	Drinking Fountain	R.	Radius
CUT LINE	DIA. DIM.	Diameter Dimension	R. R&S.	Riser Clothes Rod & Shelf
	DISP.	Dispenser	RD. REF.	Roof Drain Reference
ELEVATION INDICATOR	DN. DR. OPNG.	Down Door Opening	REFRIG.	Refrigerator
	DR. DS.	Door Downspout	REG. REINF.	Register Reinforced
INTERIOR D (A-000) B ELEVATION	DSP.	Dry Standpipe	REQD.	Required
INDICATOR	DWG. DWGS.	Drawing Drawings	RESIL. RRT.	Resilient Radial Rubber Tile
AAAAA	DWR. E.	Drawer East	RM. RO.	Room Rough Opening
LEADERS	EA.	Each	RVS.	Reversed
CC CC	EJ. EL.	Expansion Joint Elevation	RWD. RWL.	Redwood Rain Water Leader
FIRE RATED	ELEC.	Electric	S.	South Solid Core
WALLS  4 HR	ELEV. EMER.	Elevator Emergency	SC. SCD.	Seat Cover Dispenser
MATCH LINE MATCHINE	ENCL. EPB.	Enclosure Electrical Panelboard	SCHED. SD.	Schedule Soap Dispenser
MATCH LINE	EQ.	Equal	SECT.	Section
REVISION	EQUIP. EWC.	Equipment Electric Water Cooler	SH. SHR.	Shelf Shower
CLOUD	EXIST. EXP.	Existing Exposed	SHT. SIM.	Sheet Similar
ROOM	EXPAN.	Expansion	SND.	Sanitary Napkin Dispenser
INDENTIFIER W/ ROOM	EXT. FA.	Exterior Fire Alarm	SNR. SPEC.	Sanitary Napkin Receptacle Specification
NAME	FB.	Flat Bar	SQ. SER. S.	Square Service Sink
& NUMBER	FD. FDTN.	Floor Drain Foundation	SS.	Stainless Steel
FIRST FLOOR ELEVATION MARK	FE. FEC.	Fire Extinguisher Fire Extinguisher Cabinet	STA. STD.	Station Standard
	FHC.	Fire Hose Cabinet	STL.	Steel
(1) LOUVER TYPE	FIN. FL.	Finish Flush	STOR. STRUCT.	Storage Structural
	FLASH. FLR.	Flashing Floor	SUSP. SYMM.	Suspended Symmetrical
TOILET ACCESSORY	FLG.	Flooring	SV.	Sheet Vinyl
IDENTIFICATION	FLUOR. FOC.	Fluorescent Face of Concrete	T. TB.	Tread Towel Bar
† 16'-1 1/16" † <b>DIMENSION</b>	FOF.	Face of Finish	TEL.	Telephone
DIMENSION	FOS. FP.	Face of Studs Fireproof	TER. T&G.	Terrazzo Tongue and Groove
	FR. FR.	Frame Fire Rated	THK. TMPD.	Thickness Tempered
NORTH ARROW	FS.	Full Size	TOC.	Top of Curb
INDICATOR	FT. FTG.	Foot or Feet Footing F	TOP. TOW.	Top of Pavement Top of Wall
	FURG.	urring	TPD.	Toilet Paper Dispenser
	FUT. G.	Future Ground	TV. TYP.	Television Typical
	GA. GALV.	Gage Galvanized	UNFIN. UON.	Unfinished Unless Otherwise Noted
	GB.	Grab Bar	UR.	Urinal
	GL. GR.	Glass Grade	V. VB.	Vinyl Base
	GWB.	Gypsum Wall Board	VEP.	Vitreous Enamel Paint
	GYB. HB.	Gypsum Hose Bibb	VERT. VEST.	Vertical Vestibule
	HC. HDW.	Hollow Core Hardware	W. W/	West With
	HDWD.	Hardwood	WC.	Water Closet
	HM. HORIZ	Hollow Metal	WD. WGI	Wood Wired Glass

Inside Diameter

Insulation

Interior

INSUL.

INT.

Waterproof

Wainscot Weight

WSCT.

## BUILDING A DRAWING LIST

DIV	WING LIGI		
		PLUMBIN	IG:
G-001	COVER SHEET	P-001	PLUMBING SCHEDULES LEGENDS & NOTES
G-002	ABBREVIATIONS, SYMBOLS & DRAWING LIST	P-101	BUILDING A FIRST FLOOR PLAN- PLUMBING
G-003	PROJECT DATA	P-102	BUILDING A SECOND FLOOR PLAN- PLUMBING
G-004	CODE REVIEW- BUILDING A	P-103	BUILDING A THIRD FLOOR PLAN- PLUMBING
			BUILDING A ROOF PLAN- PLUMBING
G-005	LIMIT OF WORK - BUILDING B	P-104	
		P-201	TYPICAL UNIT PLANS BUILDING A - PLUMBING
EX-1	EXISTING CONDITIONS SURVEY	P-202	TYPICAL UNIT PLANS BUILDING A - PLUMBING
EX-2	EXISTING CONDITIONS SURVEY	P-203	TYPICAL UNIT PLANS BUILDING A - PLUMBING
EX-3	EXISTING CONDITIONS SURVEY	P-301	PLUMBING DETAILS
		P-401	PLUMBING RISER DETAILS
GEOTEC	HNICAL:		
GT1.0	PASSIVE SUB SLAB VENTILATION SYSTEM BUILDING A		
		FIRE PRO	OTECTION:
CIVIL:		FP-000	FIRE PROTECTION NOTES, SCHEDULES AND LEGENDS
C1.1	SITE STORM AND SANITARY SEWER PLAN	FP-101	BUILDING A FIRST FLOOR PLAN- FIRE PROTECTION
C2.1	SITE UTILITY PLAN	FP-102	BUILDING A SECOND FLOOR PLAN- FIRE PROTECTION
		FP-102	BUILDING A SECOND FEORE FLAN- FIRE PROTECTION
C3.1	SITE SOIL EROSION AND SEDIMENT CONTROL PLAN		
C3.2	SOIL EROSION AND SEDIMENT CONTROL	FP-200	FIRE PROTECTION DETAILS
	NARRATIVE AND DETAILS		
C4.1	STORM DRAINAGE DETAILS	MECHAN	
C4.2	STORM AND SANITARY DETAILS	H-001	HVAC LEGEND AND SCHEDULES
C4.3	INFILTRATION SYSTEM DETAILS	H-101	BUILDING A FIRST FLOOR PLAN- HVAC
C4.4	UTILITY DETAILS	H-102	BUILDING A SECOND FLOOR PLAN- HVAC
C4.5	WATER SERVICE DETAILS	H-103	BUILDING A THIRD FLOOR PLAN- HVAC
		H-104	BUILDING A ROOF PLAN- HVAC
LANDSC	APF.	H-201	TYPICAL UNIT PLANS BUILDING A - HVAC
L-1.0	SITE PLAN	H-202	TYPICAL UNIT PLANS BUILDING A - HVAC
		H-203	TYPICAL UNIT PLANS BUILDING A - HVAC
L-2.0	GRADING PLAN		
L-3.0	PLANTING PLAN	H-301	HVAC DETAILS
L-4.0	LIGHTING PLAN	H-302	HVAC DETAILS
L-5.0	DETAILS		
L-5.1	DETAILS	ELECTRI	
L-5.2	DETAILS	E-001	ELECTRICAL LEGEND AND NOTES
		E-002	ELECTRICAL GENERAL NOTES
ARCHITE	ECTURAL:	E-003	ELECTRICAL SCHEDULES
A-101	BUILDING A FLOOR PLANS	E-101	BUILDING A FIRST FLOOR PLANS- ELECTRICAL
A-102	BUILDING A FIRST FLOOR PLAN	E-102	BUILDING A SECOND FLOOR PLAN- ELECTRICAL
A-103	BUILDING A SECOND FLOOR PLAN	E-103	BUILDING A THIRD FLOOR PLAN- ELECTRICAL
A-103	BUILDING A THIRD FLOOR PLAN	E-104	BUILDING A ROOF PLAN- ELECTRICAL
		E-200	SITE LIGHTING PLAN - ELECTRICAL
A-105	BUILDING A ROOF PLAN		
A-201	BUILDING A CECTIONS	E-201	TYPICAL UNIT PLANS BUILDING A - ELECTRICAL
A-301	BUILDING A SECTION	E-202	TYPICAL UNIT PLANS BUILDING A - ELECTRICAL
A-302	COMPARTMENT-ALIZATION PLAN	E-203	TYPICAL UNIT PLANS BUILDING A - ELECTRICAL
A-401	WALL SECTIONS, BUILDING A	E-301	BUILDING A ROOF PLAN- LIGHTING PROTECTION
A-402	WALL SECTIONS, BUILDING A	E-401	ELECTRICAL RISER DIAGRAM (BUILDING A)
A-403	WALL SECTIONS, BUILDING A	E-402	TELEPHONE AND CABLE RISER DIAGRAMS
A-404	WALL SECTIONS, BUILDING A	E-403	ELECTRICAL RISER DIAGRAMS
A-501	TYPICAL UNIT PLANS BUILDING A	E-501	BUILDING A ELECTRICAL PANELBOARD SCHEDULES
A-502	TYPICAL UNIT PLANS BUILDING A	E-601	ELECTRICAL DETAILS
A-503	TYPICAL UNIT REFLECTED CEILING PLANS BUILDING A	E-602	ELECTRICAL DETAILS
A-504	TYPICAL UNIT REFLECTED CEILING PLANS BUILDING A		
A-505	KITCHEN ENLARGED PLANS & ELEVATIONS		
A-506	KITCHEN DETAILS		
A-507	BATH ENLARGED PLANS & ELEVATIONS		
A-507 A-508	BATH ENLARGED PLANS & ELEVATIONS  BATH ENLARGED PLANS & ELEVATIONS		
A-509	BATH DETAILS		
A-510	BATH DETAILS		
A-601	TOWNHOUSE INT. UNIT STAIRS PLANS, SECTIONS & DETAILS		
A-602	EXTERIOR STAIRS		
A-701	EXTERIOR DETAILS		
A-702	PLAN DETAILS		
A-703	ROOF DETAILS		
A-801	WINDOW SCHEDULE		
A-802	WINDOW DETAILS		
A-803	WINDOW FLASHING PROCEDURE		
A-804	DOOR SCHEDULE		
A-805	INTERIOR DOOR DETAILS		
A-806	EXTERIOR DOOR DETAILS		
A-807	FINISH SCHEDULE		
A-808	PARTITION TYPES		
STRUCT			
S-001	GENERAL NOTES		
S-101	FOUNDATION/ FIRST FLOOR PLAN		

FOUNDATION/ FIRST FLOOR PLAN

SECOND FLOOR FRAMING PLAN

THIRD FLOOR FRAMING PLAN

ATTIC/ROOF FRAMING PLAN

TYPICAL DETAILS

SECTIONS

S-101

S-300

## Washington Village Phase 1

### 13 Day Street Building A

Norwalk, CT

Trinity Washington Village Limited Partnership & the Norwalk Housing Authority



101 SUMMER ST BOSTON MA 02110 617-451-3333 www.iconarch.com

CONSULTANT

STAMP



09-15-2014 PERMIT/ PRICING 06-13-2014 PRICING 11-18-2013 40% CHFA

MARK DATE DESCRIPTION

PROJECT NO.: 21222
DRAWN BY: RA, AF,KH, SO, BD
CHECKED BY:

SHEET TITLE

ABBREVIATIONS, SYMBOLS & DRAWING LIST

G-002

<b>UNIT MIX SUMMARY</b>		Unit Mix								
Phase 1		1BR	2 BR	3 BR	4 BR	Building Total				
Parcel 1: 13 Day Street	Building A		3	3	4	10				
Parcel 2: 20 Day Street	Building B	27	38	5		70				
	Subtotal Phase 1	27	41	8		80				
		34%	53%	9%	5%	100%				

### **ZONING ANALYSIS**

	Dimensional Requirements	Required/Allowed by Zoning	Required	Proposed
Height	Maximum	5 stories & 60 ft above base flood level for multifamily & mixed use developments which provide a minimum of thirty percent (30%) affordable housing in accordance with Section 8-30g of the Connecticut General Statutes, provided that a minimum of ten percent (10%) the total number of units shall comply with §118-1050 Workforce Housing Regulation		3 Stories and 38 Ft. above Base Flood Leve
	Area	5,000 SF		18,792 SF
Plot Size				19,562 Sq. Ft 407 Sq. Ft. (Parcel Y) - 363 Sq. F (Sidewalk Area)
	Width	50'		Greater than 50'
Yards	Front	35 feet min. from centerline. Subject to Sect 118-1000B; except for multifamily and mixed use developments which shall be located not more than ten (10) feet from property line, subject to 118-700 C.(6)	50% of the façade length shall be located within 10' of property line.	53% of Day Street; 1009 of Hanford Place
	Side Aggregate Side	None for Multifamily Developments  None for Multifamily Developments		~ ~
	Rear  Maximum Building Area	None for Multifamily Developments  None for Multifamily Developments		~
	Floor Area Ratio, Maximum	2.00 for Multifamily and mixed-use developments		17,021 Building A GSF/ 18,792 SF Plot Size SF = <b>0.91 FAR</b>
	Recreation Area per DU	150 SF per dwelling unit, may include balconies, courtyards, indoor recreational facilities, landscaped roofs and outdoor recreation areas	10 DU @ 150 Ea. = 1,500 SF	2,000± SF
	Residential Density	1,650 sq ft of lot area per dwelling unit, subject to §118-1050; 800 sq ft of lot area per dwelling unit for multifamily developments which provide a minimum of thirty percent (30%) affordable housing in accordance with Section 8-30g of the Connecticut General Statutes, provided that a minimum of ten percent (10%) the total number of units shall comply with §118-1050 Workforce Housing Regulation 1,650 sf of lot area per dwelling	18,792 SF Plot Size/ 1,650 SF per unit= 11.4 units	10

Parcel 1 Parking		Required # of Spaces	Proposed # of Spaces
2 Spaces per 2 Bedroom or larger	10 units	20	20

### **UNIT SIZE MATRIX**

SF UNIT			age P	1100	<b>y</b> . •	7 8 11 6	- Traci	17																					ON architecture in
						- All Santago de																							
uilding A		T		<del></del>	1BR											2BR								3BF	₹		4BR		
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lding B				1BR												2BR												~ \$	
J	Α		В		С		D		F		Е	F		G		2BR	T	M		X	<u> </u>	A-DUP	11	3BR		TH-K	4BR A-TH		
	B105 B206 B306	768 768 768	B201 B221 B301 B324 B401	671 730 671 324 671	B316 B317 B318 B404 B405	880 879 880 858 858	B103 B109 B110 B113 B204 B210 B211 B214 B304 B311 B314 B315	768 754 769 1,005 768 771 768 770 784 783 1,022		84 B101 77 B102 B104 B104 B111 B112 B114 B202 B203 B205 B212 B213 B215 B218 B219 B220 B303 B305 B312 B303 B305 B312 B313 B321 B322 B313 B321 B322 B323 B402 B407 B408 B409	1,006 1,005 1,005 1,076 1,076 1,005 1,005 1,005 1,075 1,075 1,022 1,024 994 973 1,006 1,005 1,075 1,075 1,005 1,005 1,005 1,005 1,005 1,005 1,005	B216 B319	1,195 1,194	B208 B308 B309	1,153 1,153 1,156		1,156 1,156 1,167	B207	1,174	B403 S			B107 1,15	3 B106 1,		B115 1,690 B116 1,690 B117 1,690			
otal rage		2,304		3,067		4,355		10,533	1,	'61 '86	27,467		2,389		3,462		3,479		1,174	(	970	0	1,15	3 1,2	250	7,473		0	TOTAL UNIT N 70,8
Count		·····								28									······································			1,052 37			····	1,495 5		0	
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ge Unit										86												974				4 027		4 900	1.0
otal									35.0													50.00%				1,827 10.00%		1,809 5.00%	<b>1,0</b> 100.0

## **BUILDING GROSS & NET SF**

11-Sep-14

Parcel 1: 13 Day Street Building A

Parcel 2: 20 Day Street Building B

	Bu	ilding GSF <sub>l</sub>	per Floor Leve	el	
Parking Level	First Floor*	Second Floor	Third Floor	Fourth Floor*	Entry Level Access
	6,049	5,959	5,013		
19,286	29,545	26,453	26,463	11,513	275

Bldg NET

Total Phase 1 GSF\*

Bldg GSF

Bldg NET 15,615

Bldg GSF 94,249

Bldg NET 68,154

GSF\* 111,270

NET 83,769

**Building Total (Not** 

including parking)

17,021

\* Includes Management and Amenity Space

## Washington Village Phase 1

### 13 Day Street Building A

Norwalk, CT


Trinity Washington Village Limited Partnership & the Norwalk Housing Authority



101 SUMMER ST BOSTON MA 02110

CONSULTANT

STAMP

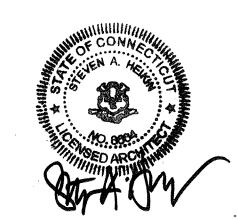

PROJECT NO.: 21222
DRAWN BY: KH,GA,RA
CHECKED BY:

SHEET TITLE

PROJECT DATA

G-003

## CODE REVIEW PARCEL 1 - 13 DAY STREET - BUILDING A

CODE REVIEW
Location: Norwalk, CT
Code: 2003 IBC Portion of the 2005
State Building Code State of Connecticut

ode Requirement	Low-Rise – 3 stories
	Washington Village will be designed to the following: 2003 International Building Code Portion of the 2005 State Building Code State of Connecticut; ADA 2010; Fair Housing Act (FHA) 1991 (FHADM 1998 – FHA Design Guidelines); ICC/ANSI A117.1-2003 Accessible and Usable Buildings and Facilities Manual; 2009 International Energy
eneral Requirements	Conservation Code; and applicable City and Zoning Regulations.
inciple Use hapter 3, Sections 310.1): pe of Construction hapter 6, Section 601):	R-2: Residential  Group R-2: Type VA, Combustible, Protected
eneral Building Height & Area	Chapter 5
eneral Height Limitation able 503)	Allowable: R-2: 3 stories, 50 feet (3 stories + 1 story per Section 504.2)
tomatic Sprinkler Increase ection 504.2)	Proposed: R-2: 3 Stories (29 feet)
oor Area Limitation able 503)	Allowable: R-2: 12,000 SF
	<b>Proposed:</b> R-2: 5,150 SF
tomatic Sprinkler System eight Increase ection 504.2)	<ul> <li>For Group R buildings equipped throughout with an approved automatic sprinkler system in accordance with Section 903.3.1.2 (NFPA 13R), the value specified in Table 503 for maximum height is increased by 20 feet, and maximum number of stories is increased by one story, but shall not exceed four stories or 60 feet.</li> </ul>
	Allowable: R-2: 4 stories (60 feet)  Proposed:
	R-2: 3 stories (29 feet)
enstruction Types e Rating of Elements able 601):	Chapter 6 R-2 Occupancies
mary Structural Frame, luding columns able 601)	1 hour
terior Walls: Load Bearing able 601)	1 hour
terior Walls: Non-Bearing feet separation	1 hour
able 602) terior Walls: Non-Bearing	1 hour
feet < to 10 feet separation able 602)	
terior Walls: Non-Bearing 0 feet < to 30 feet separation	1 hour
able 602) erior Walls: Load Bearing	1 hour
ner Non-bearing partitions	0 hours, but not less than fire resistance rating required by other sections of the code
or Construction: Secondary	1 hour
mbers of Construction and Secondary	1 hour
mbers	1 hour
elling unit demising walls ction 708.3)	Not less than 1 hour
rizontal Floor Separations ection 711.3)	Not less than that required by Table 302.3.2.  Note: Floor assemblies separating dwelling units in the same building shall be a minimum 1 hour fire resistance rated construction.
e and Smoke Protection atures	Chapter 7
e Rating of Shaft Enclosures ection 707.4)	Fire-resistance rating for shaft enclosures shall not be less than 2 hours when connecting 4 or more stories.
afts connecting < 4 stories afts connecting > 4 stories	Not less than 1 hour Not less than 2 hours
e Partitions ction 708) rizontal Assemblies ction 712.3)	
e Partitions (between dwelling ts)	Not less than 1 hour (Section 708.3)
rizontal Assemblies (between elling units)	1 hour minimum, but not less than penetrations (section 711.3)
oke Barriers ction 709.3)	1 hour
oke Partitions ction 710.3)	Unless required elsewehere in the Code, smoke partitions are not required to have a fire-resistance rating
Protection Systems	Chapter 9
inkler System ction 903.3.1.2)	In accordance with NFPA 13R
omatic Fire Alarm & Detection	Manual Fire Alarm systems shall be installed in Group R-2 occupancies where:  1. Any dwelling unit located 3 or more stories above the level of exit discharge
pup R-2 ction 907.2.9)	2. Any dwelling unit located more than 1-story below level of exit discharge     3. Building contains more then 11 dwelling units     Exceptions:
	2. Manual fire alarm boxes not required throughout when following conditions met: a. Building is equipped throughout with automatic sprinkler system in accordance with Section 903.3.1.2 (NFPA 13R)
	b. Notification appliances activate upon sprinkler flow c. At least 1 fire alarm box is installed in approved location
	3. A fire alarm system is not required in buildings that do not have interior corridors serving dwelling units and are protected by an approved automatic sprinkler system in accordance with Section 903.3.1.2 (NFPA 13R)
gle & Multiple Station Smoke rms (Where Required) ction 907.2.10.1.2)	Shall be installed in accordance with NFPA 72     Installed outside each sleeping area or bedroom on wall or ceiling     Installed within each room used for sleeping purposes
m Notification Appliances	All dwelling units within Group R-2 shall be provided with the capability to support
ction 907.9.1.4)	visible visible alarm notification appliance in accordance with ICC A117.1
kimum Floor Area allowed per eupant	Chapter 10  Refer to Table 1004.1.2  Use Group R-2: 200 gross
imum Ceiling Height ction 1003.2)	Minimum ceiling height for means of egress shall be 7'-6"     Exceptions:     1. Sloped ceilings in accordance with Section 1208.2     2. Duelling unit ceilings within Period with a section 1208.2
acity of Egress Components	2. Dwelling unit ceilings within Residential units per Section 1208.2  3. Stair headroom in accordance 1009.2  • Stairways: 0.3 in. per person with sprinklers  • Doors, corridors and ramps: 0.2 in. per person with sprinklers
ess Doors Capacity	Doors, corridors and ramps: 0.2 in. per person with sprinklers  Minimum width of egress doors: 32 inches  Minimum height of egress doors: 80 inches
ction 1008.1.1)	Not less than 44 inches for non accessible means of egress
ction 1008.1.1)	THE INDUSTRIAL TO DISCUSS OF THE METERS OF MATERIAL OF MATERIAL TO SERVICE OF THE PROPERTY OF
imum stairway width ction 1009.1)	Not less than 44 inches for accessible means of egress Not less than 48 inches for accessible means of egress (Section 1007.3)  Exception:  1. Stairways serving an occupant load of 50 or less shall have a width of not less than 36 inches.
mum stairway width	Not less than 48 inches for accessible means of egress (Section 1007.3)     Exception:     1. Stairways serving an occupant load of 50 or less shall have a width of not less than

Riser height and tread depth (Section 1009.3)	<ul> <li>Stair risers:7 inches maximum, 4 inches minimum</li> <li>Stair treads: 11 inches minimum</li> <li>Exception #4:</li> <li>Within dwelling units in occupancies in Group R-2, the maximum riser height be 8-1/4 inches, and minium tread depth shall be 9 inches.</li> <li>A nosing not less than 3/4 inch but not more than 1-1/4 inches shall be provid stairways with solid risers where the tread depth is less than 11 inches.</li> </ul>
Stairway Landings (Section 1009.4)	Not less than required width of stair, can not reduce egress width
Vertical Rise (Section 1009.6) Handrails	Flight of stairs shall be nise no greater than 12 feet between floor levels  Common Stair:
(Section 1009.11)	Continuous both sides  May project 3½ inches into required stairway width
	Not less than 34 inches / no more than 38 inches above nosing Diameter no less than 1¼ inches, no greater than 2 inches
	Exception #2: Stairways within dwelling units are permitted to have a handrail on only one sid
Handrail Extensions	stair.      Handrails shall return to a wall, guard or the walking surface or shall be conting.
(Section 1009.11.5)	the handrail of an adjacent flight.  • Where handrails are not coninuous between flights, handrails shall extend
	horizontally in accordance with the following:  o 12 inches beyond top riser
	<ul> <li>12 inches + depth of tread beyond bottom riser</li> <li>Exception #1:</li> <li>Handrails within a dwelling unit that is not required to be accessible need extended.</li> </ul>
	from the top riser to the bottom riser.
Guardrails (Section 1012)	Maximum 42 inches high (Section 1012.2)     Exception #1:
	For occupancies in Group R-3, and within individual dwelling units in occupancie Group R-2, guards whose top rail also serves as a handrail shall have a height less than 34 inches and not more than 38 inches measured vertically from the le
	edge of the stair tread nosing.
Number of Exits Required (Table 1018.1)	• 2 independent means of egress for 500 or less occupants
Accessibility Accessible Route Multi-Level	Chapter 11 At least one (1) accessible route shall connect each accessible level, including
Buildings (Section 1104.4) Parking & Passenger Loading	mezzanines, in multilevel buildings and facilities.  Where parking is provided, accessible parking spaces shall be provided in comparish Table 4400 4 The
Facilities (Section 1106.1 & Table 1106.1)	with Table 1106.1. The number accessible parking spaces shall be determined total number spaces provided  Proposed Parking Spaces: 16 surface
	Required Accessible Spaces: 1, which shall be van-accessible, per Section 1
Accessible Parking Spaces (Section 1106.1.1)	Pursuant to subsection (h) of section 14-253a of Connecticut General Statutes, parking spaces shall be as near as possible to building entrance, and
	• 15 feet wide, including 5 feet of cross hatch.  Cross-hatched portions shall not be shared between spaces.
Parking for Groups R-2 & R-3 (Section 1106.2)	Two per cent (2%), but not less than once of each type of parking space provide occupancies R-2 and R-3, which are required to have Accessible, Type A or Type dwelling units shall be accessible.
Van Spaces	dwelling units shall be accessible.  For every six or fraction of six accessible parking spaces, at least one shall be a
(Section 1106.5)  Van Accessible Parking Spaces	accessible parking space.  Pursuant to subsection (h) of section 14-253a of Connecticut General Statutes,
(Section 1106.5.1)	parking spaces for passenger vans designated for the handicapped shall be as as possible to building entrance, and
	16 feet wide, including 8 feet of cross hatch.  Cross-hatched portions shall not be shared between spaces.
Dwelling/Sleeping Units (Section 1107.6.2; 1107.6.2.1.1;	Group R-2 Accessible Units  Type A & Type B units shall be provided
1107.6.2.1.2)	• 10%, not less than one of the total number of units shall be Type A in accordar with ICC/ANSI A117.1-2003. Type A units shall be dispersed among the various
	types  • Where 4 or more dwelling units in a single structure, every dwelling unit intended
	be occupied as a residence shall be Type B units in accordance with ICC/ANSI A117.1-2003
	Note: All R-2 units on the site, within the building or within the complex, shall be considered to determine the total number of units and the required number of Ty units. Type A units shall be dispensed among the various classes of units.
	Proposed # of Units: 80 Units total (10 units in building)
	Type A Units Required: 10 units to be provided in multi-unit building Type B Units Required: 70 units
	Exception 1 (1106.6.2.1.1): The number of Type A units is permitted to be reduced accordance with Section 1107.7.5
Design Flood Elevation (Section 1107.7.5)	The required number of Type A & Type B units shall not apply to a site where the lowest floor of the lowest structural building members of non-elevator buildings a
	required to be at or above the design flood elevation resulting in:  1. A difference in elevation between the minimum required floor elevation
	primary entrances and vehicular & pedestrian arrival points within 50 fe exceeding 30 inches, and
	<ol> <li>A slope exceeding 10 percent between the minimum required floor elev at the primary entrances &amp; vehicular and pedestrian arrival points within feet.</li> </ol>
Interior Environment	Chapter 12
Natural Ventilation (Section 1203.4) Ventilation area requied	Natural Ventilation shall be through windows, doors, louvers or other openings to outdoors.  Minimum openable area to the outdoors shall be 4% of the floor area being ventiled.
(Section 1203.4.1) Contaminants Exhausted	Contaminant sources in naturally ventilated spaces shall be removed in accord
(Section 1203.4.2 & 1203.4.2.1)	with International Mechanical Code & International Fire Code  Bathrooms shall be mechanically ventilated to the outdoors in accordance with International Mechanical Code.
Natural Light (Section 1205.1 & 1205.2)	Minimum net glazed area shall not be les than 8% of floor area of room served     Operable windows or windows that can be cleared by firefighters
Artificial Light (Section 1205.3)	<ul> <li>Area not less than 40 SF for 50 linear feet of perimeter (Sections 403.1 to 403.1</li> <li>An average illumination of 10 foot-candles (107 lux) over the area of the room at</li> </ul>
Emergency Egress Lighting (Section 1205.5	height of 30 inches A.F.F.  Means of egress lighting shall be illuminated in accordance with Section 1006.1  •Means of egress lighting, including exit discharge shall be illuminated at all time
	<ul> <li>building space served by the means of egress is occupied</li> <li>Means of egress illumination level shall not be less than 1 foot candle (11 lux)</li> </ul>
Air-borne Sound Transmission	floor level (Section 1006.2)  Not less than 50 (45 field-tested) STC rating
(Sections 1207.2) Structure-borne Sound Transmission (Section 1207.3)	Not less than 50 (45 field-tested) IIC (impact insulation class) rating
Minimum room dimensions	Minimum width of habitable space, except kitchens: 7 feet in any plan dimensio     Kitchens shall have a clear passageway between counters: not less than 36 inc
(Section 1208.1)	
(Section 1208.1) Minimum ceiling heights (Section 1208.2)	Minimum ceiling height of occupiable spaces: 7 feet 6 inches     Minimum ceiling height in corridors, kitchens, baths, laundry: 7 feet
(Section 1208.1) Minimum ceiling heights (Section 1208.2) Room area	Minimum ceiling height of occupiable spaces: 7 feet 6 inches
(Section 1208.1) Minimum ceiling heights (Section 1208.2) Room area (Section 1208.3)  Energry Requirements Climate Zone	Minimum ceiling height of occupiable spaces: 7 feet 6 inches     Minimum ceiling height in corridors, kitchens, baths, laundry: 7 feet     Each dwelling unit shall have at least one room minimum 120 NSF
(Section 1208.1) Minimum ceiling heights (Section 1208.2) Room area (Section 1208.3)  Energry Requirements Climate Zone (Table 301.1) Insulation & Fenestration Criteria	Minimum ceiling height of occupiable spaces: 7 feet 6 inches     Minimum ceiling height in corridors, kitchens, baths, laundry: 7 feet     Each dwelling unit shall have at least one room minimum 120 NSF     All other habitable rooms shall not be less than 70 NSF      2009 Internation Energry Conservation Code     Climate Zone: 5A      The building thermal envelope shall meet the requirements of Table 402.1.1 ba
(Section 1208.1) Minimum ceiling heights (Section 1208.2) Room area (Section 1208.3)  Energry Requirements Climate Zone (Table 301.1) Insulation & Fenestration Criteria (Section 402.1.1) Building Envelope Requirements:	Minimum ceiling height of occupiable spaces: 7 feet 6 inches     Minimum ceiling height in corridors, kitchens, baths, laundry: 7 feet     Each dwelling unit shall have at least one room minimum 120 NSF     All other habitable rooms shall not be less than 70 NSF      2009 Internation Energry Conservation Code     Climate Zone: 5A
(Section 1208.1) Minimum ceiling heights (Section 1208.2) Room area (Section 1208.3)  Energry Requirements Climate Zone (Table 301.1) Insulation & Fenestration Criteria (Section 402.1.1) Building Envelope Requirements: Opague Walls	Minimum ceiling height of occupiable spaces: 7 feet 6 inches     Minimum ceiling height in corridors, kitchens, baths, laundry: 7 feet     Each dwelling unit shall have at least one room minimum 120 NSF     All other habitable rooms shall not be less than 70 NSF  2009 Internation Energry Conservation Code Climate Zone: 5A      The building thermal envelope shall meet the requirements of Table 402.1.1 ba on the climate zone specified in Chapter 3.  Required: Fenestration U-Factor: 0.35
(Section 1208.1) Minimum ceiling heights (Section 1208.2) Room area (Section 1208.3)  Energry Requirements Climate Zone (Table 301.1) Insulation & Fenestration Criteria (Section 402.1.1) Building Envelope Requirements: Opague Walls	Minimum ceiling height of occupiable spaces: 7 feet 6 inches     Minimum ceiling height in corridors, kitchens, baths, laundry: 7 feet     Each dwelling unit shall have at least one room minimum 120 NSF     All other habitable rooms shall not be less than 70 NSF  2009 Internation Energry Conservation Code Climate Zone: 5A      The building thermal envelope shall meet the requirements of Table 402.1.1 ba on the climate zone specified in Chapter 3.  Required:     Fenestration U-Factor: 0.35     Glazed Fenestration SHGC: NR     Ceiling/Roof R-Value: R-38
(Section 1208.1) Minimum ceiling heights (Section 1208.2) Room area (Section 1208.3)  Energry Requirements Climate Zone (Table 301.1) Insulation & Fenestration Criteria (Section 402.1.1)  Building Envelope Requirements: Opague Walls	Minimum ceiling height of occupiable spaces: 7 feet 6 inches     Minimum ceiling height in corridors, kitchens, baths, laundry: 7 feet     Each dwelling unit shall have at least one room minimum 120 NSF     All other habitable rooms shall not be less than 70 NSF  2009 Internation Energry Conservation Code Climate Zone: 5A      The building thermal envelope shall meet the requirements of Table 402.1.1 bas on the climate zone specified in Chapter 3.  Required:     Fenestration U-Factor: 0.35     Glazed Fenestration SHGC: NR     Ceiling/Roof R-Value: R-38     Wood Frame Wall R-Value: R-20 or 13 + 5 (Note h: "13+5" means R-13 cavity insulation with R-5 insulating sheathing)
(Section 1208.1) Minimum ceiling heights	Minimum ceiling height of occupiable spaces: 7 feet 6 inches     Minimum ceiling height in corridors, kitchens, baths, laundry: 7 feet     Each dwelling unit shall have at least one room minimum 120 NSF     All other habitable rooms shall not be less than 70 NSF  2009 Internation Energry Conservation Code Climate Zone: 5A      The building thermal envelope shall meet the requirements of Table 402.1.1 bas on the climate zone specified in Chapter 3.  Required:     Fenestration U-Factor: 0.35     Glazed Fenestration SHGC: NR     Ceiling/Roof R-Value: R-38     Wood Frame Wall R-Value: R-20 or 13 + 5 (Note h: "13+5" means R-13 cavity
(Section 1208.1) Minimum ceiling heights (Section 1208.2) Room area (Section 1208.3)  Energry Requirements Climate Zone (Table 301.1) Insulation & Fenestration Criteria (Section 402.1.1)  Building Envelope Requirements: Opague Walls	Ninimum ceiling height of occupiable spaces: 7 feet 6 inches  Minimum ceiling height in corridors, kitchens, baths, laundry: 7 feet  Each dwelling unit shall have at least one room minimum 120 NSF  All other habitable rooms shall not be less than 70 NSF  2009 Internation Energry Conservation Code  Climate Zone: 5A  The building thermal envelope shall meet the requirements of Table 402.1.1 bas on the climate zone specified in Chapter 3.  Required:  Fenestration U-Factor: 0.35 Glazed Fenestration SHGC: NR Ceiling/Roof R-Value: R-38 Wood Frame Wall R-Value: R-20 or 13 + 5 (Note h: "13+5" means R-13 cavity insulation with R-5 insulating sheathing) Floor R-Value: R-30 (Note g: or insulation to fill the framing cavity, R-19 min.) Slabs R-Value & Depth: R-10 for 24"  Proposed:
(Section 1208.1) Minimum ceiling heights (Section 1208.2) Room area (Section 1208.3)  Energry Requirements Climate Zone (Table 301.1) Insulation & Fenestration Criteria (Section 402.1.1) Building Envelope Requirements: Opague Walls	Minimum ceiling height of occupiable spaces: 7 feet 6 inches     Minimum ceiling height in corridors, kitchens, baths, laundry: 7 feet     Each dwelling unit shall have at least one room minimum 120 NSF     All other habitable rooms shall not be less than 70 NSF  2009 Internation Energry Conservation Code Climate Zone: 5A      The building thermal envelope shall meet the requirements of Table 402.1.1 bas on the climate zone specified in Chapter 3.  Required:     Fenestration U-Factor: 0.35     Glazed Fenestration SHGC: NR     Ceiling/Roof R-Value: R-38     Wood Frame Wall R-Value: R-20 or 13 + 5 (Note h: "13+5" means R-13 cavity insulation with R-5 insulating sheathing)     Floor R-Value: R-30 (Note g: or insulation to fill the framing cavity, R-19 min.)     Slabs R-Value & Depth: R-10 for 24"

## Washington Village Phase 1

### 13 Day Street Building A

Norwalk, CT

Trinity Washington Village Limited Partnership & the Norwalk Housing Authority



101 SUMMER ST BOSTON MA 02110 617-451-3333 www.iconarch.com

CONSULTANT

STAMP



09-15-2014 PERMIT/ PRICING
06-13-2014 PRICING
11-18-2013 40% CHFA
09-19-2013 CAM/ SPECIAL PERMIT
MARK DATE DESCRIPTION


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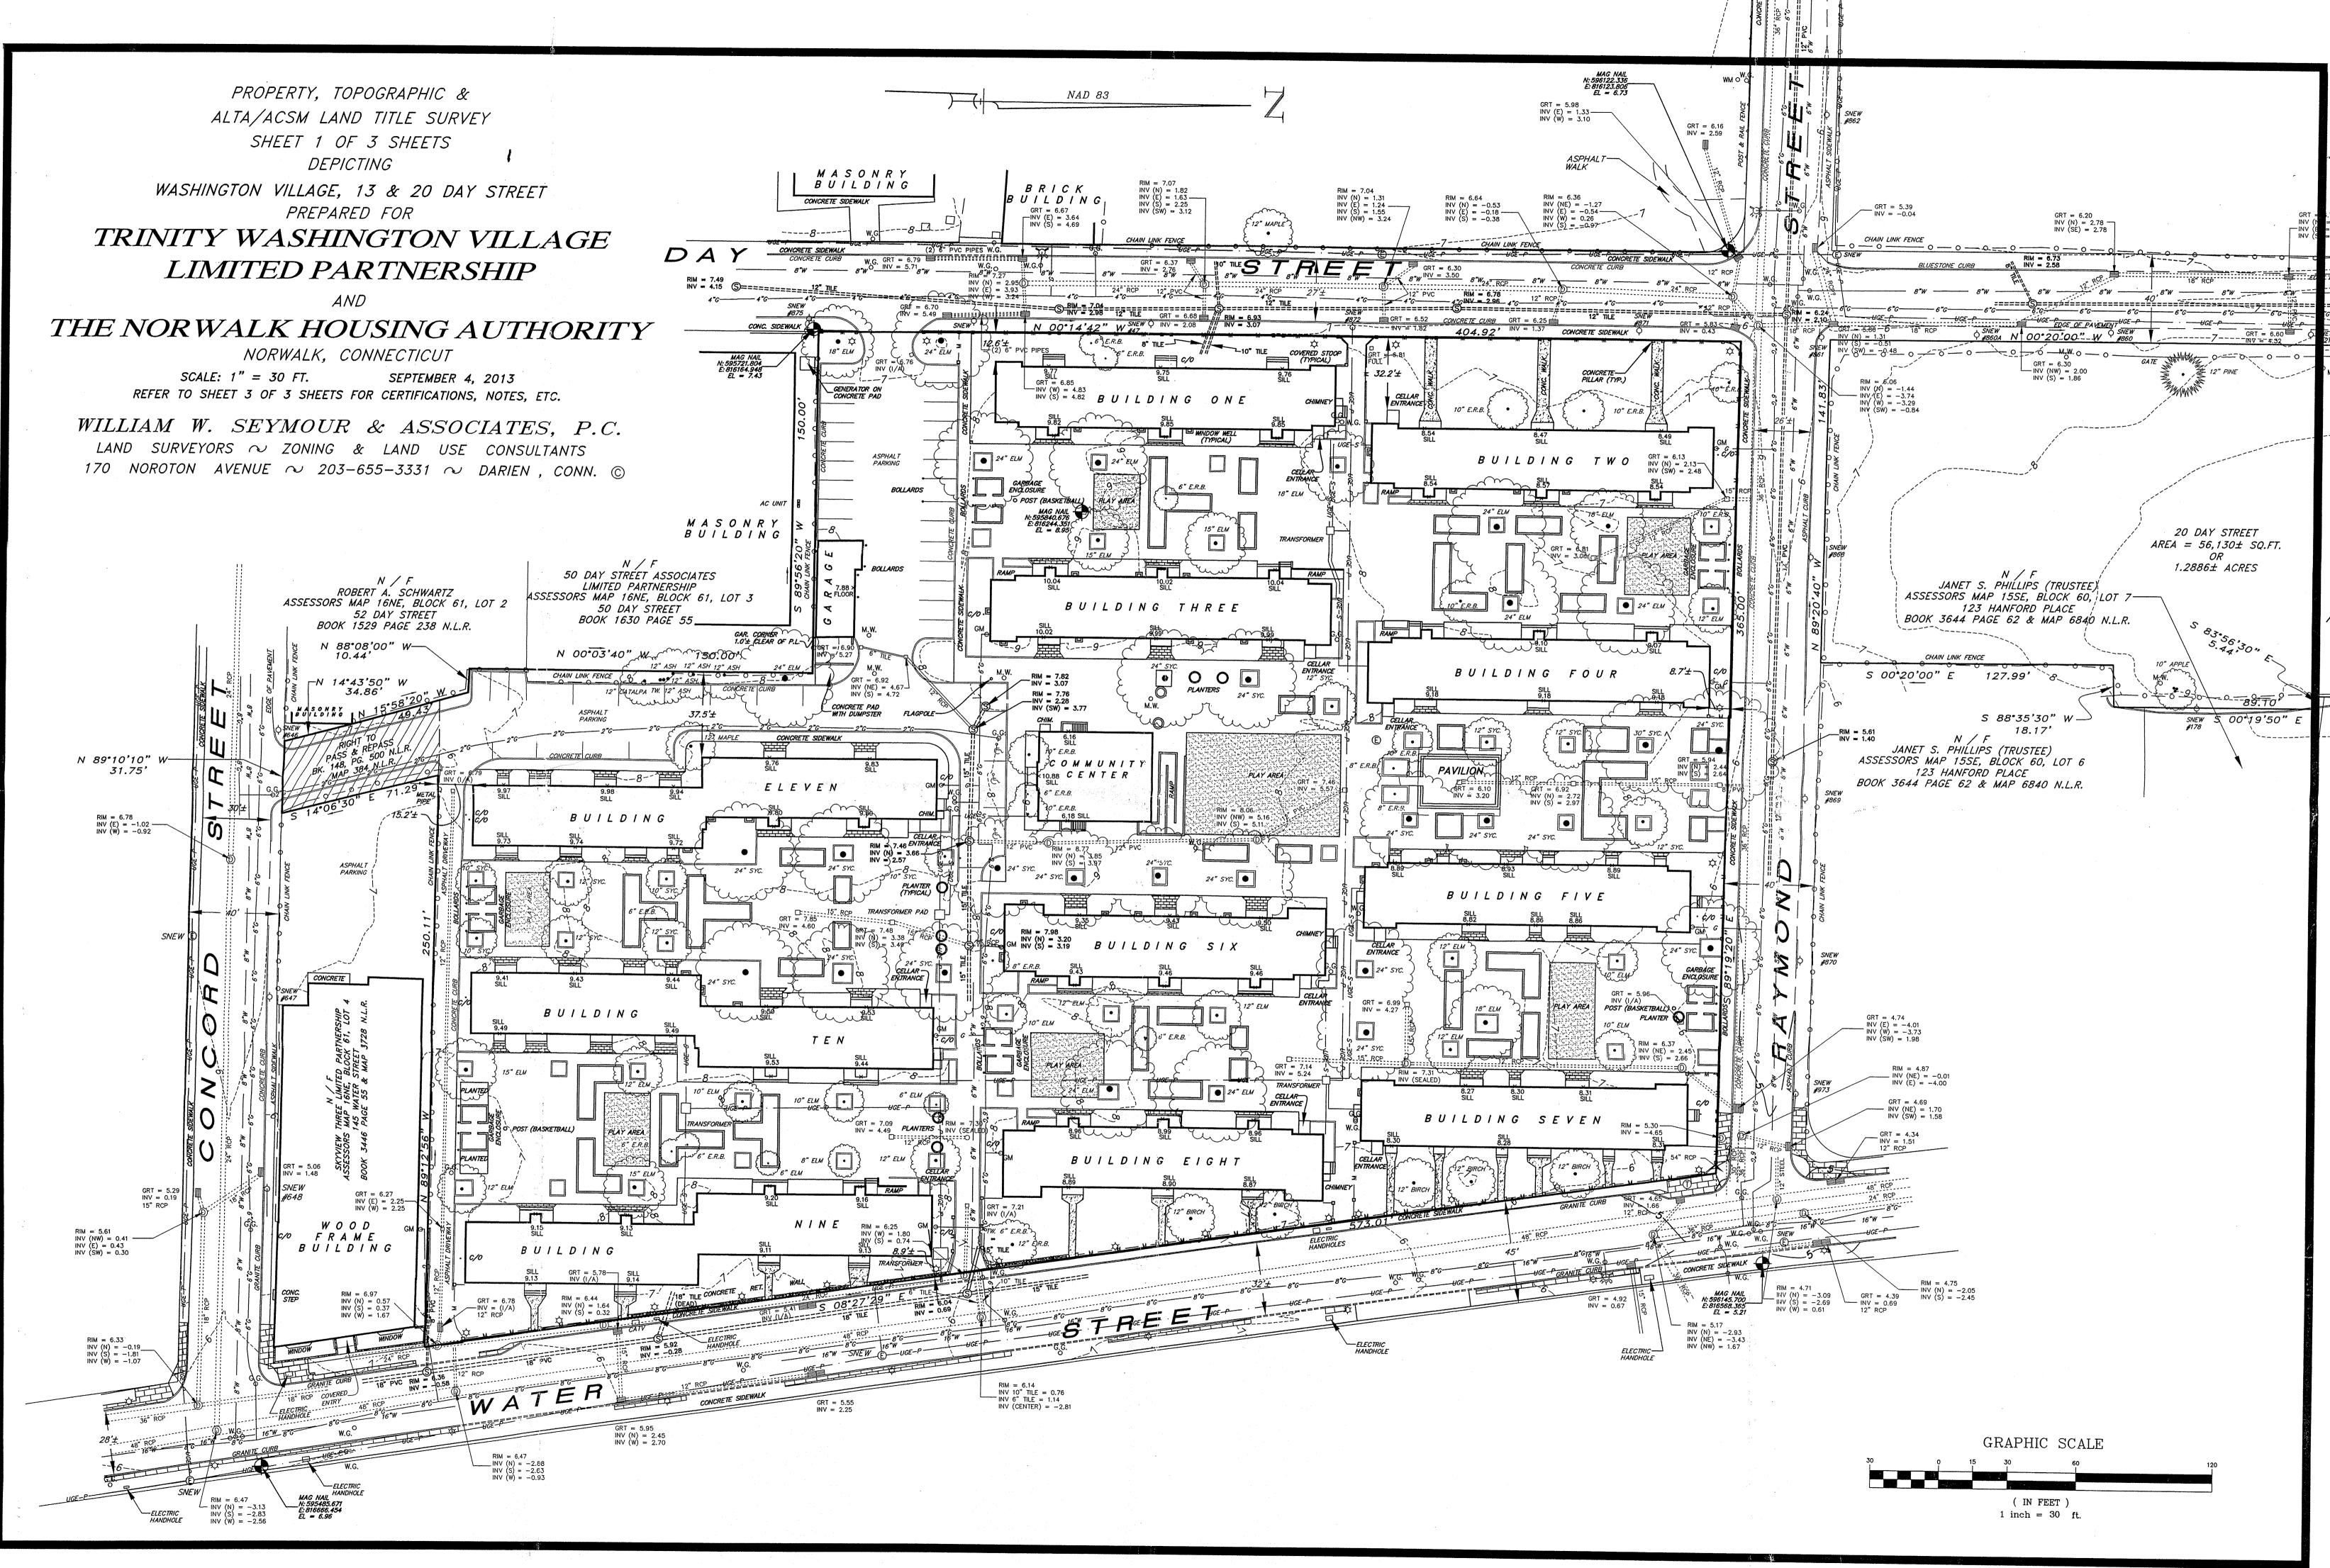
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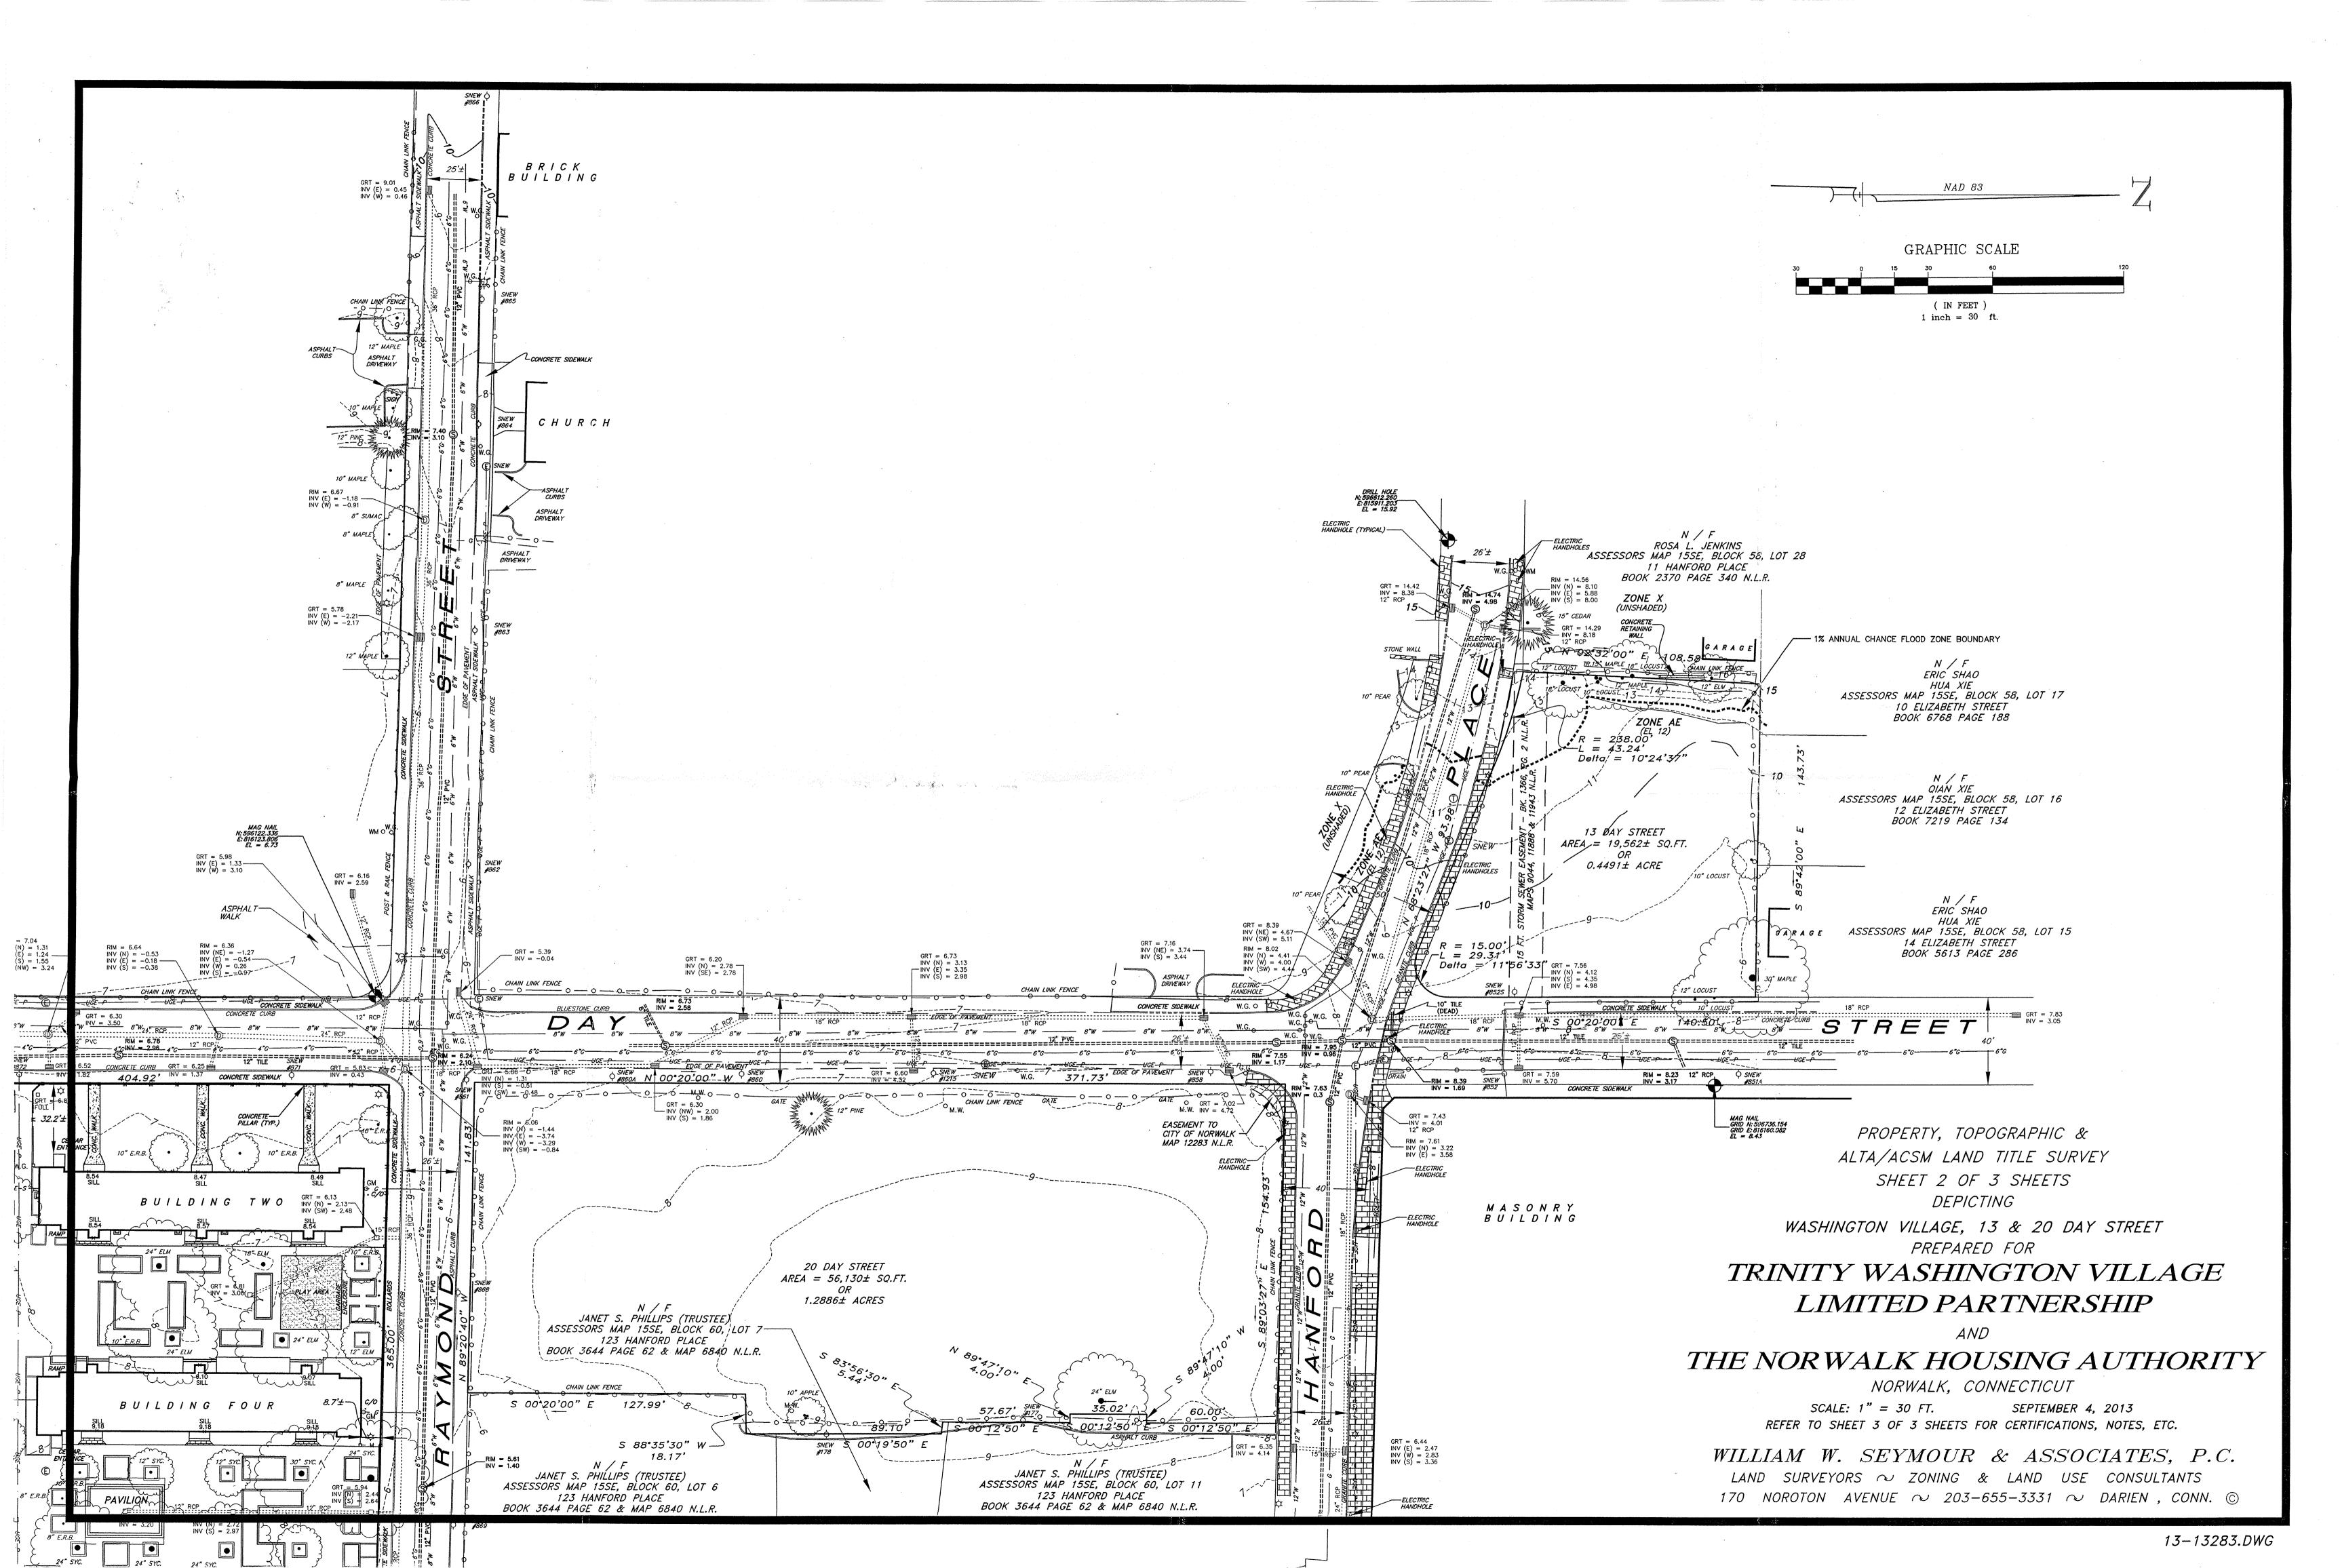
CODE REVIEW -BUILDING A


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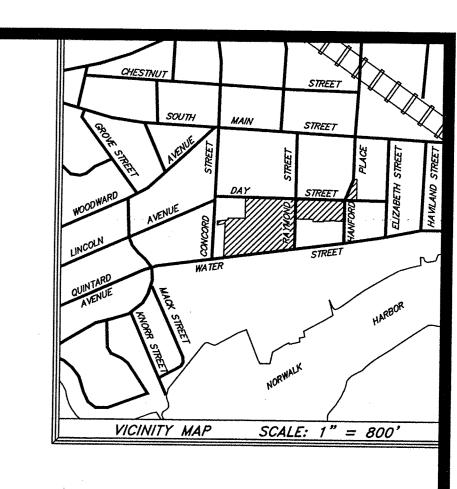
	REQUIRED / ALLOWED	EXISTING	PROPOSED
LOT AREA	5,000 SQ. FT.	207,419± SQ. FT. 4.7617± ACRES	NO CHANGE
LOT WIDTH	50 FT. MIN.	XX.XX FT.	NO CHANGE
FRONT YARD	35 FT. MIN. FROM C.L. SUBJECT TO SECT. 118-100B; EXCEPT FOR MULTIFAMILY AND MIXED USE DEVELOPMENTS WHICH SHALL BE LOCATED NOT MORE THAN TEN (10) FEET FROM PROPERTY LINE, SUBJECT TO 118-700 C (6)	X.X± FT.	
SIDE YARD	NONE EXCEPT WHERE RESIDENCE ZONE ABUTS 10 FT. PER STORY OR 20 FT. WHICHEVER IS GREATER, SUBJECT TO 118—100F; NONE FOR MULTIFAMILY AND MIXED USE DEVELOPMENTS		
AGGREGATE SIDE YARD	NONE EXCEPT WHERE RESIDENCE ZONE OR COASTAL WATERS ABUT 10 FEET PER STORY OR 20 FT. WHICHEVER IS GREATER, SUBJECT TO 118-100F; NONE FOR MULTIFAMILY AND MIXED USED DEVELOPMENTS		
REAR YARD	10 FT. EXCEPT WHERE RESIDENCE ZONE OR COASTAL WATERS ABUT 10 FEET PER STORY OR 20 FEET WHICHEVER IS GREATER, SUBJECT TO 118-100F; NONE FOR MULTIFAMILY AND MIXED USE DEVELOPMENTS		
BUILDING AREA	50% FOR BUILDINGS 90% FOR BUILDINGS AND PARKING; NONE FOR MULTIFAMILY AND MIXED USE DEVELOPMENTS IN TRANSIT ORIENTED DEVELOPMENTS		
FLOOR AREA RATIO	1.0; 2.0 FOR MULTIFAMILY AND MIXED USE DEVELOPMENTS IN TRANSIT ORIENTED DEVELOPMENTS		
BUILDING HEIGHT	4 STORIES & 50 FT., 6 STORIES & 72 FT. ON LOTS 30 ACRES OR LARGER, 5 STORIES & 60 FT. ABOVE BASE FLOOD LEVEL FOR MULTIFAMILY & MIXED USE DEVELOPMENTS WHICH PROVIDE A MINIMUM OF THIRTY (30%) AFFORDABLE HOUSING IN ACCORDANCE WITH SECTION 8-30g OF THE CT. GENERAL STATUES, PROVIDED THAT A MINIMUM OF TEN PERCENT (10%) THE TOTAL NUMBER OF UNITS SHALL COMPLY WITH SECTION 118-1050 WORKFORCE HOUSING REGULATION		
RECREATION AREA	150 SO.FT. PER DWELLING UNIT, MAY INCLUDE BALCONIES, COURTYARDS, INDOOR RECREATIONAL FACILITIES, LANDSCAPED ROOFS AND OUTDOOR RECREATIONAL AREAS		
RESIDENTIAL DENSITY	1,650 SQ.FT. OF LOT AREA PER DWELLING UNIT, SUBJECT TO SECTION 118-1050; 800 SQ.FT. OF LOT AREA PER DWELLING UNIT FOR MULTIFAMILY DEVELOPMENTS WHICH PROVIDE A MINIMUM OF THIRTY PERCENT (30%) AFFORDABLE HOUSING IN ACCORDANCE WITH SECTION 8-30g OF THE CT. GENERAL STATUES, THAT A MINIMUM OF TEN (10%) THE TOTAL NUMBER OF UNITS SHALL COMPLY WITH SECTION 118-1050 WORKFORCE HOUSING REGULATION		

	REQUIRED / ALLOWED	EXISTING	PROPOSED
LOT AREA	5,000 SQ. FT.	19,562± SQ. FT.	NO CHANGE
LOT WIDTH	50 FT. MIN.	0.4491± ACRES XX.XX FT.	NO CHANGE
FRONT YARD	35 FT. MIN. FROM C.L. SUBJECT TO SECT. 118-100B; EXCEPT FOR MULTIFAMILY AND MIXED USE DEVELOPMENTS WHICH SHALL BE LOCATED NOT MORE THAN TEN (10) FEET FROM PROPERTY LINE, SUBJECT TO 118-700 C (6)	X.X± FT.	
SIDE YARD	NONE EXCEPT WHERE RESIDENCE ZONE ABUTS 10 FT. PER STORY OR 20 FT. WHICHEVER IS GREATER, SUBJECT TO 118-100F; NONE FOR MULTIFAMILY AND MIXED USE DEVELOPMENTS		
AGGREGATE SIDE YARD	NONE EXCEPT WHERE RESIDENCE ZONE OR COASTAL WATERS ABUT 10 FEET PER STORY OR 20 FT. WHICHEVER IS GREATER, SUBJECT TO 118-100F; NONE FOR MULTIFAMILY AND MIXED USED DEVELOPMENTS		
REAR YARD	10 FT. EXCEPT WHERE RESIDENCE ZONE OR COASTAL WATERS ABUT 10 FEET PER STORY OR 20 FEET WHICHEVER IS GREATER, SUBJECT TO 118-100F; NONE FOR MULTIFAMILY AND MIXED USE DEVELOPMENTS		
BUILDING AREA	50% FOR BUILDINGS 90% FOR BUILDINGS AND PARKING; NONE FOR MULTIFAMILY AND MIXED USE DEVELOPMENTS IN TRANSIT ORIENTED DEVELOPMENTS		
FLOOR AREA RATIO	1.0; 2.0 FOR MULTIFAMILY AND MIXED USE DEVELOPMENTS IN TRANSIT ORIENTED DEVELOPMENTS		
BUILDING HEIGHT	4 STORIES & 50 FT., 6 STORIES & 72 FT. ON LOTS 30 ACRES OR LARGER, 5 STORIES & 60 FT. ABOVE BASE FLOOD LEVEL FOR MULTIFAMILY & MIXED USE DEVELOPMENTS WHICH PROVIDE A MINIMUM OF THIRTY (30%) AFFORDABLE HOUSING IN ACCORDANCE WITH SECTION 8-30g OF THE CT. GENERAL STATUES, PROVIDED THAT A MINIMUM OF TEN PERCENT (10%) THE TOTAL NUMBER OF UNITS SHALL COMPLY WITH SECTION 118-1050 WORKFORCE HOUSING REGULATION		
RECREATION AREA	MAY INCLUDE BALCONIES, COURTYARDS, INDOOR RECREATIONAL FACILITIES, LANDSCAPED ROOFS AND OUTDOOR RECREATIONAL AREAS		
	1,650 SQ.FT. OF LOT AREA PER DWELLING UNIT, SUBJECT TO SECTION 118-1050; 800 SQ.FT. OF LOT AREA PER DWELLING UNIT FOR MULTIFAMILY DEVELOPMENTS WHICH PROVIDE A MINIMUM OF THIRTY PERCENT (30%) AFFORDABLE HOUSING IN ACCORDANCE WITH SECTION 8-30g OF THE CT. GENERAL STATUES, PROVIDED THAT A MINIMUM OF TEN (10%) THE TOTAL NUMBER OF UNITS SHALL COMPLY WITH SECTION 118-1050 WORKFORCE HOUSING REGULATION		

ZONING DATA CHART 'INDUSTRIAL NO. 1' ZONE - 13 DAY STREET

REQUIRED / ALLOWED PROPOSED 56,130± SQ. / LOT AREA 5,000 SQ. FT. NO CHANGE 1.2886± ACRES LOT WIDTH 50 FT. MIN. XX.XX FT. NO CHANGE 35 FT. MIN. FROM C.L. SUBJECT TO SECT. X.X± FT. 118-100B; EXCEPT FOR MULTIFAMILY AND MIXED USE DEVELOPMENTS WHICH SHALL BE LOCATED NOT MORE THAN TEN (10) FEET FROM PROPERTY LINE, SUBJECT TO NONE EXCEPT WHERE RESIDENCE ZONE ABUTS 10 FT. PER STORY OR 20 FT. WHICHEVER IS GREATER, SUBJECT TO MIXED USE DEVELOPMENTS AGGREGATE SIDE YARD NONE EXCEPT WHERE RESIDENCE ZONE OR COASTAL WATERS ABUT 10 FEET PER STORY OR 20 FT. WHICHEVER IS GREATER, SUBJECT TO 118-100F; NONE FOR 10 FT. EXCEPT WHERE RESIDENCE ZONE
OR COASTAL WATERS ABUT 10 FEET PER
STORY OR 20 FEET WHICHEVER IS GREATER,
SUBJECT TO 118-100F; NONE FOR
MULTIFAMILY AND MIXED USE DEVELOPMENTS BUILDING AREA 90% FOR BUILDINGS AND PARKING; NONE FOR MULTIFAMILY AND MIXED USE DEVELOPMENTS IN TRANSIT FLOOR AREA RATIO 1.0; 2.0 FOR MULTIFAMILY AND MIXED USE DEVELOPMENTS IN BUILDING HEIGHT 6 STORIES & 72 FT. ON LOTS 3 ACRES OR LARGER, 5 STORIES & 60 FT. ABOVE BASE FLOOD LEVE FOR MULTIFAMILY & MIXED USE DEVELOPMENTS WHICH PROVIDE MINIMUM OF THIRTY (30% ) AFFORDABLE HOUSING IN ACCORDANCE WITH SECTION 8-30g OF THE CT. GENERAL STATUES, PROVIDED THAT A MINIMUM OF TEN PERCENT (10%) THE TOTAL NUMBER OF UNITS SHALL COMPLY WITH SECTION 118-1050 WORKFORCE HOUSING 150 SO.FT. PER DWELLING UNIT, MAY INCLUDE BALCONIES, COURTYARDS, INDOOR RECREATIONAL FACILITIES, LANDSCAPED ROOFS AND OUTDOOR RECREATIONAL AREAS RESIDENTIAL DENSITY 1,650 SQ.FT. OF LOT AREA PER DWELLING UNIT, SUBJECT TO SECTION 118-1050; 800 SQ.FT. OF LOT AREA PER DWELLING UNIT FOR MULTIFAMILY DEVELOPMENTS WHICH PROVIDE A MINIMUM OF THIRTY PERCENT (30%) AFFORDABLE HOUSING IN ACCORDANCE WITH SECTION 8-309 OF THE CT. GENERAL STATUES, PROVIDED THAT A MINIMUM OF TEN (10%) THE TOTAL SECTION 118-1050 WORKFORCE HOUSING

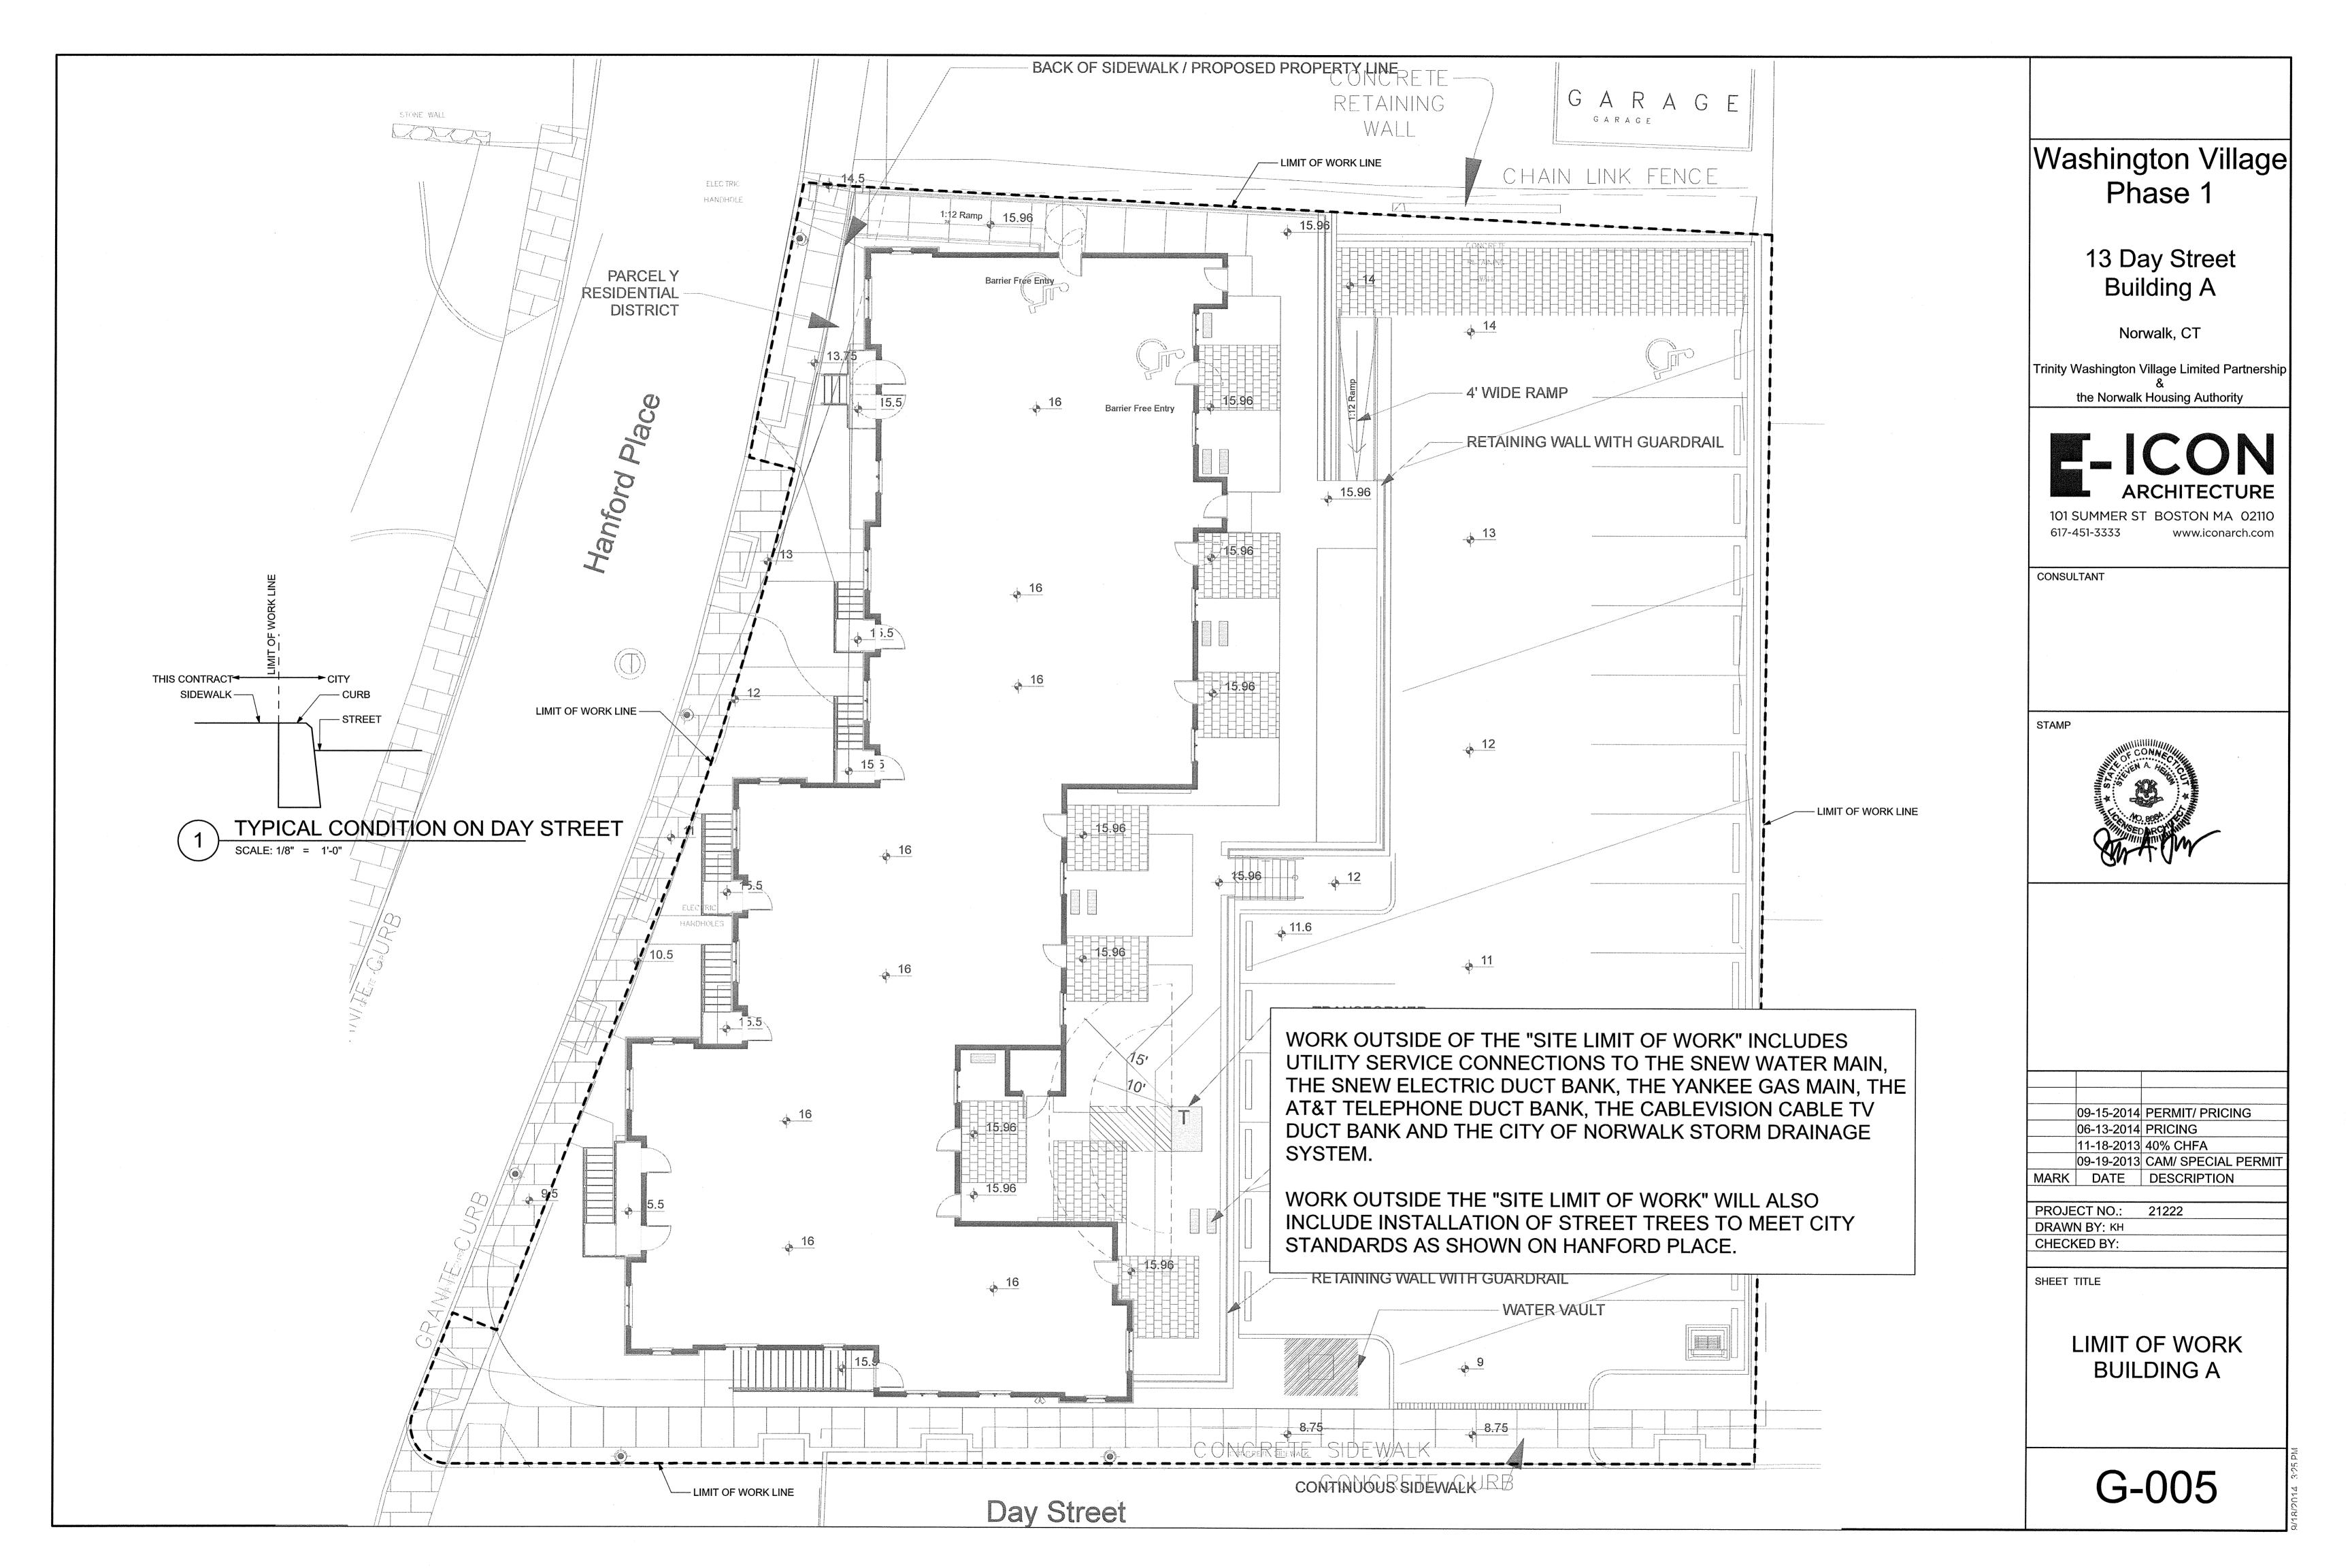ZONING DATA CHART 'INDUSTRIAL NO. 1' ZONE - 20 DAY STREET

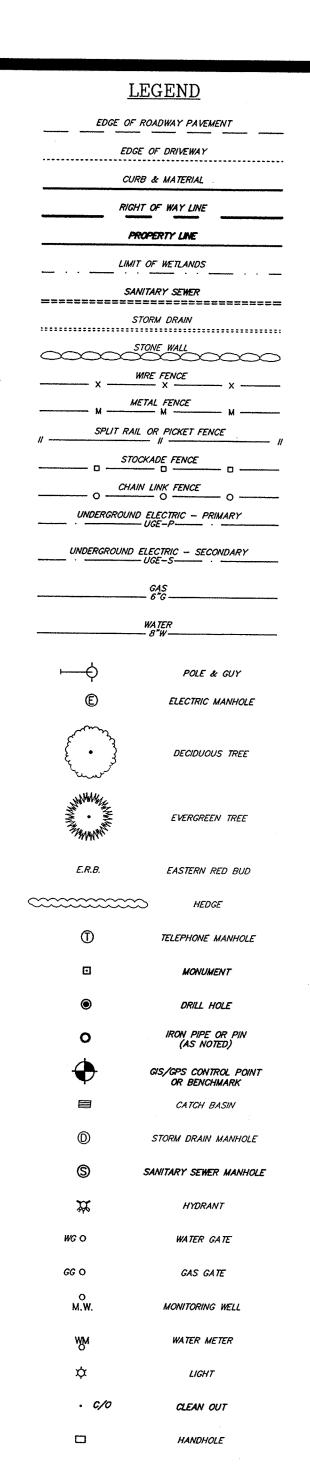

WASHINGTON VILLAGE, NORWALK, CT

DESCRIPTION: Beginning at a point, said point being the intersection of the southerly line of Raymond Street with the easterly line of Day Street: Thence, running easterly along said southerly line of Raymond Street south 89°

Thence, running southerly along said westerly line of Water Street south 08° 27' 29" east a distance of 573.01 feet to a point and land now or formerly of Skyview Three Limited Partnership;

19' 20" east a distance of 365.00 feet to the westerly line of Water Street;

Thence, running westerly and southerly along land of now or formerly of said Skyview Three Limited Partnership north 89° 12' 56" west a distance of 250.11 feet and south 14° 06' 30" east a distance of 71.29 feet to a point on the northerly line of Concord Street;

Thence, running westerly along said northerly line of Concord Street north 89° 10' 10" west a distance of 31.75 feet to land now or formerly of Robert A.

Thence, running northerly and westerly along land now or formerly of said Schwartz the following courses and distances: north 14° 43' 50" west a distance of 34.86 feet and north 15° 58' 20" west a distance of 49.43 feet and north 88° 08' 00" west a distance of 10.44 feet to a point;

Thence, turning and running northerly, still along land now or formerly of said Schwartz and land now or formerly of 50 Day Street Associates, each in part, north 0° 03' 40" west a distance of 150.00 feet;

Thence, turning and running westerly, still along land now or formerly of said 50 Day Street Associates, south 89° 56' 20" west a distance of 150.00 feet to the aforesaid easterly line of Day Street:

Thence, running northerly along said easterly line of Day Street north 0° 14' 42" west a distance of 404.92 feet to the aforesaid southerly line of Raymond Street and the point of beginning.

Said parcel is bounded northerly by Raymond Street, easterly by Water Street, southerly and easterly by land now or formerly of Skyview Three Limited Partnership, again southerly by Concord Street, westerly, southerly, again westerly and again southerly by lands now or formerly of Robert A, Schwartz and 50 Day Street Associates, each in part, and again westerly by Day Street.

Comprising in area 207,419± sq. ft. or 4.7617± acres.

13 DAY STREET, NORWALK, CT

DESCRIPTION: Beginning at a point on the westerly line of Day Street, said point being the intersection of said westerly line of Boy Street with the northerly line of Hanford Place;

Thence, running southwesterly and northwesterly along said more werly line of Hanford Place the following courses and distances: 29.31 reet along a tangent arc curving to the right, the radius of which is 15.00 feet and subtending a delta or central angle of 11° 56' 33" and north 68° 23' 27" west a distance of 93.98 feet and along a tangent arc curving to the left, the radius of which is 238.00 feet and a distance of 43.24 feet subtending a delta or central angle of 10° 24' 37" to land now or formerly of Rosa L. Jenkins;

Thence, running northerly along land now or formerly of said Jenkins north 2° 32' 00" east a distance of 108.58 feet to a point and land now or formerly of Eric

Thence, running easterly along land now or formerly of said Shao & Xie, land now or formerly of Qian Xie and other lands now or formerly of said Shao & Xie. each in part, south 89° 42' 00" east a distance of 143.73 feet to the aforesaid westerly line of Day Street;

Thence, running southerly along said westerly line of Day Street south 0° 20' 00" east a distance of 140.50 feet to the aforesaid northerly line of Hanford Place and the point of beginning.

Said parcel is bounded northerly by lands now or formerly of Shao & Xie and land now or formerly of Qian Xie, each in part, easterly by Day Street, southerly by Hanford Place and westerly by land now or formerly of Jenkins. Comprising in area 19,562± sa, ft. or 0.4491 acre.

20 DAY STREET, NORWALK, CT

and the point of beginning.

DESCRIPTION: Beginning at a point, said point being the intersection of the southerly line of Hanford Place with the easterly line of Day Street;

Thence, running easterly along said southerly line of Hanford Place south 89° 03' 27 east a distance of 154.93 feet to land now or formerly of Janet S. Phillips;

Thence, running southerly, westerly, again southerly, easterly, again southerly, again easterly, again southerly, again westerly and again southerly along said land now or formerly of Janet S. Phillips, other land now or formerly of said Phillips and again other land now or formerly of said Phillips, each in part, the following courses and distances: south 0° 12' 50" east a distance of 60.00 feet and south 89° 47' 10" west a distance of 4.00 feet and south 0° 12' 50" east a distance of 35.02 feet and north 89° 47' 10" east a distance of 4.00 feet and south 0° 12' 50" east a distance of 57.67 feet and south 83° 56'30" east a distance of 5.44 feet and south 0° 19' 50" east a distance of 89.10 feet and south 88° 35'30" west a distance of 18.17 feet and south 0° 20' 00" east a distance of 127.99 feet to a point on the northerly line of Raymond Street;

Thence, running westerly along said northerly line of Raymond Street north 89° 20' 40" west a distance of 141.83 feet to the aforesaid easterly line of Day Street; Thence, running northerly along said easterly line of Day street north 0° 20' 00" west a distance of 371.73 feet to the aforesaid southerly line of Hanford Place

Said parcel is bounded northerly by Hanford Place, easterly by lands now or formerly of Janet S. Phillips, southerly by Raymond Street and westerly by Day

Comprising in area 56,130± sq. ft. or 1.2886± acres.

WASHINGTON VILLAGE  $AREA = 207,419 \pm SQ.FT$ OR 4.7617± ACRES

13 DAY STREET  $AREA = 19,562 \pm SQ.FT.$ OR 0.4491± ACRES

20 DAY STREET  $AREA = 56,130 \pm SQ.FT.$ OR I.2886± ACRES

THIS SURVEY AND MAP HAVE BEEN PREPARED IN ACCORDANCE WITH SECTIONS 20-300B-1 THROUGH 20-300B-20 OF THE REGULATIONS OF CONNECTICUT STATE AGENCIES - "MINIMUM STANDARDS FOR SURVEYS AND MAPS IN THE STATE OF CONNECTICUT" AS ADOPTED FOR USE BY THE CONNECTICUT ASSOCIATION OF LAND SURVEYORS, INC. ON SEPTEMBER 26, 1996. IT IS A PROPERTY & TOPOGRAPHIC SURVEY THE BOUNDARY DETERMINATION CATEGORY OF WHICH IS A RESURVEY CONFORMING TO HORIZONTAL ACCURACY CLASS 'A - 2', VERTICAL ACCURACY CLASS 'V - 2' AND TOPOGRAPHIC ACCURACY CLASS 'T - 2' AND IS INTENDED TO BE USED FOR CONVEYANCING, MORTGAGING, FINANCING AND TITLE INSURANCE PURPOSES AND TO DEPICT OR NOTE THE POSITION OF EXISTING OR PROPOSED IMPROVEMENTS WITH RESPECT TO APPLICABLE MUNICIPAL SETBACK REQUIREMENTS IN ORDER TO ENABLE DETERMINATION OF COMPLIANCE WITH SAID REGULATIONS.

THIS SURVEY WAS PREPARED FOR A SPECIFIC PURPOSE. ANY USE OTHER THAN FOR THAT WHICH WAS INTENDED IS A MISUSE OF THIS INFORMATION AND RENDERS THE PREPARER'S DECLARATION NULL AND VOID.

UNAUTHORIZED ALTERATIONS OR ADDITIONS TO THIS MAP RENDERS THE PREPARER'S DECLARATION NULL AND VOID.

DISTANCES NOTED +/- FROM BUILDINGS TO PROPERTY LINES ARE FOR REFERENCE PURPOSES ONLY AND ARE NOT TO BE USED TO ESTABLISH PROPERTY BOUNDARIES. UNDERGROUND IMPROVEMENTS OR ENCROACHMENTS, IF ANY, ARE NOT DEPICTED HEREON. STRUCTURES DEPICTED HEREON ARE MORE THAN THREE (3) YEARS OLD.

SUBJECT PROPERTIES LOCATED IN AN 'INDUSTRIAL NO. 1' ZONE.

11283, 11284 AND 102010 OF THE NORWALK LAND RECORDS.

ALL BOUNDARY MONUMENTATION FOUND OR SET HAS BEEN DEPICTED HEREON. REFER TO MAP NOS. 1907, 5740, 7503, 9044, 9375, 10331, 10737, 10851, 11104, 11188,

REFER TO BK. 148 PG. 500 AND BK. 1366 PG. 2 OF THE NORWALK LAND RECORDS.

REGARDING WASHINGTON VILLAGE: REFER TO BK. 280, PG. 348 AND BK. 281, PG. 605 OF THE

REGARDING 13 DAY STREET: REFER TO BK. 2515, PG. 6, BK. 1375, PG. 224 & BK. 1326, PG. 188 OF THE NORWALK LAND RECORDS.

REGARDING 20 DAY STREET: REFER TO BK. 1395, PG. 344, BK. 1387, PG. 292, BK. 1387, PG. 289, BK. 1387, PG. 286, BK. 1385, PG. 234, BK. 1378, PG. 88, BK. 1378, PG. 85, BK. 1378, PG. 82, BK. 1378, PG. 80, BK. 1376, PG. 116, BK. 1370, PG. 112, BK. 1359, PG. 279, BK. 1334, PG. 277, BK. 1312, PG. 294, BK. 1312, PG. 292 & BK. 1312, PG. 290 OF THE NORWALK LAND RECORDS.

REFER TO AN UNRECORDED MAP BY TITLED "WASHINGTON VILLAGE HOUSING PROJECT FOR THE HOUSING AUTHORITY CITY OF NORWALK - CONN." SCALE 1" = 20' AND DATED DECEMBER 8, 1939. INLAND WETLANDS, IF ANY, ARE NOT DEPICTED HEREON.

THE 1% ANNUAL CHANCE FLOOD ZONE BOUNDARY DEPICTED HEREON HAS BEEN DERIVED FROM ELEVATIONS NOTED ON THE FEDERAL EMERGENCY MANAGEMENT AGENCY FLOOD INSURANCE RATE MAPS 09001C0531G AND 09001C0533G DATED JULY 8, 2013. THIS INFORMATION IS PROVIDED FOR REFERENCE PURPOSES ONLY AND DOES NOT NECESSARILY REPRESENT THE ACTUAL POTENTIAL FOR FLOOD DAMAGE TO ANY EXISTING OR PROPOSED STRUCTURES LOCATED ON THIS PROPERTY.

SUBJECT PROPERTIES LIES ENTIRELY WITHIN A COASTAL AREA MANAGEMENT BOUNDARY. THE UNDERGROUND UTILITIES SHOWN HEREON HAVE BEEN LOCATED FROM FIELD SURVEY

INFORMATION AND EXISTING DRAWINGS. THE SURVEYOR MAKES NO GUARANTEES THAT THE UNDERGROUND UTILITIES SHOWN COMPRISE ALL SUCH UTILITIES IN THE AREA, EITHER IN SERVICE OR ABANDONED. THE SURVEYOR FURTHER DOES NOT WARRANT THAT THE UNDERGROUND UTILITIES SHOWN ARE IN THE EXACT LOCATION INDICATED ALTHOUGH HE DOES CERTIFY THAT THEY ARE LOCATED AS ACCURATELY AS POSSIBLE FROM INFORMATION AVAILABLE. THE SURVEYOR HAS NOT PHYSICALLY LOCATED THE UNDERGROUND UTILITIES.

PRIOR TO EXCAVATION THE EXACT LOCATION OF THE UTILITIES SHOULD BE CONFIRMED WITH 'CALL BEFORE YOU DIG' @ 1-800-922-4455 AND/OR THE RESPECTIVE UTILITY

TO: TRINITY WASHINGTON VILLAGE LIMITED PARTNERSHIP TRINITY WASHINGTON VILLAGE, INC. TRINITY FINANCIAL, INC. CITY OF NORWALK NORWALK REDEVELOPMENT AGENCY

THIS IS TO CERTIFY THAT THIS MAP OR PLAT AND THE SURVEY ON WHICH IT IS BASED WERE MADE IN ACCORDANCE WITH THE 2011 MINIMUM STANDARD DETAIL REQUIREMENTS FOR ALTA/ACSM LAND TITLE SURVEYS, JOINTLY ADOPTED BY BY ALTA AND NSPS AND INCLUDES ITEMS 2, 3, 4, 5, 6(b), 8, 9, 11(a), 13, 16, 17, 18, AND 21 (\$1,000,000 MINIMUM THRESHOLD) OF TABLE A THEREOF. THE FIELD WORK WAS COMPLETED ON AUGUST 19, 2013.

TO MY KNOWLEDGE AND BELIEF, THIS MAP IS SUBSTANTIALLY CORRECT AS NOTED HEREON. MARK S. LEBOW, CT PLS #15564

PROPERTY, TOPOGRAPHIC & ALTA/ACSM LAND TITLE SURVEY SHEET 3 OF 3 SHEETS DEPICTING

WASHINGTON VILLAGE, 13 & 20 DAY STREET PREPARED FOR

TRINITY WASHINGTON VILLAGE LIMITED PARTNERSHIP

THE NORWALK HOUSING AUTHORITY


NORWALK, CONNECTICUT

SCALE: 1" = 30 FT. SEPTEMBER 4, 2013

WILLIAM W. SEYMOUR & ASSOCIATES, P.C. LAND SURVEYORS ~ ZONING & LAND USE CONSULTANTS

170 NOROTON AVENUE № 203-655-3331 № DARIEN, CONN. ©



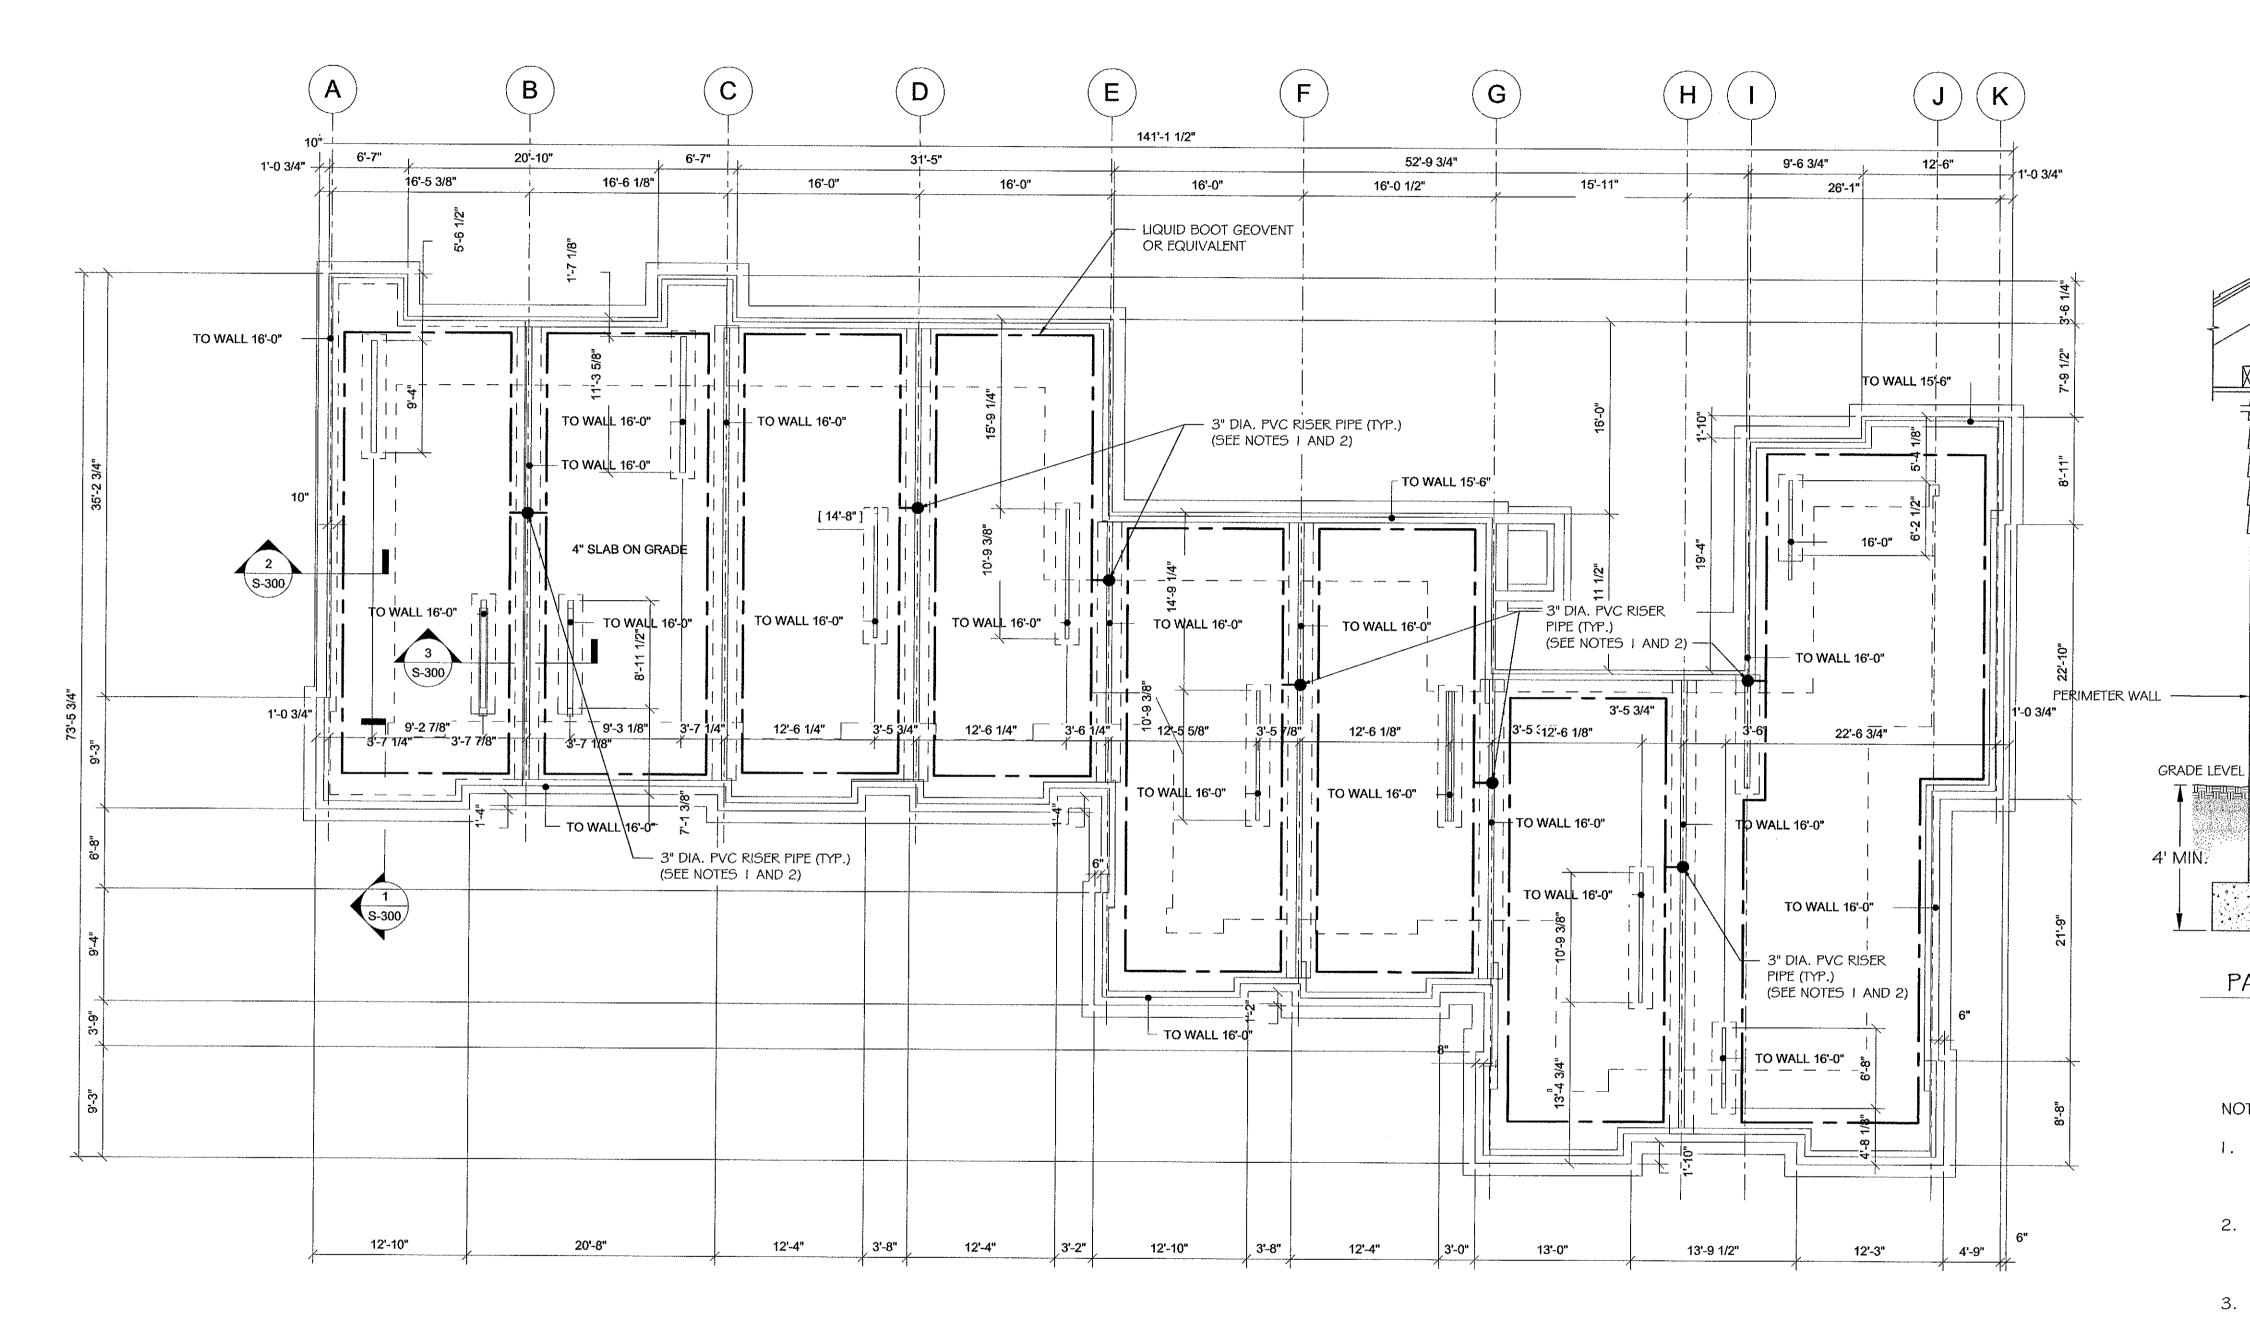

#### NOTES:

- 1. EXACT LOCATIONS OF 3-INCH DIA. RISER PIPES SHOULD BE COORDINATED WITH MEP ENGINEER / ARCHITECT.
- 2. SEAL ALL PENETRATIONS THROUGH SLAB AND SLABWALL JOINTS USING A POLYURETHANE OR AN ELASTOMETRIC JOINT SEALANT.
- 3. REFER TO PASSIVE SUB SLAB VENTILATION DETAIL DRAWING G2.O.

#### GENERAL NOTE:

THE EXCAVATION, HANDLING, AND MANAGEMENT OF ALL SITE SOILS, INCLUDING THE ON-SITE REUSE OF EXISTING SITE SOILS TO THE FULLEST EXTENT FEASIBLE, SHALL BE PERFORMED IN ACCORDANCE WITH THE EARTHWORK SPECIFICATION SECTION 02300 AND THE SOIL MANAGEMENT PLAN PREPARED FOR USE ON THIS PROJECT, PURSUANT TO THE STATE OF CONNECTICUT REMEDIATION STANDARD REGULATIONS (RSRS). LAWN/LANDSCAPED AREAS OF THE SITE NOT COVERED BY THE PROPOSED BUILDINGS, CONCRETE OR PAVEMENT SHALL BE COVERED BY A GEOTEXTILE MARKER BARRIER AND A MINIMUM 4-FOOT SURFICIAL THICKNESS OF "CLEAN" SOIL, MEETING THE CT RSRS, AT FINISHED GRADE.

## Washington Village Phase 1

### 13 Day Street Building A

Norwalk, CT

Trinity Washington Village Limited Partnership the Norwalk Housing Authority

101 SUMMER ST BOSTON MA 02110 617-451-3333 www.iconarch.com

CONSULTANT

EXHAUST (10' FROM OPENINGS AND AIR EXCHANGE / INTAKE UNITS INTO CONDITIONED SPACES OF BUILDING)

- INTERIOR PARTITION

SUBGRADE — 3" DIA. PVC TEE FITTING

- ELECTRICAL JUNCTION BOX FOR FUTURE

INSTALLATION OF VENT

- SUPPORT STRAPPING

FAN, NOTE 5

- 3" DIA. VENT PIPE (SCHEDULE 40 PVC OR EQUIVALENT)

CONCRETE SLAB-ON-GRADE

- LIQUID BOOT®' GEOVENT

OR EQUIVALENT

ROOF

ELECTRICAL JUNCTION BOX FOR FUTURE

VAPOR BARRIER (MIN. -20-MIL POLYOLEFIN

- MIN. 6" THICK LAYER OF

GRAVEL BORROW; NOTE

OR HDPE SHEETING

OR EQUIVALENT)

TITINSTALLATION OF

WARNING DEVICE



Geoenvironmental Engineers

2269 Massachusetts Avenue Cambridge, MA 02140 617/868-1420 617/868-1423 (Fax)



NOTES:

1. ALL CONCRETE SLABS THAT COME IN CONTACT WITH THE GROUND SHALL BE LAID OVER A GAS PERMEABLE MATERIAL MADE UP OF A MINIMUM 6" THICK UNIFORM LAYER OF GRAVEL BORROW.

PASSIVE SUB SLAB VENTILATION SYSTEM DETAIL

N.T.S.

- 2. LIQUID BOOT GEOVENT OR EQUIVALENT PRODUCT SHALL BE INSTALLED WITHIN A MINIMUM 6" THICKNESS OF 3/4" CRUSHED STONE.
- 3. ALL OPENINGS, GAPS AND JOINTS IN FLOOR AND WALL ASSEMBLIES IN CONTACT WITH SOIL OR GAPS AROUND PIPES, TOILETS, BATHTUBS OR DRAINS PENETRATING THESE ASSEMBLIES SHALL BE FILLED OR CLOSED WITH MATERIALS THAT PROVIDE A PERMANENT AIR-TIGHT SEAL. SEAL LARGE OPENINGS WITH NON-SHRINK MORTAR, GROUTS OR EXPANDING FOAM MATERIALS AND SMALLER GAPS WITH AN ELASTOMERIC JOINT SEALANT, AS DEFINED IN ASTM C920-87.
- 4. VENT PIPES SHALL BE INSTALLED SO THAT ANY RAINWATER OR CONDENSATION DRAINS DOWNWARD INTO THE GROUND BENEATH THE SLAB OR VAPOR BARRIER.
- 5. ADD ELECTRIC JUNCTION BOXES FOR FUTURE INSTALLATION OF VENT FAN AND WARNING DEVICE IF NECESSARY. CIRCUITS SHOULD BE A MINIMUM 15 AMP, 115 VOLT.
- 6. REFER TO PASSIVE RADON CONTROL SYSTEM LAYOUT DRAWINGS.


09-15-2014 PERMIT/ PRICING 06-13-2014 PRICING 11-18-2013 40% CHFA 09-19-2013 CAM/ SPECIAL PERMIT MARK DATE DESCRIPTION


PROJECT NO.: **DRAWN BY:** CHECKED BY:

SHEET TITLE

PASSIVE SUB **SLAB VENTILATION** SYSTEM **BUILDING A** 

GT1.0

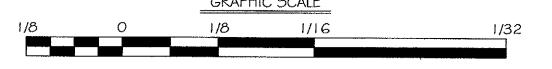

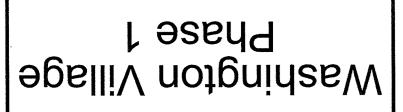

A gniblina 13 Day Street

Norwalk, CT

Trinity Washington Village Limited Partnership

the Norwalk Housing Authority

### <u>www.iconarch.com</u> 2222-ISP-ZI9 OTISO AM NOTSOB TS A DIMUS TOT **ARCHITECTURE**

Suite 320 1000 Bridgeport Avenue www.tighebond.com TNATJUSNOC

**GMAT** (203) 712-1100 Shelton, CT 06484

DESCRIPTION 09-19-2013 CAM/ SPECIAL PERMIT 11-18-2013 PRICING 4102-21-90 PERMIT/ PRICING 4102-21-60

DRAWN BY: MDS PROJECT NO.: 10071 MARK DATE

SHEET TITLE CHECKED BJ: AJM

NAJqSANITARY SEWER SITE STORM AND

1. UNDERGROUND UTILITY, STRUCTURE AND FACILITY LOCATIONS DEPICTED HEREON HAVE BEEN COMPILED, IN PART, FROM

CALL-BEFORE-YOU-DIG 1-800-922-4455. SUCH FEATURES MUST BE DETERMINED AND VERIFIED IN THE FIELD BY APPROPRITE AUTHORITIES PRIOR TO CONSTRUCTION @ EXIST ON SITE, THE EXISTENCE OF WHICH ARE UNKNOWN TO TIGHE & BOND. THE EXISTENCE, SIZE AND LOCATION OF ALL OTHER SOURCES. THESE LOCATIONS MUST BE CONSIDERED APPROXIMATE IN NATURE. ADDITIONALLY, OTHER SUCH DATA MAY RECORD MAPPING AND OTHER DATA SUPPLIED BY THE RESPECTIVE UTILITY COMPANIES, GOVERNMENTAL AGENCIES AND/OR

ASSOCIATES P.C., DATED SEPTEMBER 4, 2013. WASHINGTON VILLAGE LIMITED PARTNERSHIP AND THE NORWALK HOUSING AUTHORITY, PREPARED BY WILLIAM W. SEYMOUR & 2. REFERENCE IS MADE TO PLAN ENTITLED "PROPERTY , TOPOGRAPHIC & ALTA/ACSM LAND TITLE SURVEY" PREPARED FOR TRINITY

PERFORMED WITHIN CITY RIGHT-OF-WAY. 3. THE CONTRACTOR SHALL OBTAIN A CITY OF NORWALK EXCAVATION STREET OPENING PERMIT PRIOR TO ANY WORK BEING

4. ANY AND ALL WORK PERFORMED ON THE CITY OF NORWALK RIGHT-OF-WAY SHALL BE REQUIRED TO MEET THE CITY STANDARDS.

5. THE GENERAL CONTRACTOR SHALL PROVIDE FIELD ENGINEERING SERVICES TO ESTABLISH AND RECORD GRADES, LINES, AND

PROJECT LIMIT LINE TO MEET THE PROPOSED GRADES. SANITARY/STORM/WATER MANHOLES, CATCH BASINS, AREA DRAINS, VALVE COVERS AND APPURTENANCES, WITHIN THE 6. THE CONTRACTOR SHALL ADJUST THE TOP OF FRAME/GRATE ELEVATIONS OF ALL EXISTING AND PROPOSED

UTILITY SERVICES WITH THE PROJECT MECHANICAL, ELECTRICAL AND PLUMBING DRAWINGS PRIOR TO ANY CONSTRUCTION 7. THE CONTRACTOR SHALL COORIDINATE/VERIFY THE EXACT SIZES, LOCATIONS, ELEVATIONS, OF ALL PROPOSED BUILDING'S

9. THE CONTRACTOR SHALL COORDINATE HIS WORK WITH THE WORK DONE BY THE RESPECTIVE UTILITY COMPANIES. OPERATIONS. ALL EXCAVATION SHALL BE IN CONFORMANCE WITH THE LATEST OSHA REQUIREMENTS. NOT DAMAGED. IT SHALL BE THE CONTRACTOR'S SOLE RESPONSIBILITY FOR ANY DAMAGED INCURRED DURING EXCAVATION 8. EXCAVATION OF ANY TYPE SHALL BE ACCOMPLISHED IN SUCH A MANNER THAT UNDERGROUND UTILITIES OR STRUCTURES ARE

11. ANY AREAS DISTURBED BY CONSTRUCTION ACTIVITIES AND IS NOT PROVIDED WITH A SPECIFIC SITE IMPROVEMENT (PAVING, CONSTRUCTION AS DIRECTED BY THE OWNER'S REPRESENTATIVE AT NO ADDITIONAL COST TO THE OWNER. SHALL BE RETURNED TO THEIR ORIGINAL CONDITION OR BETTER AND SHALL BE GRADED TO MEET THE PROPOSED 10. ALL DRIVEWAYS, ROADS, STAIRS, AND SIDEWALKS DISTURBED BY THE CONSTRUCTION IN OR OUTSIDE THE PROJECT LIMIT LINE

12. THE LOCATIONS OF ITEMS NOT DIMENSIONED ON THE DRAWINGS SHALL BE FIELD STAKED BY THE CONTRACTOR AND THEIR SIDEWALK, LANDSCAPING, ETC.) SHALL HAVE 4" TOPSOIL AND TURF ESTABLISHMENT IN ACCORDANCE WITH THE PROJECT

WORK REQUIRED TO CENTER FRAME AND COVER. ASSURE THE FRAME AND COVER IS CENTERED ON THE PRECAST OPENING. THE CONTRACTOR WILL BE RESPONSIBLE FOR ALL FRAME AND COVER BE ACCEPTABLE. PRIOR TO FINAL PAVING, THE CONTRACTOR SHALL CHECK ALL MANHOLE STRUCTURES TO 14. THE MANHOLE FRAME AND COVER SHALL BE CENTERED ON THE PRECAST OPENING. UNDER NO CIRCUMSTANCES WILL AN OFFSET 13. INSTALL CLEANOUT TO GRADE 5' OFF FACE OF BUILDING ON ALL SANITARY LATERALS.

16. ALL PIPES AND FITTINGS SPECIFIED AS HDPE SHALL BE ADS N-12 WT (WATERTIGHT) PIPE AS MANUFACTURED BY ADVANCED SIZES PER MANUFACTURER'S RECOMMENDATIONS. 15. INSTALL "FERNCO" STYLE FLEXIBLE COUPLINGS AT ALL LOCATIONS WHERE JOINING PIPES OF DIFFERENT MATERIALS AND/OR

DRAINAGE SYSTEMS, HILLIARD, OHIO.

18. ALL ROOF DRAINS SHALL BE 6" PVC @ 1.0% MINIMUM SLOPE UNLESS NOTED OTHERWISE ON PLAN.

LOCATIONS APPROVED BY THE OWNER'S REPRESENTATIVE PRIOR TO INSTALLATION.

SITE STORM AND SANITARY SEWER PLAN NOTES

THE OWNERS REPRESENTATIVE DURING CONSTRUCTION. 19. THE CONTRACTOR SHALL MAINTAIN EXISTING RUNOFF AND STORM SEWER FLOWS BY PUMPING OR OTHER MEANS APPROVED BY

REMEDIATION STANDARD REGULATIONS (RSRS). LAWN/LANDSCAPED AREAS OF THE SITE NOT COVERED BY THE PROPOSED 02300 AND THE SOIL MANAGEMENT PLAN PREPARED FOR USE ON THIS PROJECT, PURSUANT TO THE STATE OF CONNECTICUT TO THE FULLEST EXTENT FEASIBLE, SHALL BE PERFORMED IN ACCORDANCE WITH THE EARTHWORK SPECIFICATION SECTION 21. THE EXCAVATION, HANDLING, AND MANAGEMENT OF ALL SITE SOILS, INCLUDING THE ON-SITE REUSE OF EXISTING SITE SOILS

SURFICIAL THICKNESS OF "CLEAN" SOIL, MEETING THE CT RSRS, AT FINISHED GRADE. BUILDINGS, CONCRETE OR PAVEMENT SHALL BE COVERED BY A GEOTEXTILE MARKER BARRIER AND A MINIMUM 4-FOOT

**TUONABLO** • C.O. .D.Y O **NIARD DRAIN** LIGHT POLE SANITARY MANHOLE SANITARY LATERAL SANITARY SEWER **CATCH BASIN** STORM MANHOLE STORM SEWER TEST PIT BNIFDING CONCRETE WALK RETAINING WALL CURB LINE EDGE OF PAVEMENT SPOT ELEVATION x 120.12 MAJOR CONTOUR MINOR CONTOUR РКОРЕКТУ LINE ----**PROPOSED EXISTING** SITE STORM AND SANITARY SEWER PLAN LEGEND

SITE GRADING INFORMATION.

800K 2813 6VCE 588

TA ELIZABETH STREET

SI TOI , BE NOCK 58, LOT 15

800K 7219 PAGE 134

133MIS HI38VZITA ZI

ASSESSORS MAP (SSE, BLOCK 58, LOT 16

BIX NYIO

881 39Vd 89L9 X008

133812 HIJBYZITZ OL

ASSESSORS MAR 15SE, BLOCK 58, LOT 17

31X AUH

EBIC SHYO

3 / N

AOTE: NOTE: NOTE:

58.Y = T90 🔚

7 39 F'E' 8" PVC @ 1.0% €

INV=7.25(N)

2300K (7 SECTIONS @ 39.37") 6" OUTLET

12" ACO TRENCH DRAIN (ADA GRATE)

N 87.E=TUO VNI

S 08.E=NI VNI

INV IN=5.26 W

INSTALLED OVER EXISTING 18" RCP

EL = 8.43 GRID E:816160.082

#\$1.387362:N GIAO

12 L.F. 12" RCP @ 2.00%

CONCRETE/CURB

~ 12 L.F. 6" DIP @ 15.0%

S IT.Z=TUO VNI (3S) 26.8=NI VNI

±8.8=∃TAЯ∂

CDS 7012 UNIT

~51 L.F. 12" HDPE @ 1.00% INV OUT=5.50 E

INV IN=5.50 N W OZ.4=NI VNI

48" DIA SHALLOW MH

INSPECTION MANHOLE (TYP)

4' X 8' X 2' PRECAST GALLEYS

INV: 3.50 (SEE DETAIL SHEET C4.3)

— 2 ROWS OF 40 L.F., 1 ROW OF 32 L.F.

RIM=9.2±

AS0 HM-

- 2 L.F. 12" HDPE @ 1.0%

INV OUT=5.50 E&N

48" DIA SHALLOW MH

- 58 L.F. 6" PVC ROOF LEADER

S SS.Z=NI VNI

M = 5.50 M

£3.01=MIЯ

INV=10.0 E & S

- YARD DRAIN, YD-1

±0.£1=3TAЯ∂

AE0 HM-

%97.7 @

TC 12.0 #

BOVBV

BOOK S210 PAGE 340 N.L.R.

11 HYMEOBD BIVCE

ASSESSORS MAP 155E, BLOCK 58, LOT 28

BOZY T' YENKINZ

3 L.F. 12" HDPE @ 0.0%

DAY STREET

18" RCP

TYPE 'A' GRATE (BICYCLE)

WATER QUALITY STRUCTURE

MITH TYPE 'CL' TOP AND

48" DIA DOGHOUSE MANHOLE

RIM=8.2±

27.8=7T

ST'9=∧NI

IS" HDPE

– .7.1 Z

IZ, HDbE - '37ĽE'

|| + B211.64 || + BC11

C.O. TW15.64+ +BW1

\_\_(0.81 WT) \>

6271

00.8 = (8) ANI

88.8 = (3) VM

01.8 = (N) VN

98.41 = MIA

S370HGNVH

-ELECTRIC

RETAINING

CONCHETE

- DOWNSPOUT LOCATION (TYP)

£0.6=∃TAЯÐ

YARD DRAIN, YD-3 —

67.2=√NI

±4.01=∃TAЯÐ

⊢ γρρ drain, yd-2 ⊢

0.01 = VMI

±2.21=3TAЯ∂

BUILDING A

₩ YARD DRAIN, YD-5 →

GRATE=9.0±

/96.0 = ANI

370HGNYH

- 21212373

e" PVC ROOF LEADER -

.NIM %00.1 @

- (9YT) TUONAELD

----(JASIGAL) ----

E: 812911: 503\_

ONLOGI

15, BCP

-85.8 = VM

CB.1 = 14742

10.4 = (W) VM

8.02

68.8 = 190

 $10^{\circ} = (N) \land N$ 

LL'G = (MS) ANI

YARD DRAIN, YD-4

±6.2 :VNI

+ 48 88 + 6.9 ST 0.9 SB

#6.11.5F

TC 12.5

BC 13.0 C.O.

F,97


LATERAL @ 2.0% MIN.

- 82 Г.F. 6" HDPE @ 1.0%<sup><</sup>

20 ୮.F. 6" HDPE @ 19.25% -





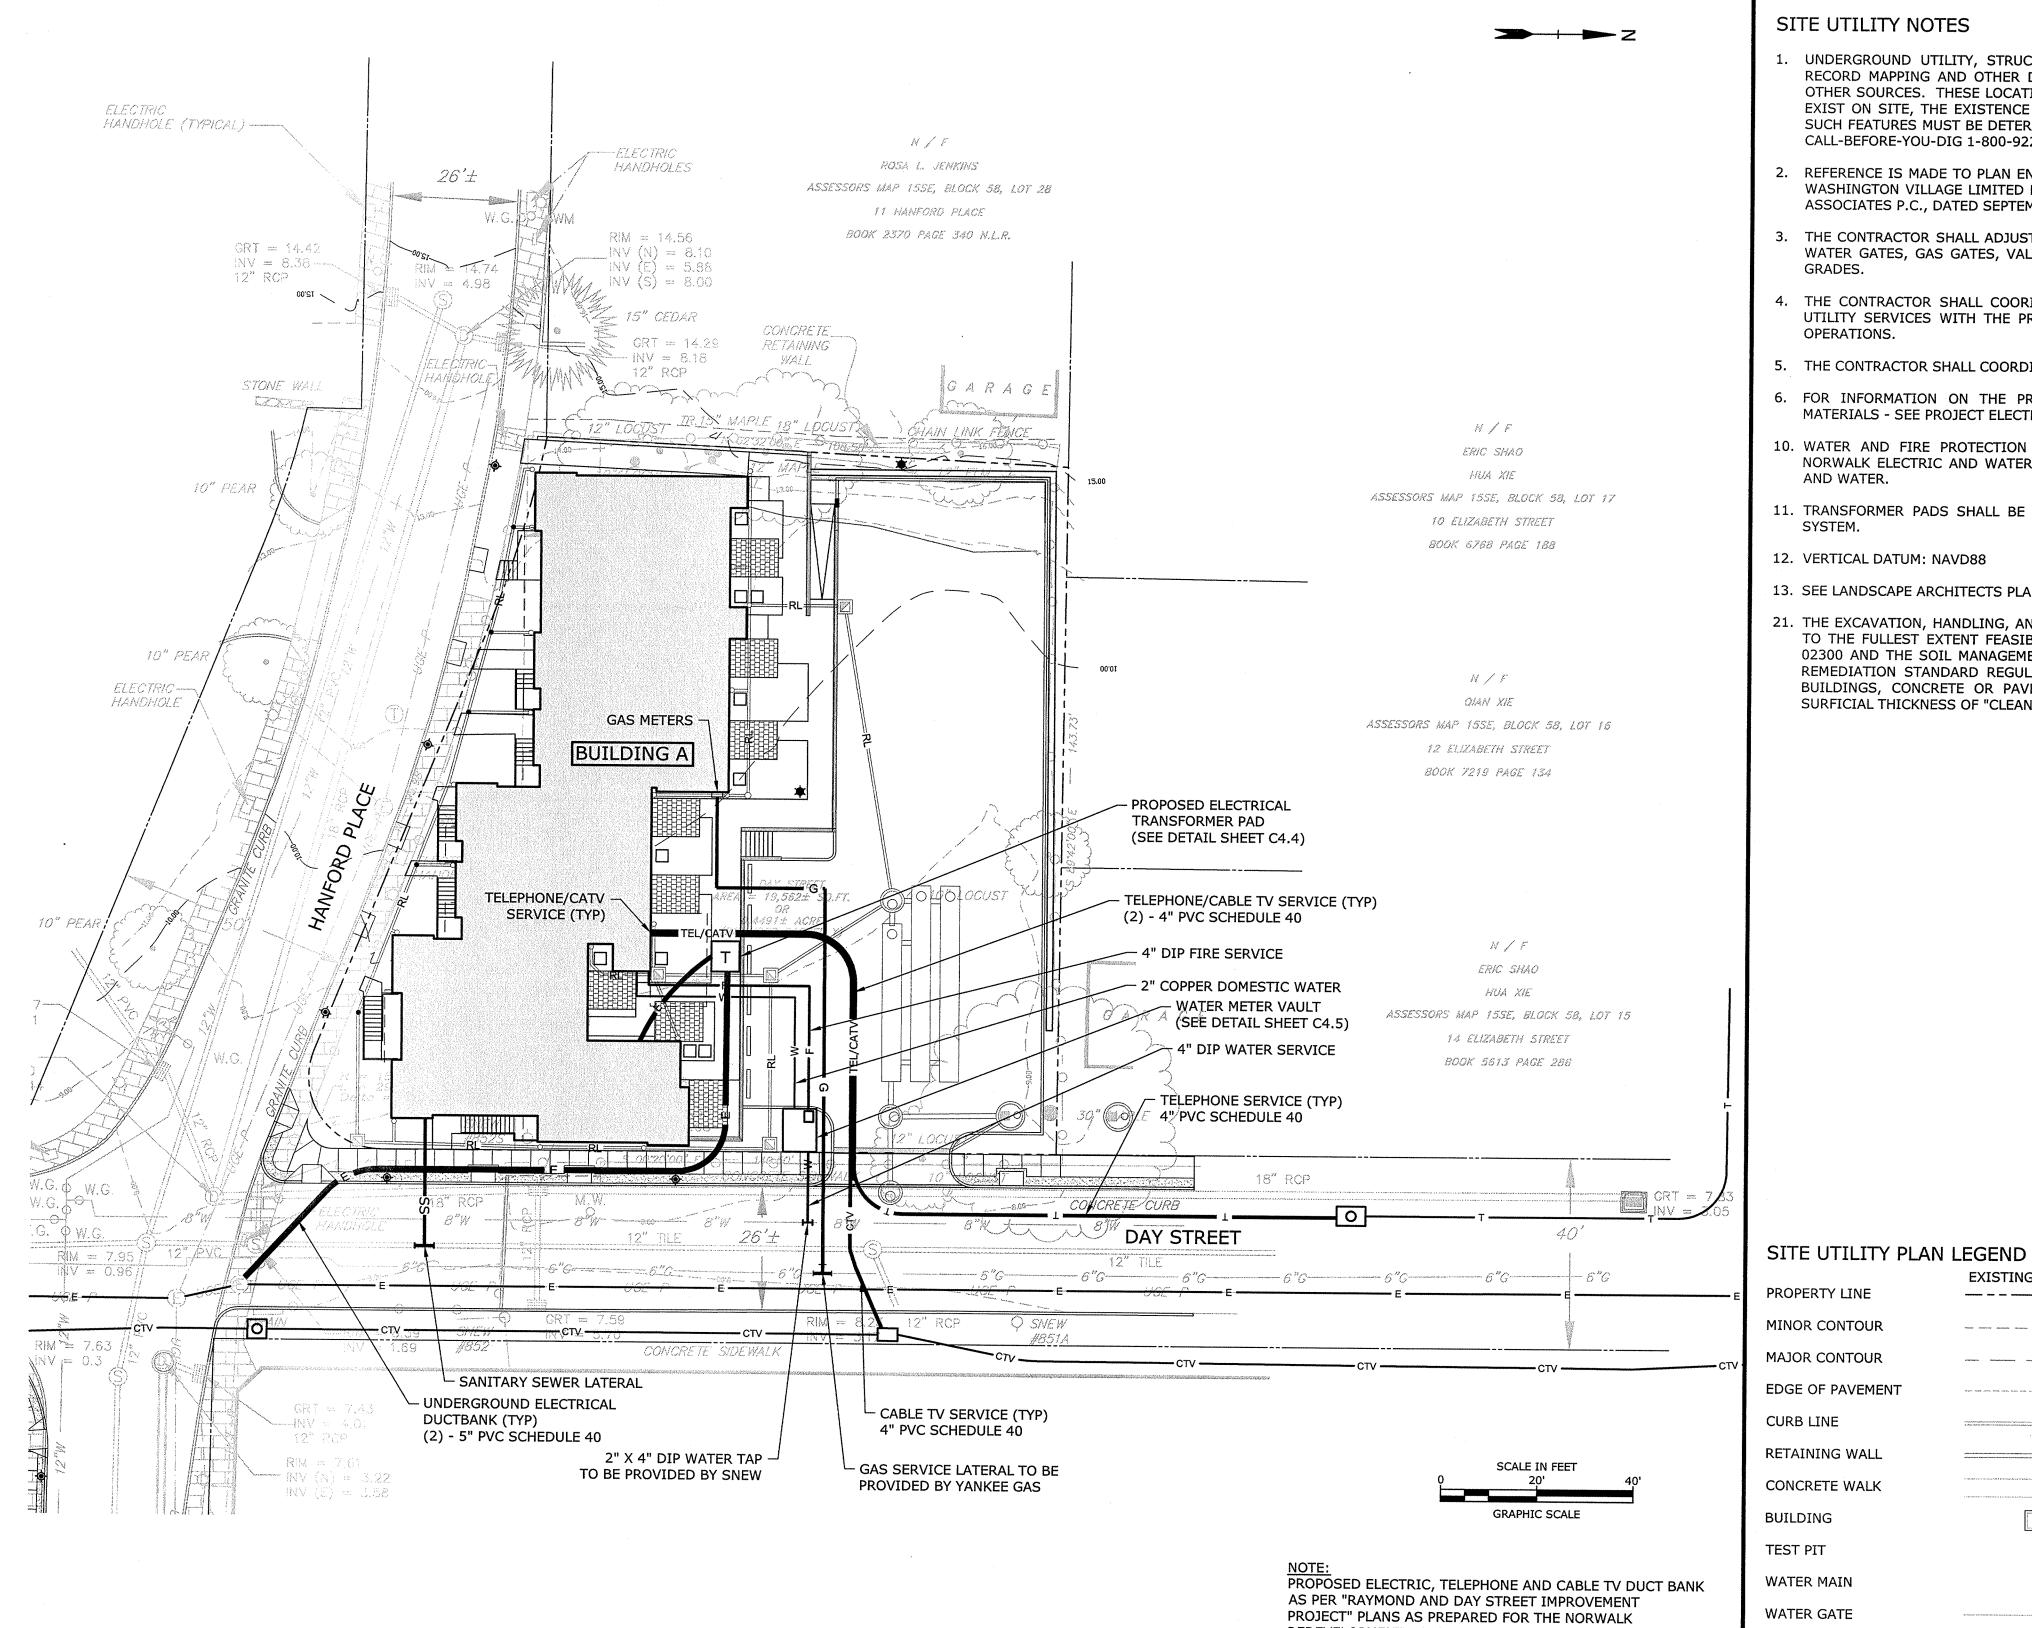

REDEVELOPMENT AGENCY AND THE NORWALK DPW.

#### SITE UTILITY NOTES

- UNDERGROUND UTILITY, STRUCTURE AND FACILITY LOCATIONS DEPICTED HEREON HAVE BEEN COMPILED, IN PART, FROM RECORD MAPPING AND OTHER DATA SUPPLIED BY THE RESPECTIVE UTILITY COMPANIES, GOVERNMENTAL AGENCIES AND/OR OTHER SOURCES. THESE LOCATIONS MUST BE CONSIDERED APPROXIMATE IN NATURE. ADDITIONALLY, OTHER SUCH DATA MAY EXIST ON SITE, THE EXISTENCE OF WHICH ARE UNKNOWN TO TIGHE & BOND. THE EXISTENCE, SIZE AND LOCATION OF ALL SUCH FEATURES MUST BE DETERMINED AND VERIFIED IN THE FIELD BY APPROPRIATE AUTHORITIES PRIOR TO CONSTRUCTION @ CALL-BEFORE-YOU-DIG 1-800-922-4455.
- REFERENCE IS MADE TO PLAN ENTITLED "PROPERTY , TOPOGRAPHIC & ALTA/ACSM LAND TITLE SURVEY" PREPARED FOR TRINITY WASHINGTON VILLAGE LIMITED PARTNERSHIP AND THE NORWALK HOUSING AUTHORITY, PREPARED BY WILLIAM W. SEYMOUR & ASSOCIATES P.C., DATED SEPTEMBER 4, 2013.
- THE CONTRACTOR SHALL ADJUST THE TOP OF FRAME/GRATE ELEVATIONS OF ALL EXISTING AND PROPOSED WATER MANHOLES, WATER GATES, GAS GATES, VALVE COVERS AND APPURTENANCES, WITHIN THE PROJECT LIMIT LINE TO MEET THE PROPOSED
- 4. THE CONTRACTOR SHALL COORIDINATE/VERIFY THE EXACT SIZES, LOCATIONS, ELEVATIONS, OF ALL PROPOSED BUILDING'S UTILITY SERVICES WITH THE PROJECT MECHANICAL, ELECTRICAL AND PLUMBING DRAWINGS PRIOR TO ANY CONSTRUCTION
- 5. THE CONTRACTOR SHALL COORDINATE HIS WORK WITH THE WORK DONE BY THE RESPECTIVE UTILITY COMPANIES.
- 6. FOR INFORMATION ON THE PRIMARY ELECTRICAL WIRING AND THE SECONDARY ELECTRICAL CONDUITS, WIRING, AND MATERIALS - SEE PROJECT ELECTRICAL DRAWINGS.
- 10. WATER AND FIRE PROTECTION SERVICES AND HYDRANT ASSEMBLY SHALL CONFORM TO THE REQUIREMENTS OF SOUTH NORWALK ELECTRIC AND WATER. CONTRACTOR SHALL COORDINATE ALL WATER MAIN TAPS WITH SOUTH NORWALK ELECTRIC AND WATER.
- 11. TRANSFORMER PADS SHALL BE CONSTRUCTED ABOVE THE BASE FLOOD ELEVATION AND FLOOD PROOFED WITH A PASSIVE SYSTEM.
- 12. VERTICAL DATUM: NAVD88
- 13. SEE LANDSCAPE ARCHITECTS PLAN FOR SITE LIGHTING.

EXISTING

**HYDRANT** 

GAS MAIN

**GAS GATE** 

GAS METER

LIGHT POLE

UTILITY POLE

STORM SEWER

STORM MANHOLE

CATCH BASIN

TEL-DATA - BURIED

TEL-DATA MANHOLE

ELECTRICAL - BURIED

**ELECTRICAL MANHOLE** 

ELECTRICAL HANDHOLE

----

GM n

21. THE EXCAVATION, HANDLING, AND MANAGEMENT OF ALL SITE SOILS, INCLUDING THE ON-SITE REUSE OF EXISTING SITE SOILS TO THE FULLEST EXTENT FEASIBLE, SHALL BE PERFORMED IN ACCORDANCE WITH THE EARTHWORK SPECIFICATION SECTION 02300 AND THE SOIL MANAGEMENT PLAN PREPARED FOR USE ON THIS PROJECT, PURSUANT TO THE STATE OF CONNECTICUT REMEDIATION STANDARD REGULATIONS (RSRS). LAWN/LANDSCAPED AREAS OF THE SITE NOT COVERED BY THE PROPOSED BUILDINGS, CONCRETE OR PAVEMENT SHALL BE COVERED BY A GEOTEXTILE MARKER BARRIER AND A MINIMUM 4-FOOT SURFICIAL THICKNESS OF "CLEAN" SOIL, MEETING THE CT RSRS, AT FINISHED GRADE.

PROPOSED

\*\*

## Washington Village Phase 1

## 13 Day Street Building A

Norwalk, CT

Trinity Washington Village Limited Partnership

the Norwalk Housing Authority




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MARK	DATE	DESCRIPTION
MADIZ	DATE	DECODIDATION
1	09-19-2013	CAM/ SPECIAL PERMIT
2	11-18-2013	40% CHFA
3	06-13-2014	PRICING
4	09-15-2014	PERMIT/ PRICING

PROJECT NO.: 10071 DRAWN BY: MDS CHECKED BY: AJM

SHEET TITLE

SITE UTILITY PLAN

#### SITE SOIL EROSION AND SEDIMENTATION CONTROL PLAN NOTES

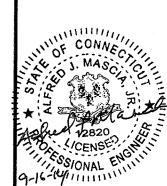- 1. REFERENCE IS MADE TO PLAN ENTITLED "PROPERTY, TOPOGRAPHIC & ALTA/ACSM LAND TITLE SURVEY" PREPARED FOR TRINITY WASHINGTON VILLAGE LIMITED PARTNERSHIP AND THE NORWALK HOUSING AUTHORITY, PREPARED BY WILLIAM W. SEYMOUR & ASSOCIATES P.C., DATED SEPTEMBER 4, 2013.
- 2. CONTRACTOR SHALL CONTACT "CALL BEFORE YOU DIG" (1-800-922-4455) AT LEAST 48 HOURS PRIOR TO ANY EXCAVATION
- UNDERGROUND UTILITY, STRUCTURE AND FACILITY LOCATIONS DEPICTED HEREON HAVE BEEN COMPILED, IN PART, FROM RECORD MAPPING AND OTHER DATA SUPPLIED BY THE RESPECTIVE UTILITY COMPANIES, GOVERNMENTAL AGENCIES AND/OR OTHER SOURCES. THESE LOCATIONS MUST BE CONSIDERED APPROXIMATE IN NATURE. ADDITIONALLY, OTHER SUCH DATA MAY EXIST ON SITE, THE EXISTENCE OF WHICH ARE UNKNOWN TO TIGHE & BOND. THE EXISTENCE, SIZE AND LOCATION OF ALL SUCH FEATURES MUST BE DETERMINED AND VERIFIED IN THE FIELD BY APPROPRIATE AUTHORITIES PRIOR TO CONSTRUCTION @ CALL-BEFORE-YOU-DIG 1-800-922-4455.
- 4. ALL SEDIMENTATION AND EROSION CONTROL MEASURES SHALL BE IN ACCORDANCE WITH THE STANDARDS AND SPECIFICATIONS OF THE "2002 CONNECTICUT GUIDELINES FOR SOIL EROSION AND SEDIMENT CONTROL" DEP BULLETIN NO 34, AND ALL AMENDMENTS AND ADDENDA THERETO AS PUBLISHED BY THE CONNECTICUT DEPARTMENT OF ENVIRONMENTAL
- 5. LAND DISTURBANCE SHALL BE KEPT TO THE MINIMUM NECESSARY FOR CONSTRUCTION
- 6. ALL EROSION CONTROL MEASURES SHALL BE INSTALLED AS SHOWN ON THE PLANS AND ELSEWHERE AS ORDERED BY THE OWNER'S REPRESENTATIVE, OR THE CITY OF NORWALK
- ALL CATCH BASINS SHALL BE PROTECTED WITH SILT SACKS, HAYBALE RING, SILT FENCE OR BLOCK AND STONE INLET PROTECTION THROUGHOUT THE CONSTRUCTION PERIOD AND UNTIL ALL DISTURBED AREAS ARE THOROUGHLY STABILIZED.
- 8. WHEREVER POSSIBLE, EROSION AND SEDIMENT CONTROL MEASURES SHALL BE INSTALLED PRIOR TO CONSTRUCTION.
- 9. ADDITIONAL CONTROL MEASURES SHALL BE INSTALLED DURING CONSTRUCTION PERIOD AS ORDERED BY THE OWNER'S REPRESENTATIVE, OR THE CITY OF NORWALK.
- 10. ALL SEDIMENTATION AND EROSION CONTROL MEASURES SHALL BE MAINTAINED IN EFFECTIVE CONDITION THROUGHOUT THE CONSTRUCTION PERIOD.
- 11. SEDIMENT REMOVED SHALL BE DISPOSED OF LEGALLY OFFSITE.
- 12. THE CONTRACTOR SHALL BE RESPONSIBLE FOR CONSTRUCTION AND MAINTENANCE OF ALL EROSION CONTROL MEASURES THROUGHOUT THE CONSTRUCTION PERIOD.
- 13. THE CONTRACTOR SHALL MAINTAIN A SUPPLY OF SILT FENCE/HAYBALES AND ANTI-TRACKING CRUSHED STONE ON-SITE FOR EMERGENCY REPAIRS.
- 14. THE CONTRACTOR SHALL UTILIZE APPROVED METHODS/MATERIALS FOR PREVENTING THE BLOWING AND MOVEMENT OF DUST
- 15. ALL DRAINAGE STRUCTURES SHALL BE INSPECTED WEEKLY BY THE CONTRACTOR AND CLEANED TO PREVENT THE BUILD-UP OF
- 16. THE CONTRACTOR SHALL CAREFULLY COORDINATE THE PLACEMENT OF EROSION CONTROL MEASURES WITH THE PHASING OF CONSTRUCTION.
- 17. KEEP ALL PAVED ROADWAYS CLEAN. SWEEP BEFORE FORECASTED STORMS OR WEEKLY AS NECESSARY

FROM EXPOSED SOIL SURFACES ONTO ADJACENT PROPERTIES AND SITE AREAS.

- 18. TREAT ALL UNPAVED SURFACES WITH 4" MINIMUM OF TOPSOIL AND SEEDING PRIOR TO FINAL STABILIZATION.
- 19. HAYBALE BARRIERS AND SILT FENCING SHALL BE INSTALLED ALONG THE TOE OF CRITICAL CUT AND FILL SLOPES AS SHOWN ON THE PLANS AND AS DIRECTED BY THE OWNER'S REPRESENTATIVE OR THE CITY OF NORWALK.
- 20. ALL TRUCKS LEAVING THE SITE MUST BE COVERED.
- 21. ALL SEDIMENTATION AND EROSION CONTROLS SHALL BE CHECKED WEEKLY AND AFTER EACH RAINFALL EVENT. NECESSARY REPAIRS SHALL BE MADE WITHOUT DELAY.
- 22. PRIOR TO ANY FORECASTED RAINFALL, EROSION AND SEDIMENT CONTROLS SHALL BE INSPECTED BY A QUALIFIED INSPECTOR AND REPAIRED AS NECESSARY.
- 23. AFTER ALL DISTURBED AREAS HAVE BEEN STABILIZED, EROSION CONTROLS MAY BE REMOVED ONCE AUTHORIZATION TO DO SO HAS BEEN SECURED FROM THE CITY OF NORWALK. DISTURBED AREAS SHALL BE SEEDED AND MULCHED.
- 24. CONTRACTOR IS TO COMPLY WITH THE REQUIREMENTS OF THE SOIL EROSION AND SEDIMENTATION CONTROL PLAN.
- 25. SEE DRAWING C3.2 FOR SOIL EROSION CONTROL NARRATIVE AND DETAILS.
- 26. VERTICAL DATUM: NAVD88
- 27. SOIL STOCKPILE SHALL BE FLOODPROOFED TO ELEVATION 13 NAVD88. THE DETAIL SHEET, C3.2, PRESENTS ONE POTENTIAL METHOD FOR THE CONTRACTOR TO FLOODPROOF THESE STOCKPILES. CONTRACTOR MAY PROPOSE ALTERNATE MEANS OF FLOODPROOFING STOCKPILE, SUBJECT TO APPROVAL BY ENGINEER.
- 28. HAZARDOUS MATERIALS INCLUDING, BUT NOT LIMITED TO, FUELS, MAINTENANCE FLUIDS, AND OTHER MATERIALS MUST BE STORED ABOVE THE 500 YEAR FLOODPLAIN AT THE END OF THE DAY. (EL: 15.0 NAVD88).
- 21. THE EXCAVATION, HANDLING, AND MANAGEMENT OF ALL SITE SOILS, INCLUDING THE ON-SITE REUSE OF EXISTING SITE SOILS TO THE FULLEST EXTENT FEASIBLE, SHALL BE PERFORMED IN ACCORDANCE WITH THE EARTHWORK SPECIFICATION SECTION 02300 AND THE SOIL MANAGEMENT PLAN PREPARED FOR USE ON THIS PROJECT, PURSUANT TO THE STATE OF CONNECTICUT REMEDIATION STANDARD REGULATIONS (RSRS). LAWN/LANDSCAPED AREAS OF THE SITE NOT COVERED BY THE PROPOSED BUILDINGS, CONCRETE OR PAVEMENT SHALL BE COVERED BY A GEOTEXTILE MARKER BARRIER AND A MINIMUM 4-FOOT SURFICIAL THICKNESS OF "CLEAN" SOIL, MEETING THE CT RSRS, AT FINISHED GRADE.

## Washington Village Phase 1

### 13 Day Street **Building A**

Norwalk, CT

Trinity Washington Village Limited Partnership

the Norwalk Housing Authority




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MARK	DATE	DESCRIPTION

PROJECT NO.: 10071

DRAWN BY: MDS CHECKED BY: AJM

SHEET TITLE

SITE SOIL **EROSION AND** SEDIMENT CONTROL PLAN

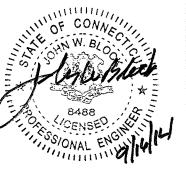C3.1

SITE SOIL EROSION AND SEDIMENTATION CONTROL PLAN LEGEND PROPERTY LINE 

SILT SACK

HAYBALE

CONSTRUCTION ENTRANCE


SILT FENCE

CONSTRUCTION FENCE

CONSTRUCTION GATE

HAYBALE BARRIER

TEMPORARY SOIL STOCKPILE AREA

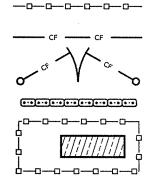

#### SOIL EROSION AND SEDIMENTATION CONTROL NARRATIVE

THE PROJECT PROPOSES TO CONSTRUCT A 10 UNIT RESIDENTIAL BUILDING IN NORWALK, CT. THE PROJECT SITE IS BOUNDED BY HANFORD PLACE TO THE SOUTH, DAY STREET TO THE EAST, #11 HANFORD PLACE TO THE WEST, #10, #12 AND #14 ELIZABETH STREET TO THE NORTH.

THE PROPOSED PROJECT WILL INCLUDE THE CONSTRUCTION OF THE RESIDENTIAL BUILDING, A 20 CAR PARKING LOT, RETAINING WALLS, CURBING, SIDEWALKS, LANDSCAPE AND LIGHTING. PROPOSED BUILDING UTILITIES SUCH AS DOMESTIC WATER, FIRE PROTECTION, TELECOMMUNICATIONS, ELECTRICAL, NATURAL GAS, AND SANITARY SEWER WILL BE PROVIDED FROM EXISTING MAINS LOCATED IN DAY STREET AND HANFORD PLACE.

STORMWATER MANAGEMENT WILL BE ACCOMMODATED ON-SITE. SURFACE RUNOFF WILL BE COLLECTED AND CONVEYED INTO A WATER QUALITY STRUCTURE AND AN UNDERGROUND INFILTRATION SYSTEM THAT WILL TREAT THE WATER QUALITY VOLUME AND PROVIDE POLLUTANT REMOVAL IN ACCORDANCE WITH THE 2004 CONNECTICUT STORMWATER QUALITY MANUAL.

THE PROJECT IS PROPOSED TO BE CONSTRUCTED IN A SINGLE PHASE. APPROXIMATELY 0.49 ACRES WILL BE DISTURBED.


SOIL EROSION AND SEDIMENTATION CONTROL MEASURES SHALL CONFORM TO THE STANDARDS OUTLINED IN THE CONNECTICUT DEPARTMENT OF ENERGY AND ENVIRONMENTAL PROTECTION (CTDEEP), "2002 CONNECTICUT GUIDELINES FOR SOIL EROSION AND SEDIMENT CONTROL", LATEST REVISION.


#### CONSTRUCTION SEQUENCE

- 1. THE PROPOSED DEVELOPMENT IS ENTITLED "HANFORD PLACE BUILDING A"
- 2. ESTIMATED PROJECT TIMELINE:
- PROJECT START: FALL 2014
- PROJECT COMPLETION: FALL 2015
- 3. THE SITE IS LOCATED AT 13 DAY STREET NORWALK, CONNECTICUT.

#### CONSTRUCTION SEQUENCE

- 1. FLAG THE LIMITS OF CONSTRUCTION NECESSARY TO FACILITATE THE PRECONSTRUCTION MEETING.
- 2. HOLD PRECONSTRUCTION MEETING WITH THE CITY, THE OWNERS REPRESENTATIVE AND THE ENGINEER. (REMEMBER TO CALL BEFORE YOU DIG 1-800-922-4455).
- 3. FLAG REMAINDER OF THE LIMITS OF CONSTRUCTION AND TREE PROTECTION ZONES.
- 4. INSTALL THE CONSTRUCTION ENTRANCE.
- 5. INSTALL PERIMETER EROSION AND SEDIMENT CONTROLS AND TREE PROTECTION DEVICES IN ACCORDANCE WITH THE SESC PLAN.
- 6. CUT ANY TREES WITHIN THE DEFINED CLEARING LIMITS AND REMOVE CUT WOOD. CHIP BRUSH AND SLASH, STOCKPILE CHIPS FOR FUTURE USE OR REMOVE OFF SITE.
- 7. CONSTRUCT SETTLING BASINS AND/OR SUMP PITS, AS REQUIRED.
- 8. STRIP AND STOCKPILE ALL TOPSOIL THAT IS WITHIN THE FOOTPRINT OF THE CONSTRUCTION SITE AND REFERENCE STOCKPILE MANAGEMENT FOR EROSION AND SEDIMENT CONTROLS. (SEE 2002 CT GUIDELINES FOR SOIL EROSION AND SEDIMENT CONTROL CHAPTER 4, PART II ON STOCKPILE MANAGEMENT). EITHER REMOVE TREE STUMPS TO AN APPROVED DISPOSAL SITE OR CHIP IN PLACE AS INDICATED ON THE PLANS.
- 9. MAKE ALL CUTS AND FILLS REQUIRED. ESTABLISH THE SUBGRADE FOR THE TOPSOIL AREAS, AND PARKING AS REQUIRED AND BENCH THE BUILDING TO A SUBGRADE. ALLOW A REASONABLE AMOUNT OF AREA AROUND THE FOOTPRINT OF THE BUILDING FOR THE CONSTRUCTION ACTIVITIES.
- 10. BEGIN CONSTRUCTION OF THE BUILDING.
- 11. PRIOR TO INSTALLING SURFACE WATER CONTROLS SUCH AS TEMPORARY DIVERSIONS AND STONE DIKES, INSPECT EXISTING CONDITIONS TO ENSURE DISCHARGE LOCATIONS ARE STABLE. IF NOT STABLE, REVIEW DISCHARGE CONDITIONS WITH THE DESIGN ENGINEER AND IMPLEMENT ADDITIONAL STABILIZATION MEASURES PRIOR TO INSTALLING WATER SURFACE CONTROLS.
- 12. INSTALL ALL SANITARY SEWERS, DRAINAGE SYSTEMS AND UTILITIES TO WITHIN 5 FEET OF THE BUILDING OR AS OTHERWISE MODIFIED BY THE DESIGN ENGINEER TO ADJUST FOR UNFORESEEN SITE CONDITIONS.
- 13. PREPARE SUB-BASE, SLOPES, PARKING AREAS AND ANY OTHER AREA OF DISTURBANCE FOR FINAL GRADING.
- 14. INSTALL PROCESS AGGREGATE IN PARKING AREAS.
- 15. PLACE TOPSOIL WHERE REQUIRED. COMPLETE THE PERIMETER LANDSCAPE PLANTINGS.
- 16. FINE GRADE, RAKE, SEED AND MULCH TO WITHIN 2 FEET OF THE CURBING.
- 17. UPON SUBSTANTIAL COMPLETION OF THE BUILDING, COMPLETE THE BALANCE OF SITE WORK AND STABILIZATION OF ALL OTHER DISTURBED AREAS. INSTALL FIRST COURSE OF PAVING.
- 18. WHEN ALL OTHER WORK HAS BEEN COMPLETED, REPAIR AND SWEEP ALL PAVED AREAS FOR THE FINAL COURSE OF PAVING. INSPECT THE DRAINAGE SYSTEM AND CLEAN AS NEEDED.
- 19. INSTALL FINAL COURSE OF PAVEMENT.
- 20. AFTER SITE IS STABILIZED REMOVE TEMPORARY EROSION AND SEDIMENT CONTROLS (E.G. GEOTEXTILE SILT FENCES).
- 21. THE EXCAVATION, HANDLING, AND MANAGEMENT OF ALL SITE SOILS, INCLUDING THE ON-SITE REUSE OF EXISTING SITE SOILS TO THE FULLEST EXTENT FEASIBLE, SHALL BE PERFORMED IN ACCORDANCE WITH THE EARTHWORK SPECIFICATION SECTION 02300 AND THE SOIL MANAGEMENT PLAN PREPARED FOR USE ON THIS PROJECT, PURSUANT TO THE STATE OF CONNECTICUT REMEDIATION STANDARD REGULATIONS (RSRS). LAWN/LANDSCAPED AREAS OF THE SITE NOT COVERED BY THE PROPOSED BUILDINGS, CONCRETE OR PAVEMENT SHALL BE COVERED BY A GEOTEXTILE MARKER BARRIER AND A MINIMUM 4-FOOT SURFICIAL THICKNESS OF "CLEAN" SOIL, MEETING THE CT RSRS, AT FINISHED GRADE.

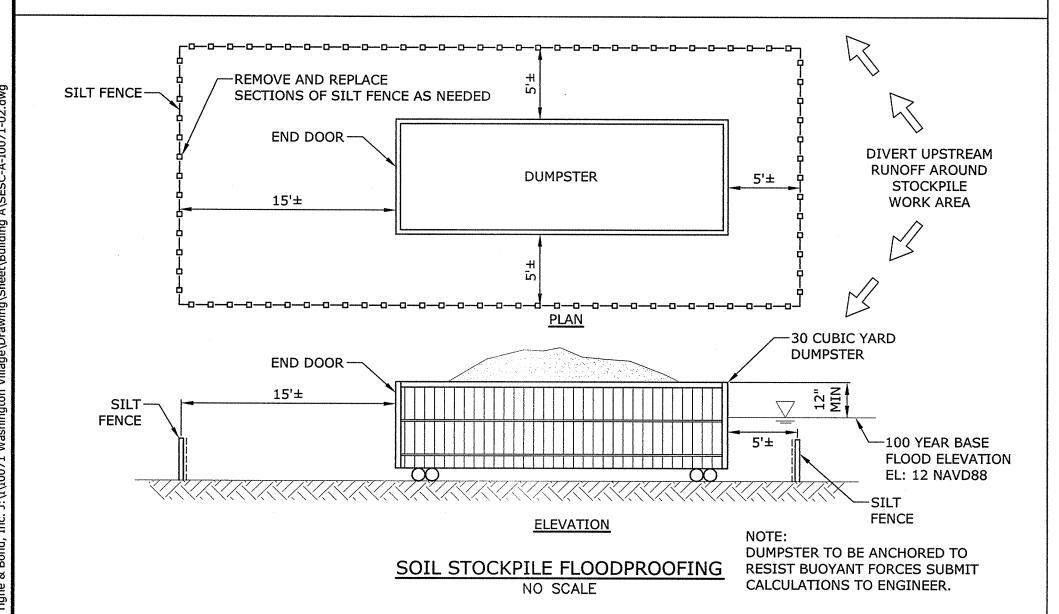

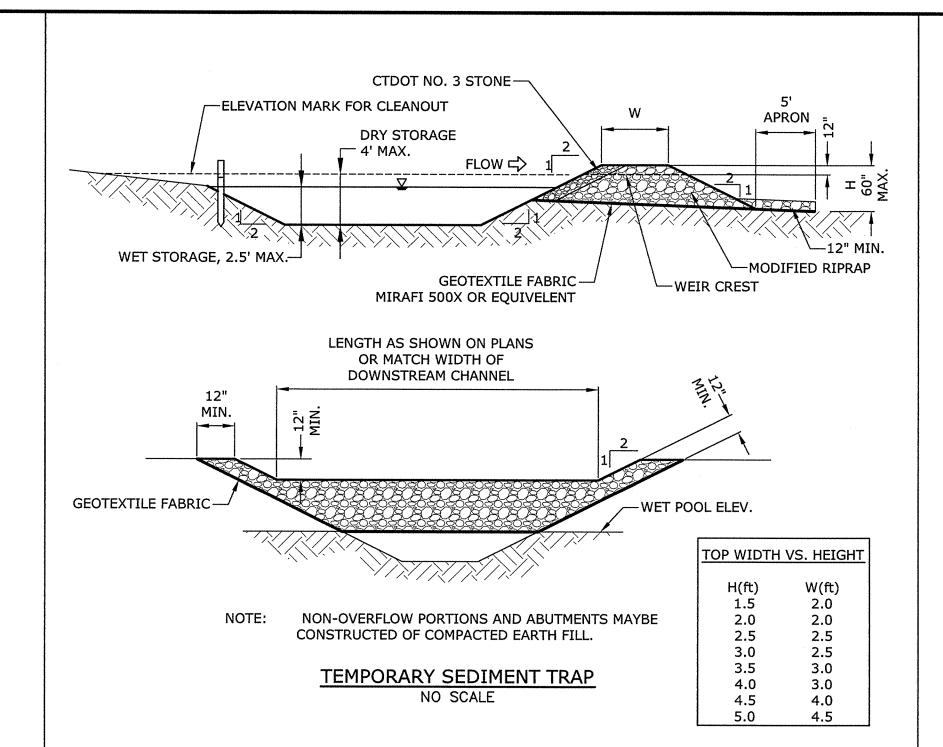

MIRAFI 100X OR

CLIPS @ 4" O.C.,

**ALTERNATING** 

**ORIENTATION** 

FLOW

-ANCHOR FABRIC WITH CRUSHED STONE OR

1.5" SQUARE HARD WOOD

POSTS 8'-0" O.C.

MAXIMUM


SILT FENCE

NO SCALE

**EQUIVALENT FILTER** 

**FABRIC SECURED TO** 

POSTS WITH METAL

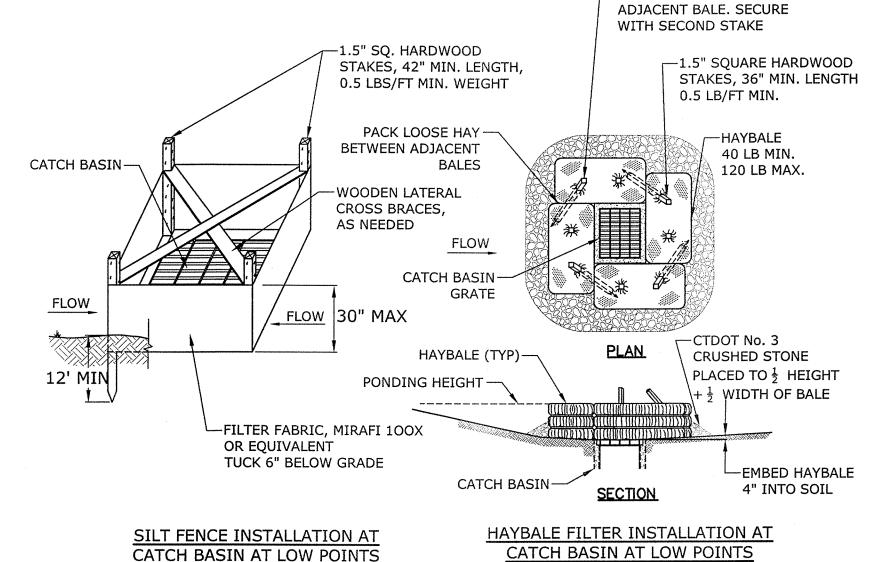

CATCH BASIN EROSION CONTROL


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- ANGLE FIRST STAKE INTO


DUMP STRAP


1" REBAR FOR BAG

REMOVAL FROM INLET

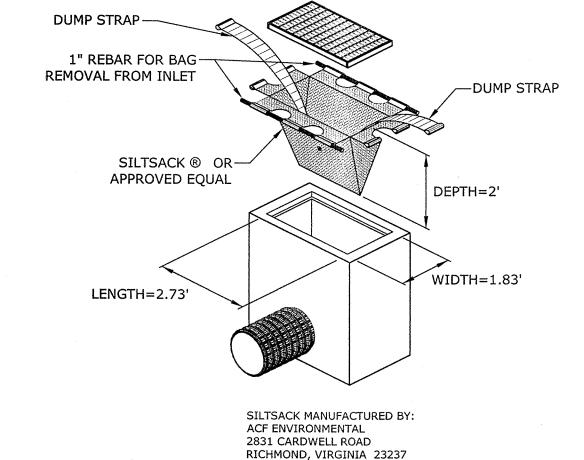

SILTSACK®

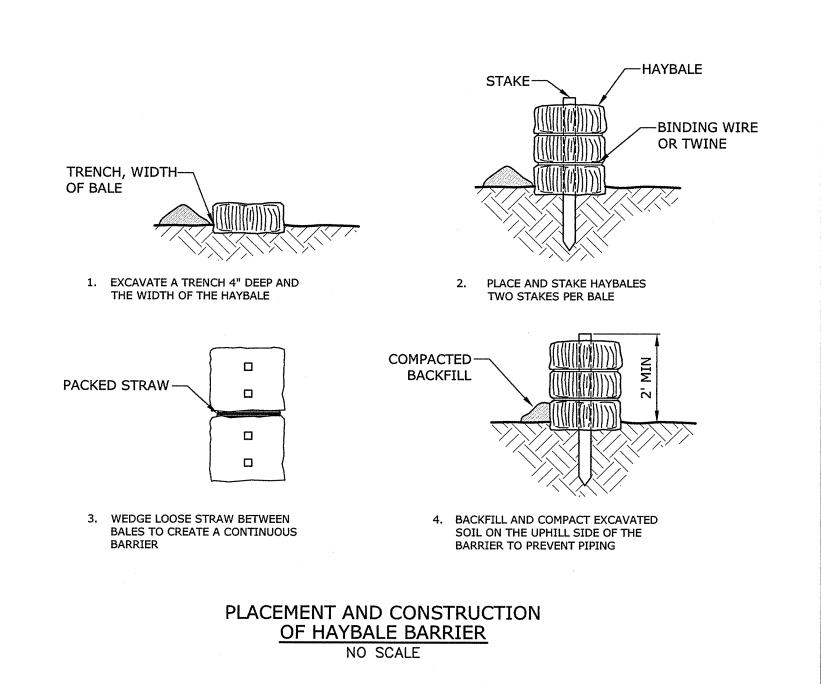

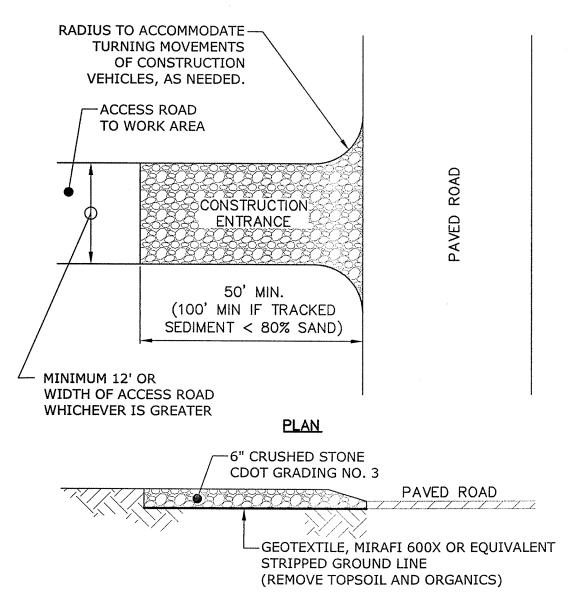

ELEVATION

CONSTRUCTION ENTRANCE


NO SCALE

### Washington Village Phase 1

## 13 Day Street Building A

Norwalk, CT

Trinity Washington Village Limited Partnership &

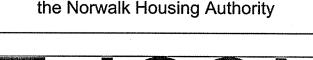



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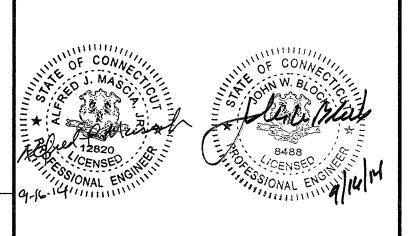
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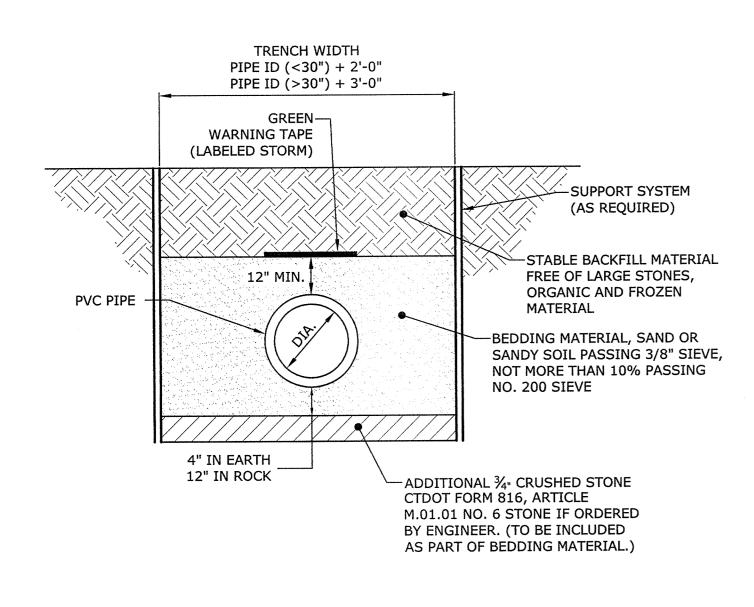
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PROJECT NO.: 10071
DRAWN BY: MDS
CHECKED BY: AJM

SHEET TITLE


SOIL EROSION
AND
SEDIMENT CONTROL
NARRATIVE AND
DETAILS


C3.2



P.V.C. TRENCH BEDDING - STORM DRAINAGE

NO SCALE

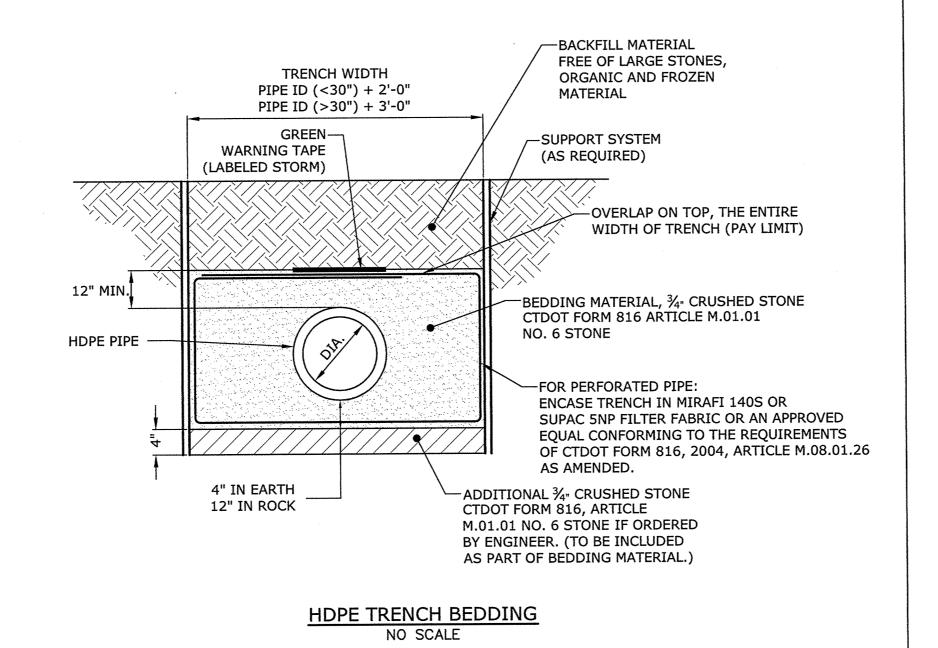

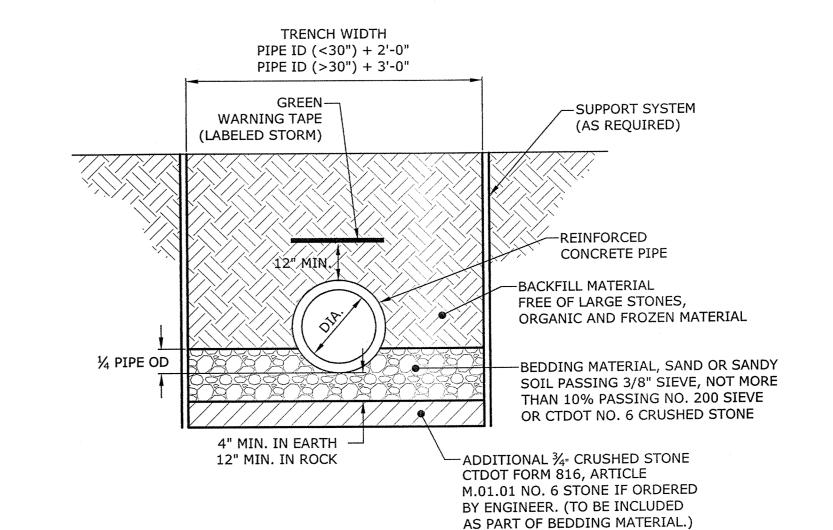

CIRCULAR R.C.P. TRENCH BEDDING NO SCALE

## Washington Village Phase 1

13 Day Street Building A

Norwalk, CT

Trinity Washington Village Limited Partnership the Norwalk Housing Authority




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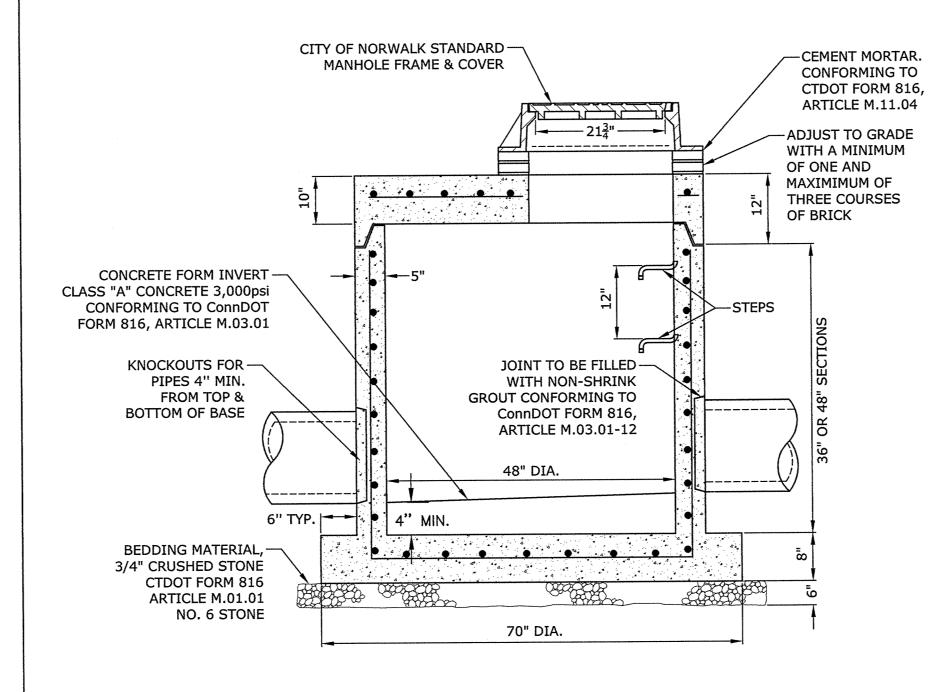
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#### SECTION A-A

MANHOLE FRAMES & COVERS SHALL BE PATTERN #1007D AS MANUFACTURED BY THE CAMPBELL FOUNDRY COMPANY OF NORTH HAVEN, CONNECTICUT, OR APPROVED EQUAL.


> CITY OF NORWALK MANHOLE FRAME AND COVER NO SCALE



#### NOTES

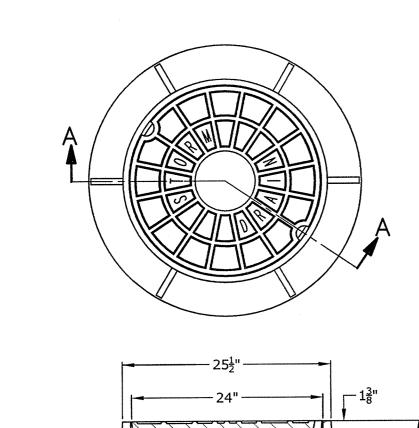- 1. REINFORCING ASTM A185 AREA 48" DIA. 0.12 SQ. IN./V.F., AREA 60" DIA. 0.17 SQ. IN./V.F.
- REINFORCE BELL & SPIGOT.
- 2. CONCRETE COMPRESSIVE STRENGTH: 5,000 psi 28 DAYS 3. MANHOLE STEP TO CONFORM TO OSHA AND ASTM SPECIFICATIONS.
- 4. MONOLITHIC BASE SECTION.


48" DIA. SHALLOW MANHOLE

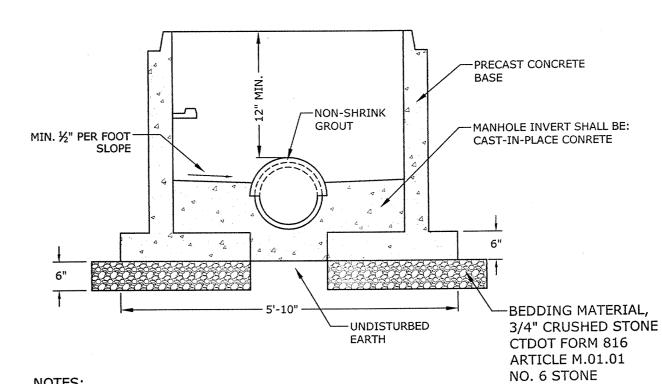

- 1. MINIMUM 4' DIAMETER MANHOLE.
- 2. DOGHOUSE OPENING MAY ONLY BE USED WHEN PLACING A NEW MANHOLE OVER AN EXISTING LINE; OTHERWISE, THE OPENING MUST BE CAST. SIZE, LOCATION AND ANGLE OF ENTRY SHOULD BE AS REQUIRED BY THE PLANS.
- 3. OPENINGS IN PRECAST UNITS ARE TO BE 4" MINIMUM TO 8" MAXIMUM LARGER THAN
- THE OUTSIDE DIAMETER OF THE EXISTING PIPE. 4. TOP HALF OF EXISTING PIPE TO BE REMOVED FOR FULL LENGTH EXPOSED INSIDE
- MANHOLE. EXISTING MAIN TO BE NEATLY CUT ALONG THE SPRING LINE OF THE PIPE. 5. SEE STORM MANHOLE DETAIL FOR ADDITIONAL INFORMATION.

STORM DRAINAGE

DOGHOUSE MANHOLE BASE NO SCALE

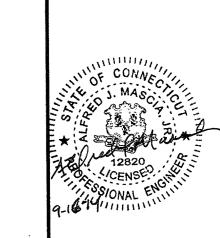

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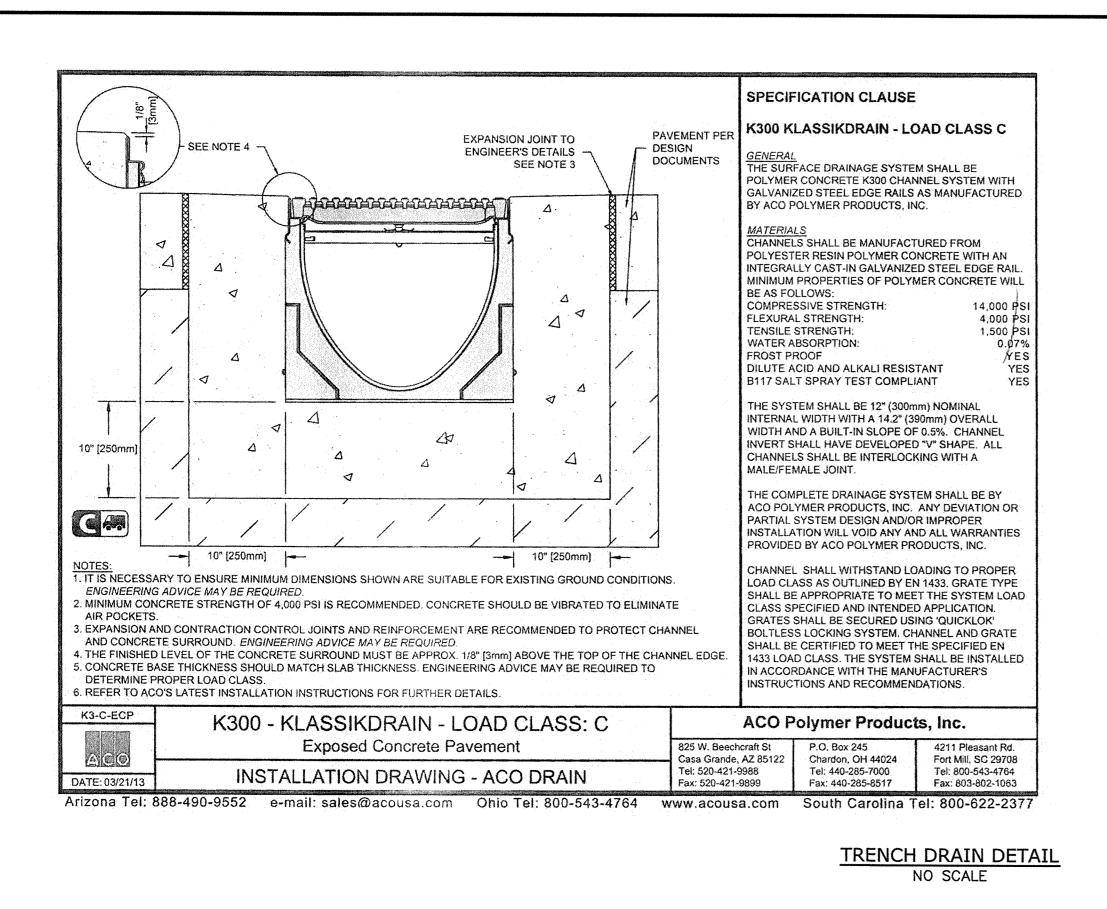
PROJECT NO.: 10071 DRAWN BY: MDS

SHEET TITLE

CHECKED BY: AJM

STORM DRAINAGE **DETAILS** 

C4.1



Type 878Q Longitudinal ductile iron grate (ADA) NE BC QuickLok grate Type 878Q Ductile iron kingludinal grate QuickLok grate removal tori 'QuickLok' locking mechanism ACO QuickLok is a patented boliess locking system, grates minmum time and effort for ease of maintenance. The unique design provides a positive seap down fit. into the locking bas. A stud is fixed to the grate which locks' into the (4) The 'QuickLok' stad is made from - GuickLock locking standess steel and high density nyton, the locking bar and clip are: stanless steel, for use in both ter Size sho part entropients. SPEC Northeast Sales Office West Sales Office P.O. Box 245 P.O. Box 12067 4211 Pleasant Road Chardon, 94 44024 Casa Grande, AZ 83130 For MSL SC 29708 1ei: (440) 285-7000 Far (520) 421-9588 Toll free: (800) 543-4764 Toll free: (808) 490-9552 Fax (440) 285-7005 Fax: (520) 421-9599 Electronic Contact; info@ACGD/am us www.ACGD/am us Apr 13/2

ROOF LEADER
ROOF LEADER TO PVC
DRAIN LINE ADAPTER

45° WYE CONNECTION TO 6" COLLECTOR PIPE
ROOF LEADER DRAIN PIPE

1% SLOPE MIN.

ROOF LEADER DRAIN LINE
NO SCALE

### Washington Village Phase 1

### 13 Day Street Building A

Norwalk, CT

Trinity Washington Village Limited Partnership & the Norwalk Housing Authority

## E ICON ARCHITECTURE

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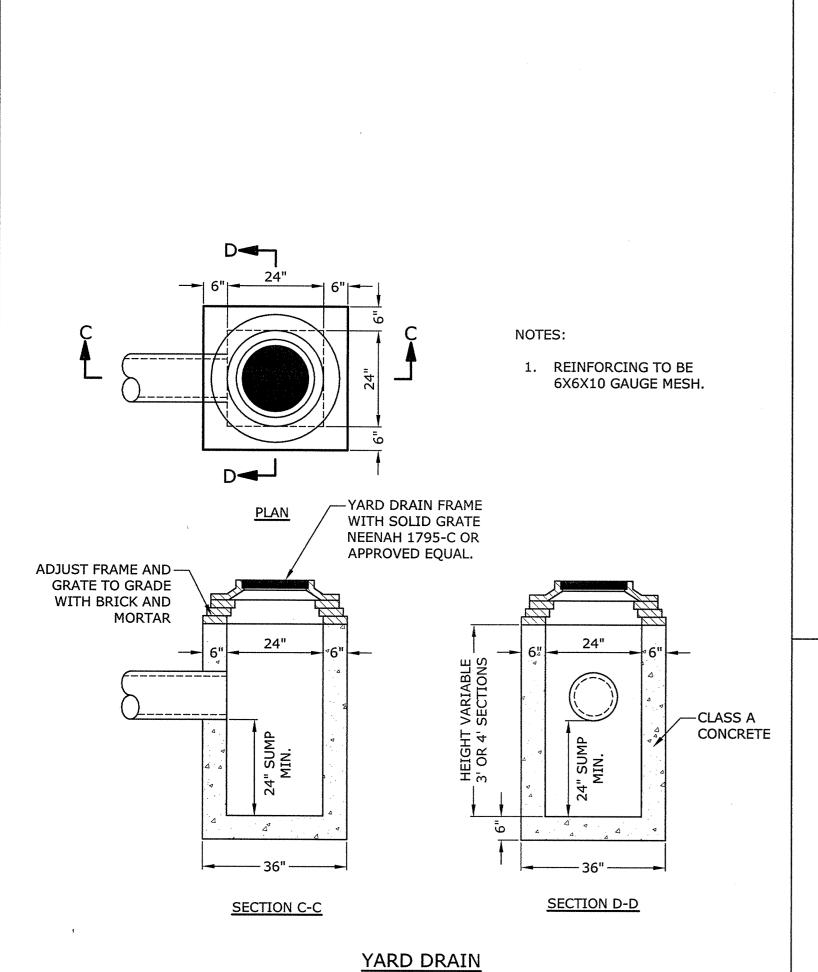
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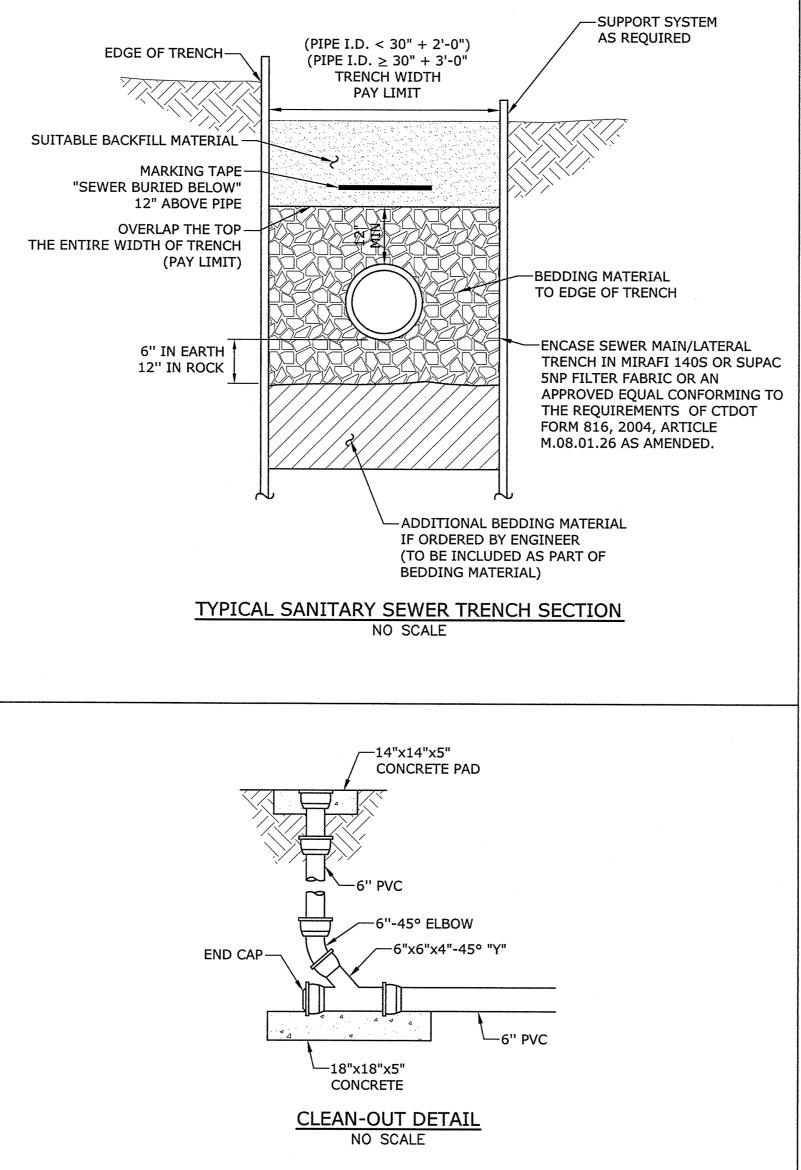
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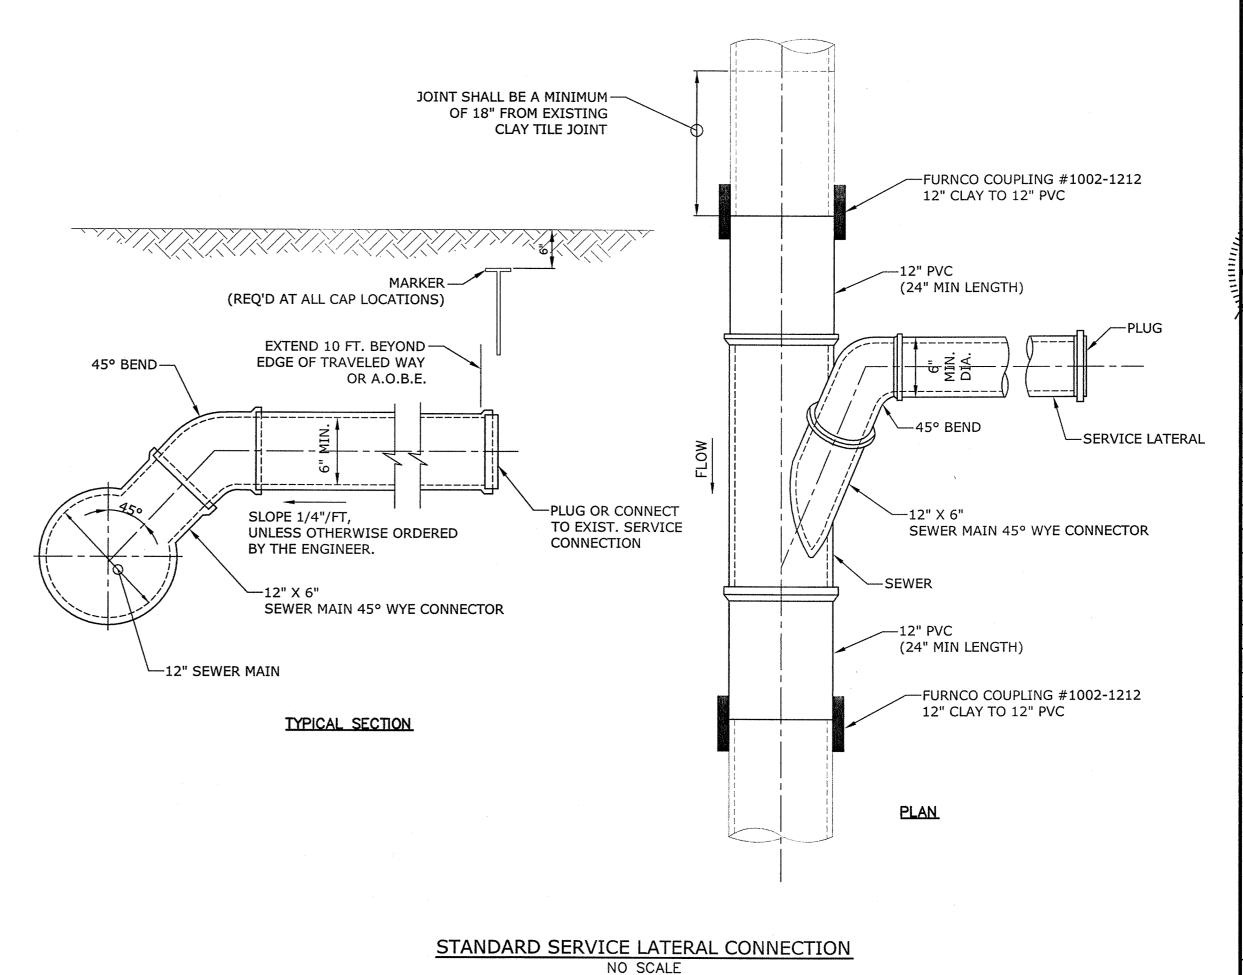
STORM AND SANITARY DETAILS


C4.2



NO SCALE





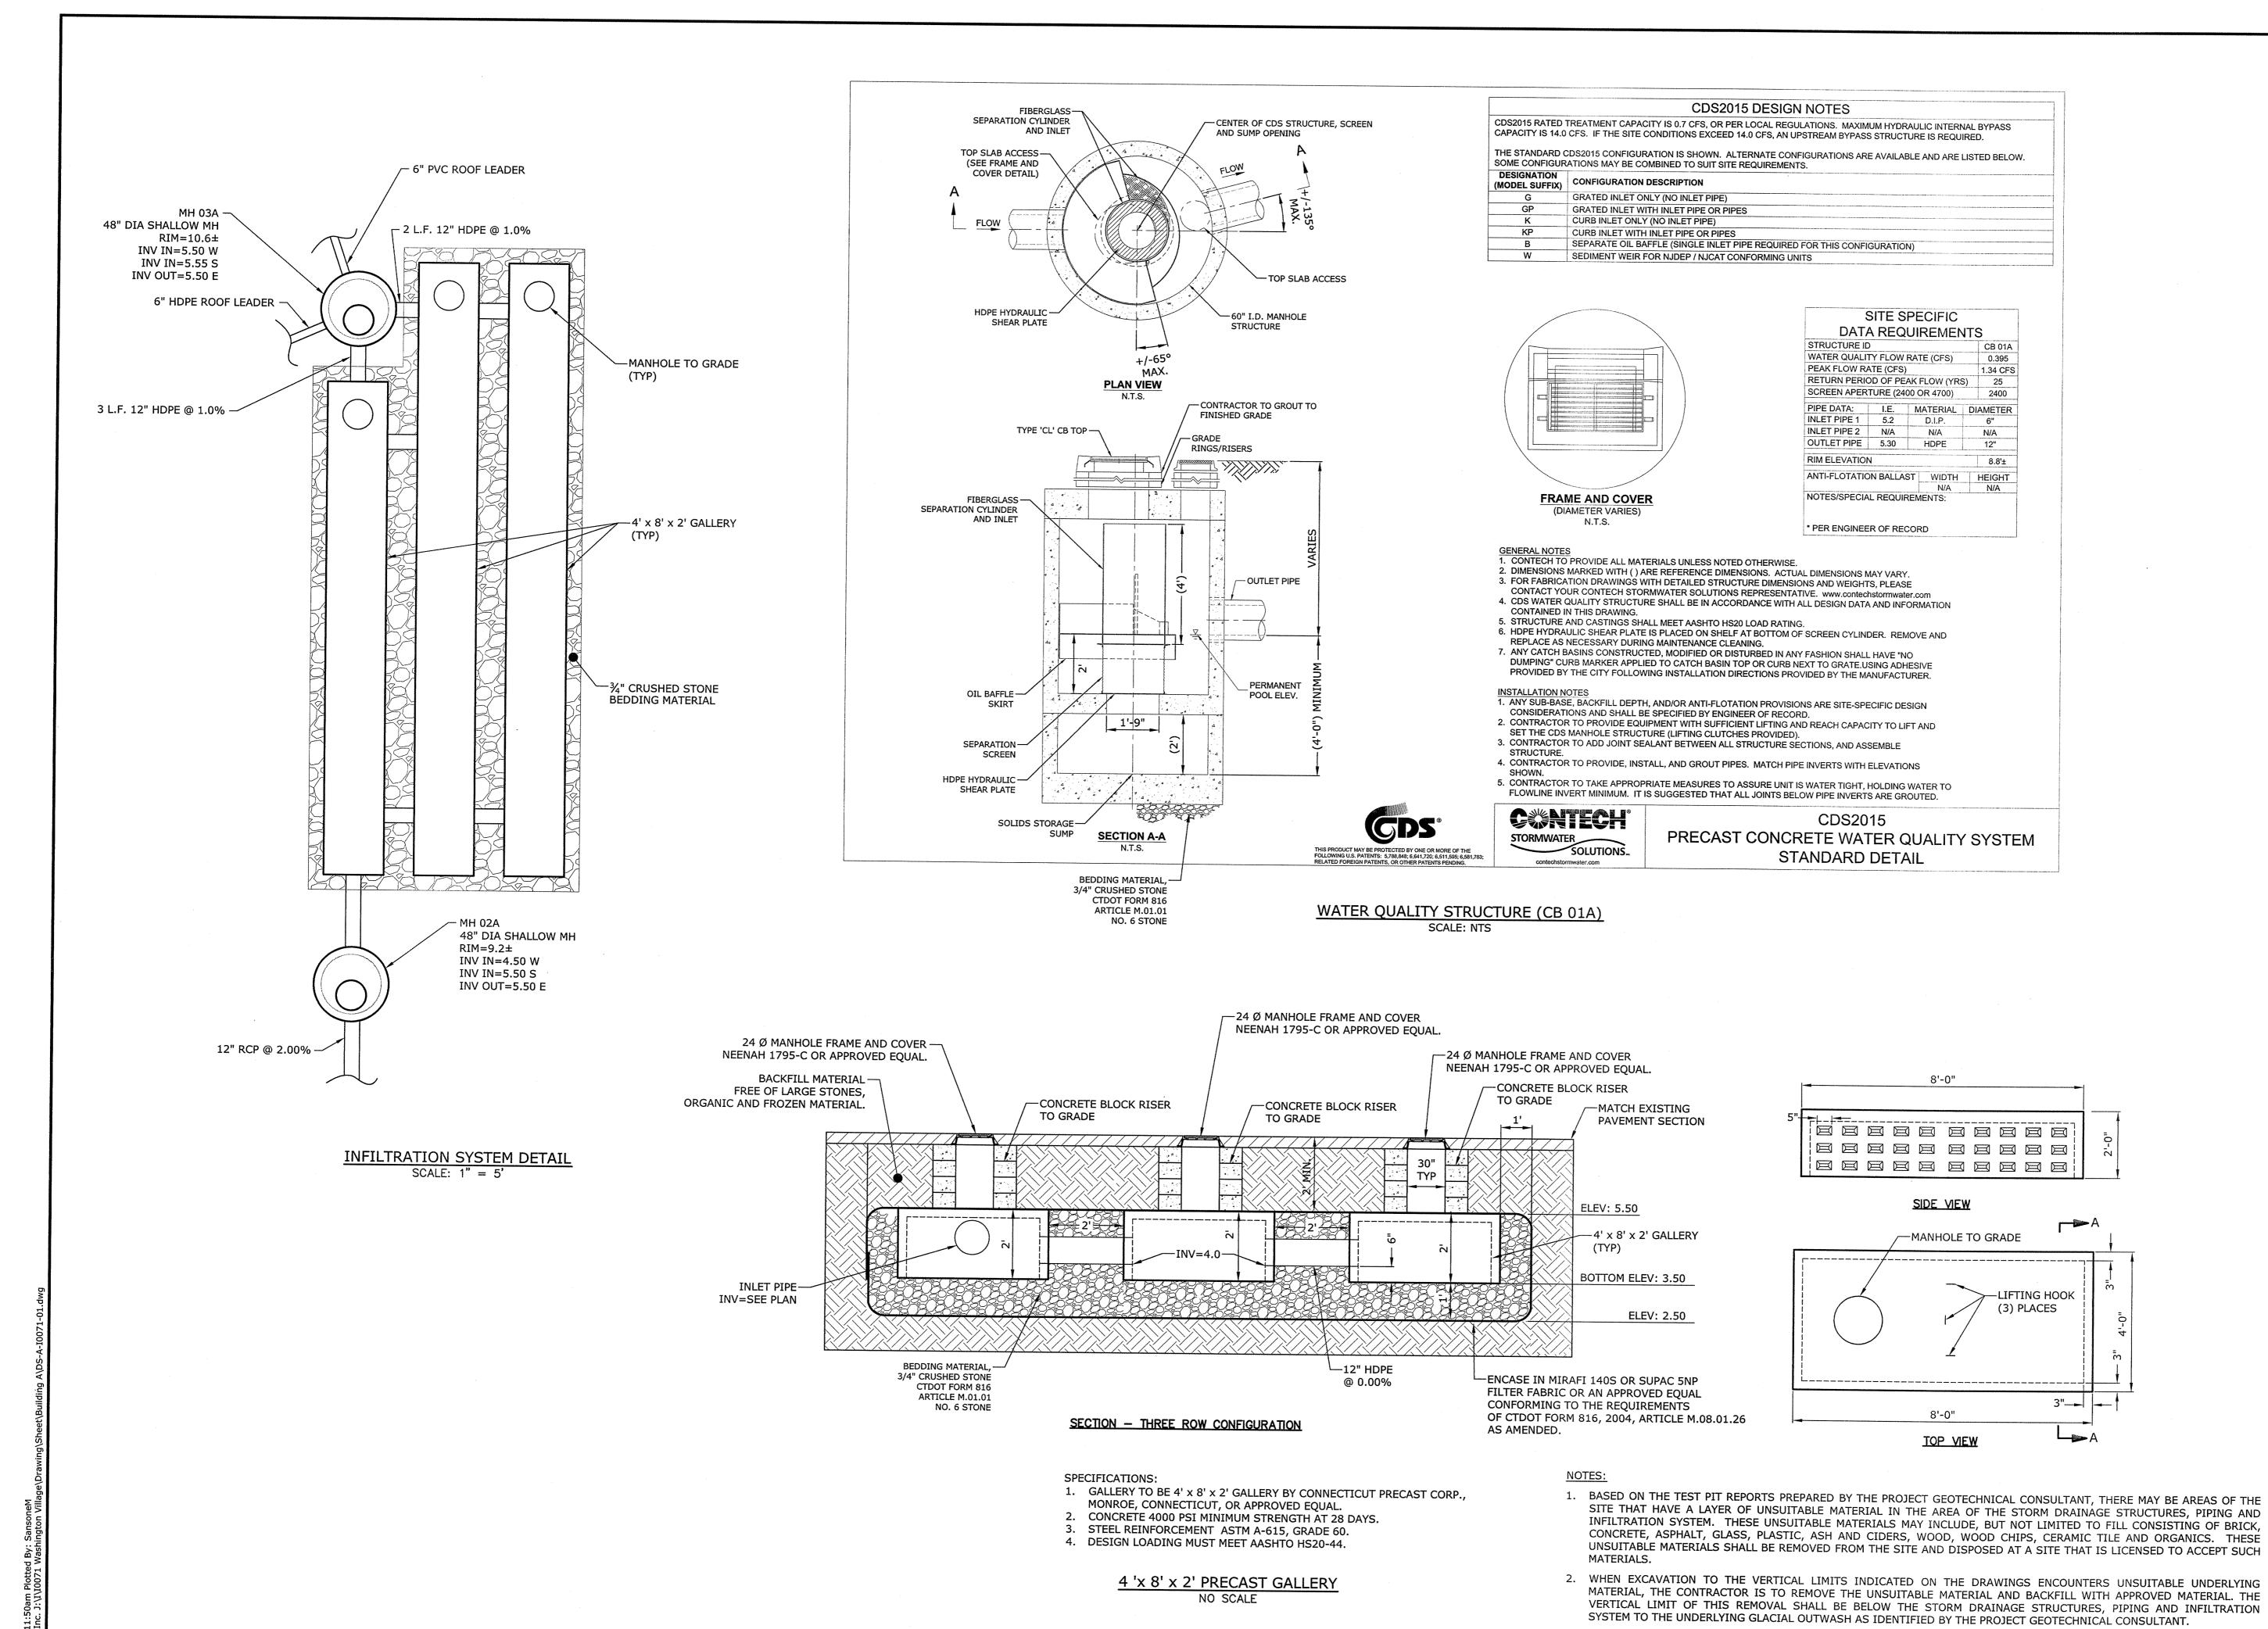

Washington Village Phase 1

## 13 Day Street Building A

Norwalk, CT

Trinity Washington Village Limited Partnership

the Norwalk Housing Authority

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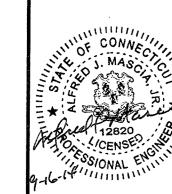
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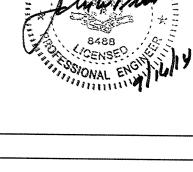
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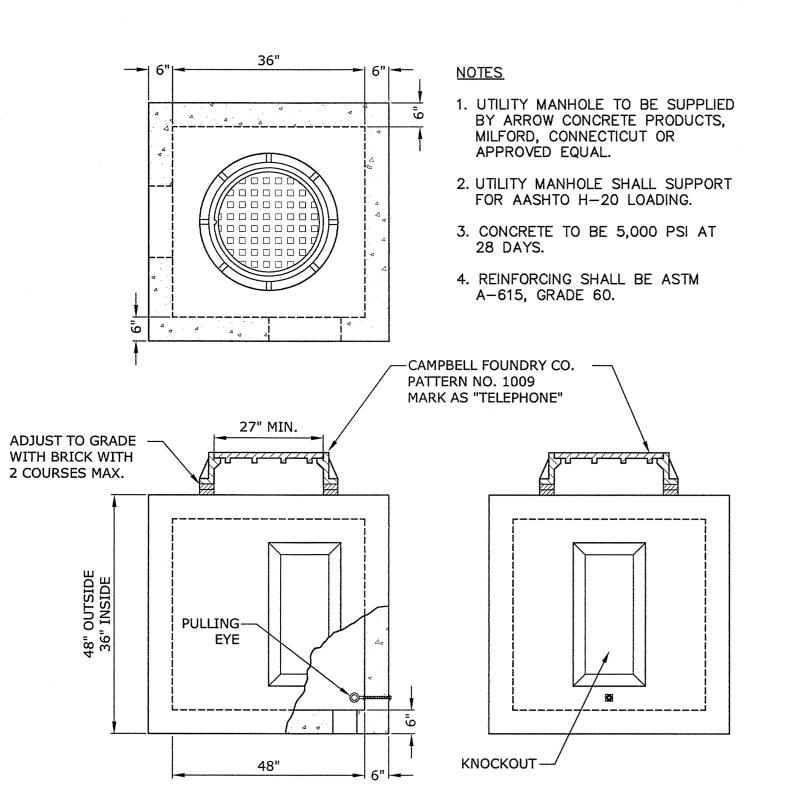
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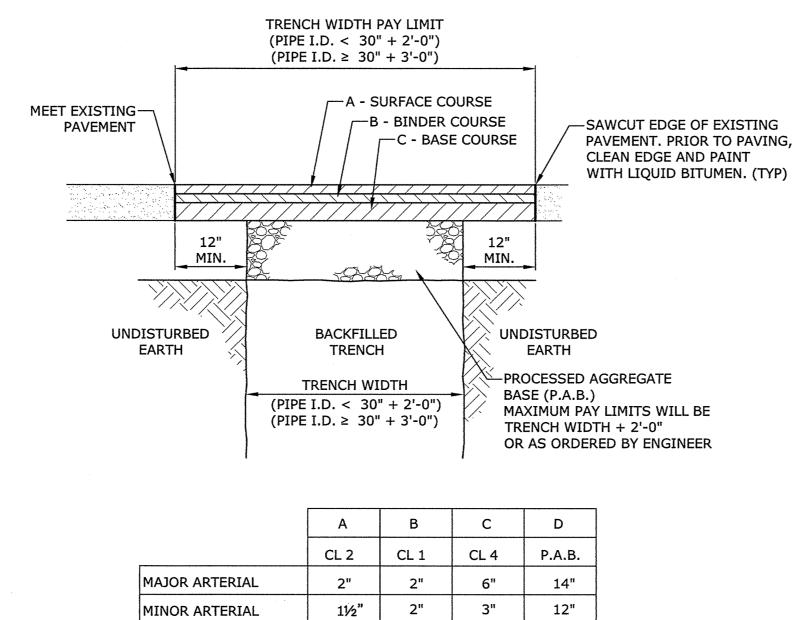
SHEET TITLE

INFILTRATION
SYSTEM DETAILS


74.3

3. WHEN EXCAVATION TO THE HORIZONTAL LIMITS INDICATED ON THE DRAWINGS ENCOUNTERS UNSUITABLE MATERIAL, THE CONTRACTOR IS TO REMOVE THE UNSUITABLE MATERIAL AND BACKFILL WITH APPROVED MATERIAL. THE HORIZONTAL LIMIT OF THIS REMOVAL SHALL BE BELOW AT LEAST 2 (TWO) FEET BEYOND THE STORM DRAINAGE STRUCTURES AND PIPING AND AT LEAST 5 (FIVE) FEET BEYOND THE 34" STONE ENVELOPE SURROUNDING THE INFILTRATION SYSTEM.








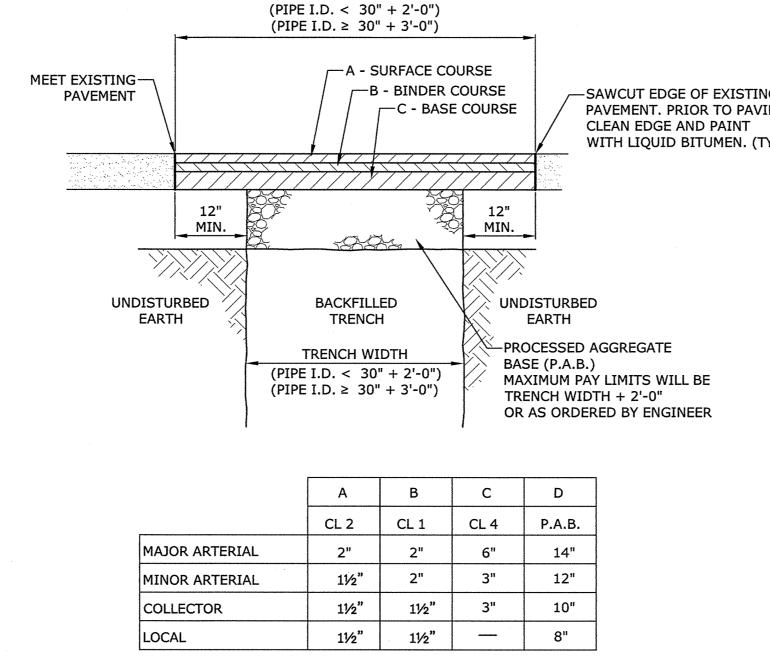

PAVEMENT REPAIR

(CITY OF NORWALK)
NO SCALE

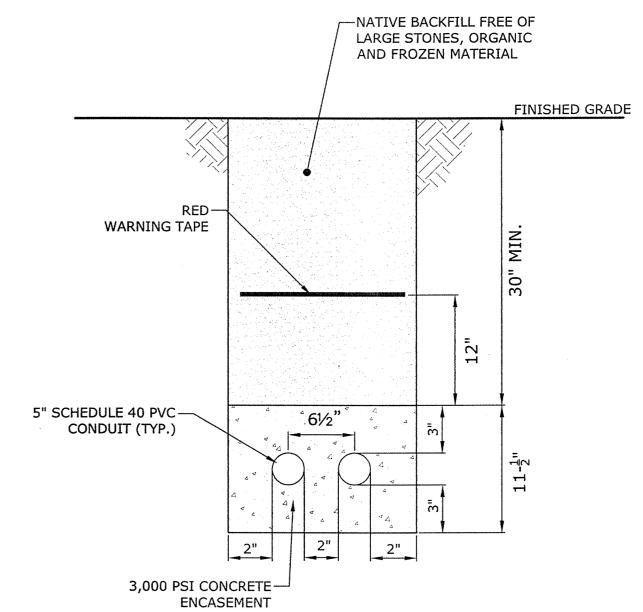



Shelton, CT 06484 (203) 712-1100

617-451-3333

CONSULTANT

STAMP

Washington Village Phase 1

13 Day Street Building A


Norwalk, CT

Trinity Washington Village Limited Partnership

the Norwalk Housing Authority

101 SUMMER ST BOSTON MA 02110

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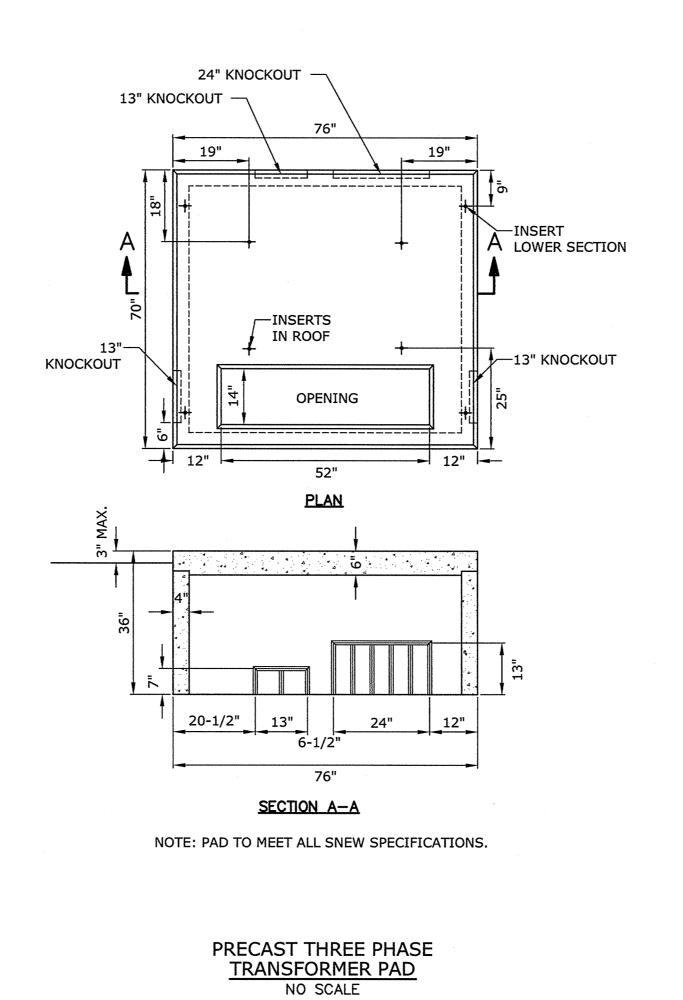


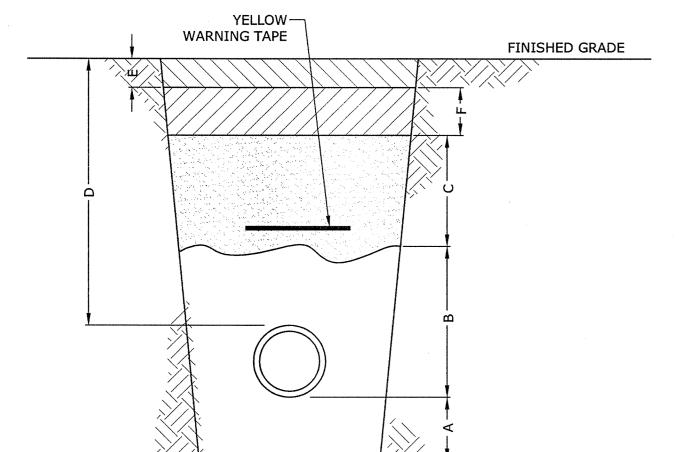
CONCRETE TELEPHONE/C-TV PULL BOX NO SCALE

ITEM	DE	PTH
	NORMAL	ROCK
A CAND DADDING	4114	CII.
A - SAND PADDING	4"*	6"
B - SAND PADDING AS BACKFILL	6" OVER PIPE	6" OVER PIPE
C - REPLACEMENT FILL / SUITABLE BACKFILL	AS REQUIRED	AS REQUIRED
D - COVER	36"*	24"
E - ROAD REPAIR	AS REQUIRED	AS REQUIRED
F - PROCESSED AGGREGATE	AS REQUIRED	AS REQUIRED
*MAY BE LESS DUE TO CONDITIONS (SEE NOTE)		_

- 1. EACH BURIED MAIN SHOULD BE INSTALL WITH 36" COVER TO INSUREADEQUATE COVER FOR SERVICE TEES, VALVES, AND OTHER FITTINGS THAT MAY BE ADDED AT A FUTURE DATE.
- ADDITIONAL COVER SHOULD BE PROVIDED WHERE THE POTENTIAL FOR DAMAGE BY OUTSIDE FORCES IS GREATER THAN NORMAL. CONSIDERATION
  - SHOULD BE GIVEN TO THE FOLLOWING:
  - A. DRAINAGE DITCH CROSSINGS B. OTHER UTILITY CROSSINGS
  - C. LOCATIONS WHERE EROSION DUE TO WATER OR VEHICULAR ACTIVITY MAY AFFECT THE GRADE D. STREET LOCATIONS WHERE FUTURE STREET WORK IS A POSSIBILITY
  - E. REQUIREMENTS OF OTHER REGULATORY AGENCIES
- 3. EACH BURIED MAIN MUST BE INSTALLED WITH A MINIMUM OF 24" COVER. WHERE AN UNDERGROUND STRUCTURE PREVENTS THEINSTALLATION OF THE MAIN WITH THE MINIMUM COVER, THE MAIN MAY BE INSTALLED WITH LESS COVER IF IT IS PROVIDED ADDITIONAL PROTECTION SUCH AS CASINGS TO WITHSTAND ANTICIPATED EXTERNAL

YANKEEGAS GAS MAIN TRENCH BEDDING DETAIL



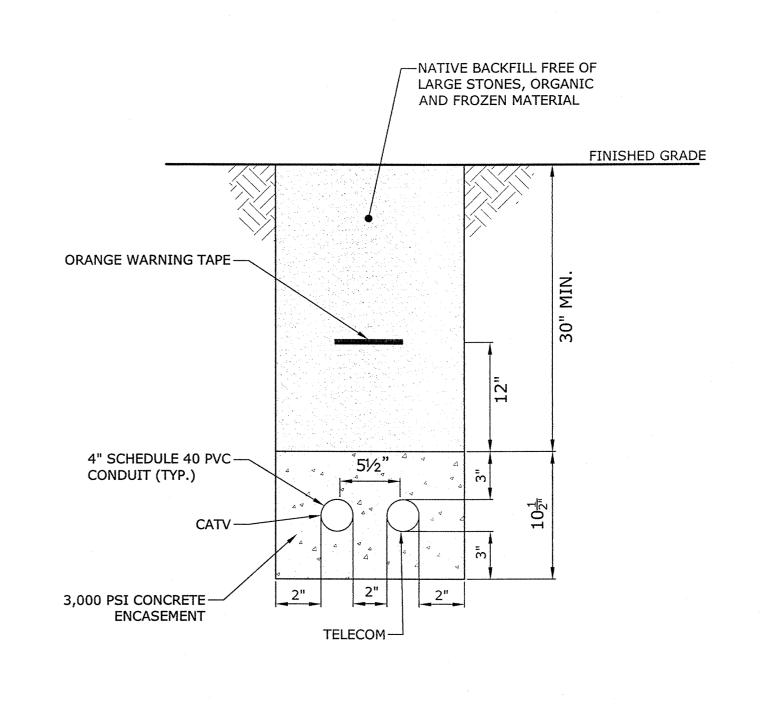

NOTE: MINIMUM CONDUIT RADIUS TO BE 15'-0"


TELECOM/CATV CONDUIT BANK DETAIL NO SCALE

4	09-15-2014	PERMIT/ PRICING
3	06-13-2014	PRICING
2	11-18-2013	40% CHFA
1	09-19-2013	CAM/ SPECIAL PERMIT
MARK	DATE	DESCRIPTION


PROJECT NO.: 10071 DRAWN BY: MDS CHECKED BY: AJM

SHEET TITLE


UTILITY DETAILS

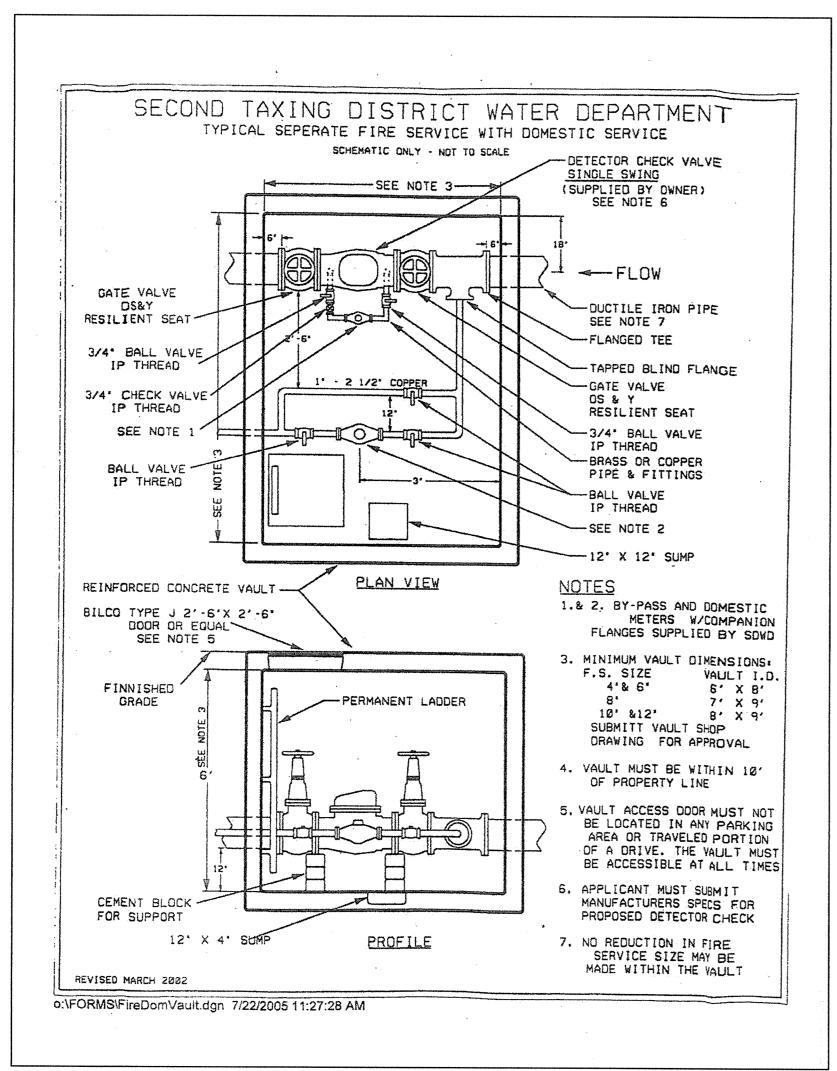

WATER METER VAULT
NO SCALE

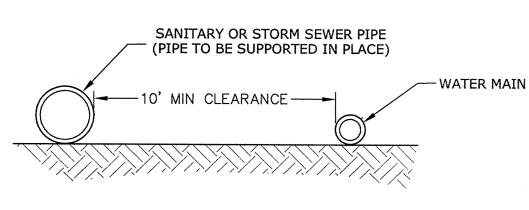

PARALLEL TO WATER MAIN

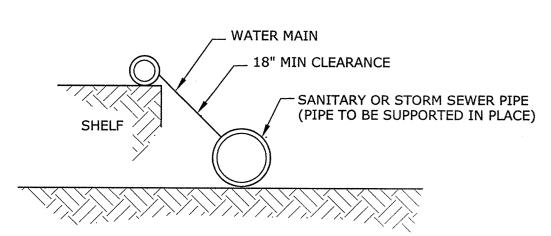

SANITARY OR STORM SEWER PIPE
(PIPE TO BE SUPPORTED IN PLACE)

WATER MAIN

18" MIN CLEARANCE

SANITARY OR STORM SEWER PIPE
(PIPE TO BE SUPPORTED IN PLACE)

SAND CUSHION

WATER MAIN

WATER MAIN

CROSSING UNDER WATER MAIN

CROSSING OVER WATER MAIN

#### CROSSING WATER MAIN

1. IF THE SANITARY SEWER CROSSES LESS THAN 18" ABOVE OR UNDER THE WATER MAIN, THE SANITARY SEWER MUST BE ENCASED IN CONCRETE TO A DISTANCE OF 10 FEET (10') ON BOTH SIDES OF THE WATER MAIN OR BE APPROVED TIGHT JOINTED PIPE AS PER THE STATE OF CONNECTICUT D.O.H.S

#### PARALLEL TO WATER MAIN

2. IF THE SANITARY SEWER IS WITHIN 10 HORIZONTAL FEET (10') OF THE WATER MAIN AND EITHER ABOVE THE WATER MAIN INVERT OR LESS THAN 18 INCHES (18") UNDER THE WATER MAIN, THE SANITARY SEWER MUST BE ENCASED IN CONCRETE OR BE APPROVED TIGHT JOINTED PIPE AS PER THE STATE OR CONNECTICUT D.O.H.S

SEWER PIPE CROSSING DETAIL

NO SCALE

SUBGRADE ELEVATION UNDER PAVEMENT:
SEE TYPICAL ROADWAY/PAVEMENT SECTION
OR PAVEMENT REPAIR DETAIL

BLUE WARNING
TAPE

"IZT UNINGHED OF MATER SERVICE (SEE PLANS FOR SIZING)


└─SAND BEDDING


NOTES:


1. SAND BEDDING MATERIAL TO BE PLACED A MINIMUM OF 1'- 0" OVER THE TOP OF WATER SERVICE.

- 2. BEDDING MATERIAL TO BE PLACED ON UNDISTURBED FOUNDATION.
- 3. REMOVE ANY UNSUITABLE FOUNDATION MATERIAL AND REPLACE WITH COMPACTED BEDDING MATERIAL.
- 4. ALL MATERIALS & SPECIFICATIONS TO CONFORM TO SNEW WATER DEPARTMENT STANDARDS AND REQUIREMENTS.

WATER SERVICE TRENCH NO SCALE

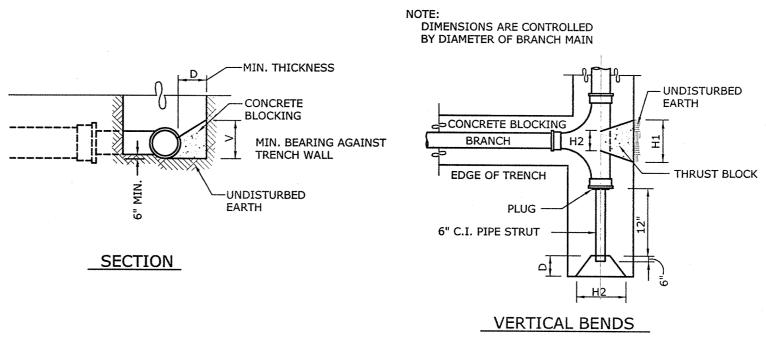

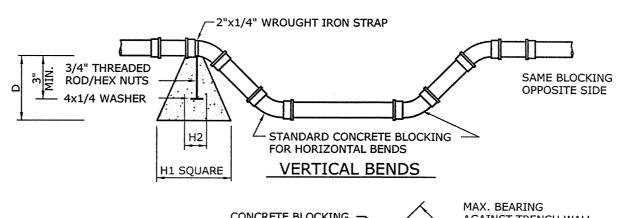

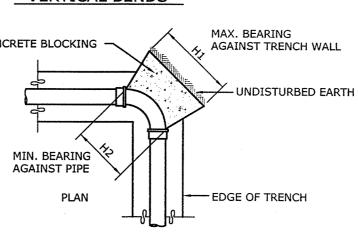

HORIZONTAL BENDS

CONCRETE THRUST BLOCKING
NO SCALE

	TABLE OF DIMENSIONS FOR CONCRETE BLOCKING																								
PIPE SIZE			, CRO k PLUG				9(	o° BEN	IDS			4	5° BEI	NDS			22 1	./2° B	ENDS			11	1/4° E	BENDS	
(H)	H1	H2	٧	D	CU. FT.	H1	Н2	٧	D	CU. FT.	Н1	H2	٧	D	CU. FT.	H1	H2	V	D	CU. FT.	H1	H2	٧	D	CU. FT.
6"Ø	24"	16"	18"	18"	3.50	30"	16"	18"	18"	4.05	24"	10"	16"	18"	3.20	24"	10"	16"	18"	3.20	24"	10"	16"	18"	3.20
8"Ø	36"	18"	18"	18"	5.05	39"	18"	24"	18"	7.30	30"	11"	18"	18"	3.95	24"	11"	18"	18"	3.45	24"	11"	16"	18"	3.40
12"Ø	54"	30"	24"	24"	13.4	54"	32"	36"	24"	18.15	42"	18"	24"	24"	9.60	24"	18"	24"	24"	6.60	24"	18"	21"	24"	6.10

## Washington Village Phase 1

## 13 Day Street Building A

Norwalk, CT

Trinity Washington Village Limited Partnership

the Norwalk Housing Authority




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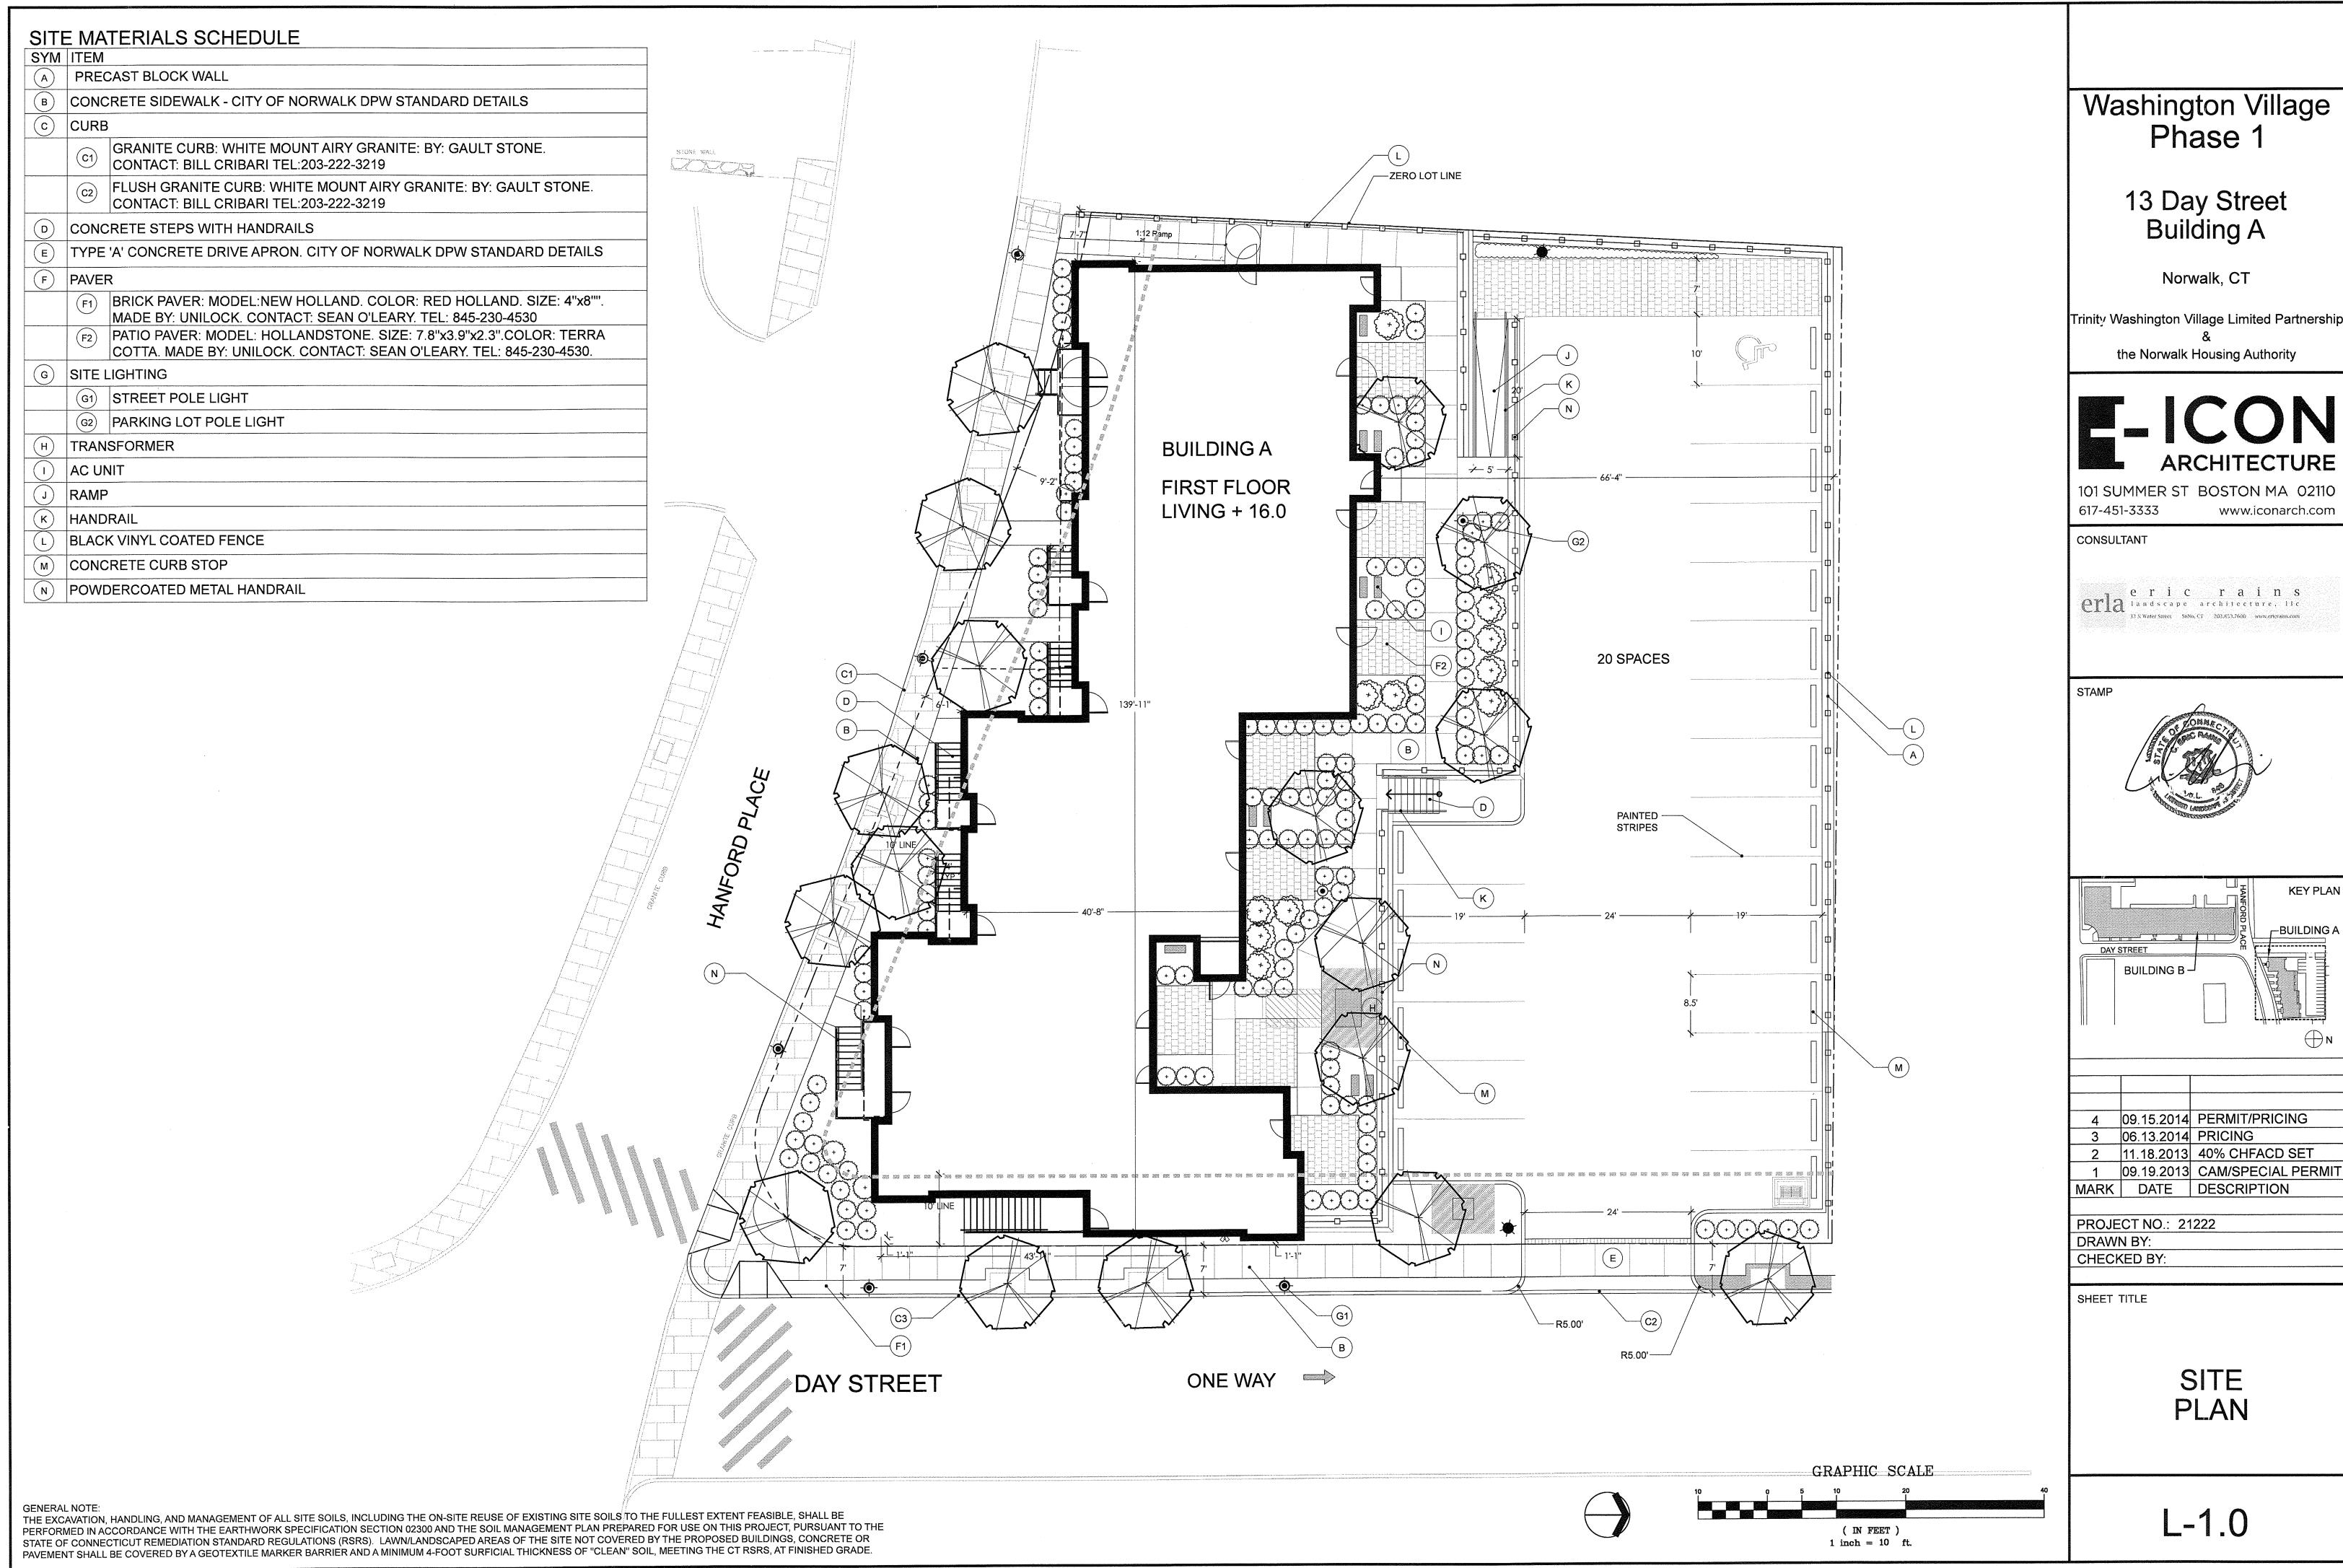
4 09-15-2014 PERMIT/ PRICING
3 06-13-2014 PRICING
2 11-18-2013 40% CHFA
1 09-19-2013 CAM/ SPECIAL PERMIT
MARK DATE DESCRIPTION

PROJECT NO.: 10071
DRAWN BY: MDS
CHECKED BY: AJM

SHEET TITLE

WATER SERVICE DETAILS

C4.5

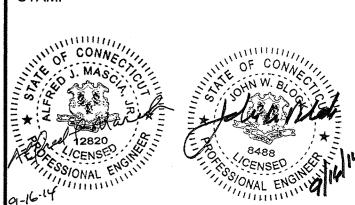


Trinity Washington Village Limited Partnership



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DAY	STREET BUILDING B	ORD PLACE	BUILDING A
1	00 15 2014	PERMIT/	PRICING

1 09.19.2013 CAM/SPECIAL PERMIT

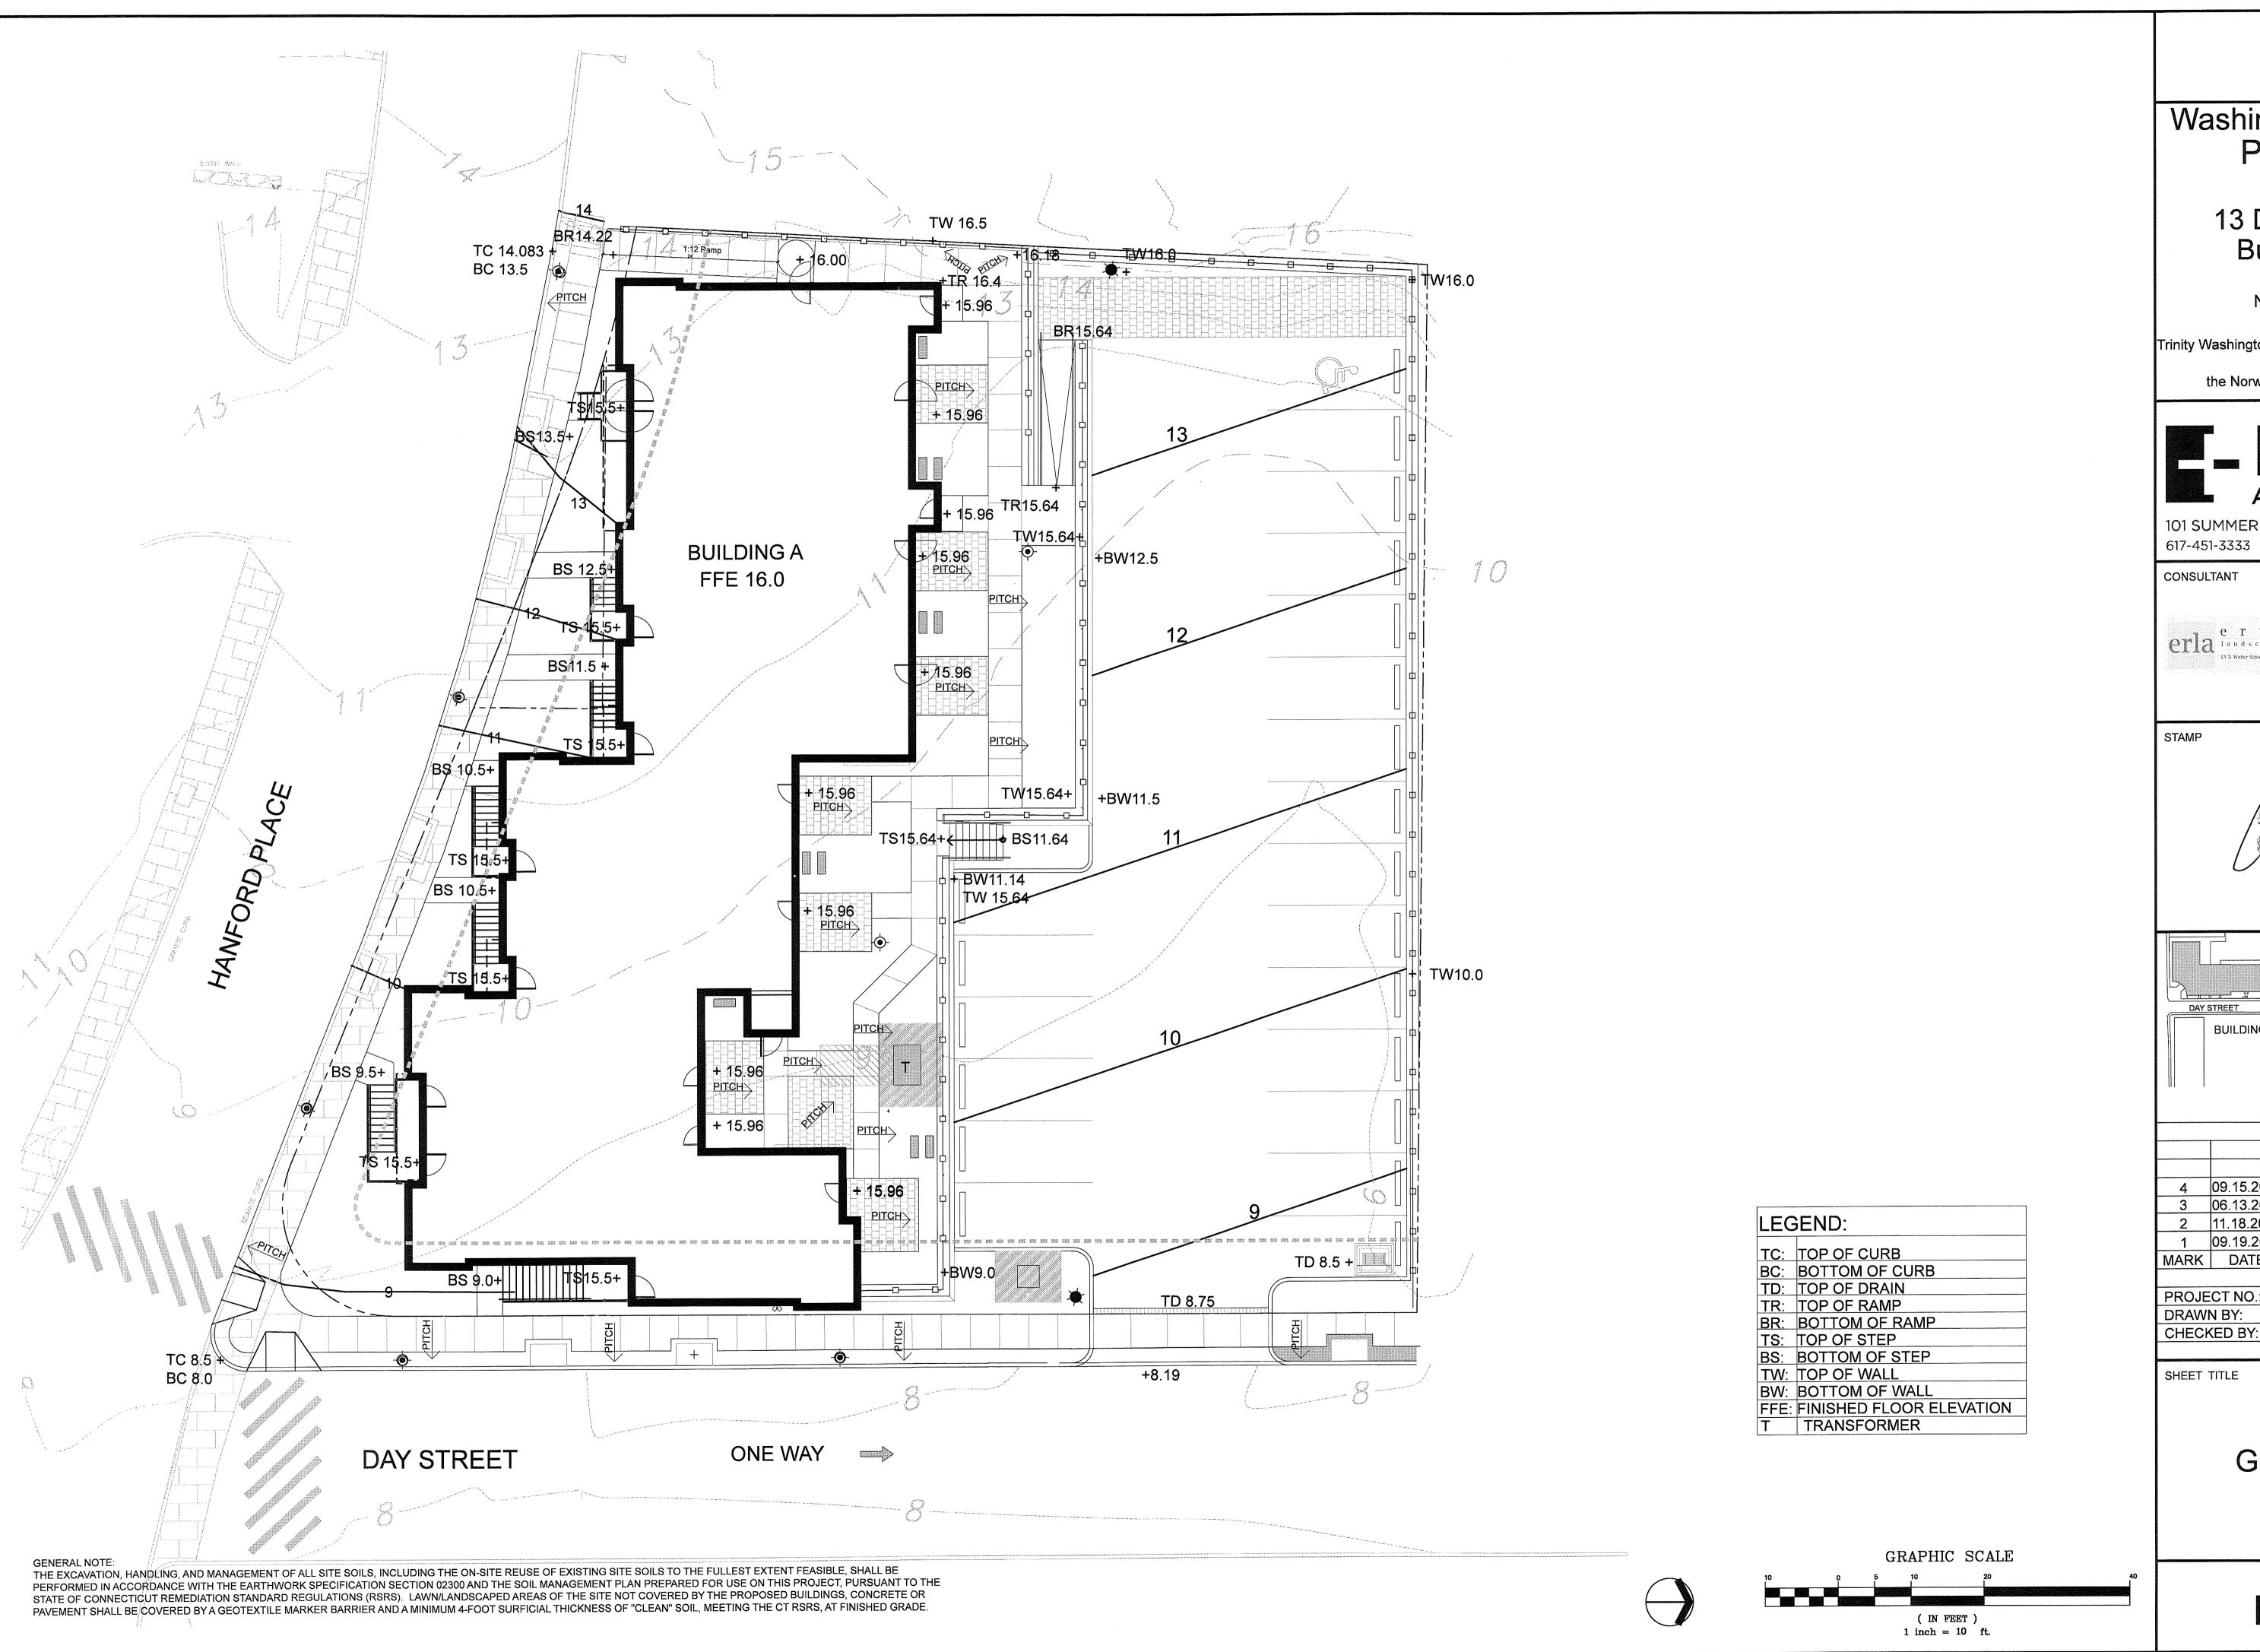

Washington Village Phase 1

13 Day Street Building A

Norwalk, CT


Trinity Washington Village Limited Partnership


the Norwalk Housing Authority



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4 09.15.2014 PERMIT/PRICING 3 06.13.2014 PRICING 11.18.2013 40% CHFACD SET


09.19.2013 CAM/SPECIAL PERMIT MARK DATE DESCRIPTION

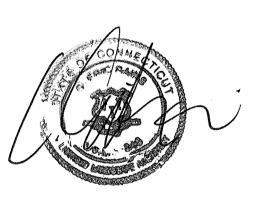PROJECT NO.: 21222 DRAWN BY:

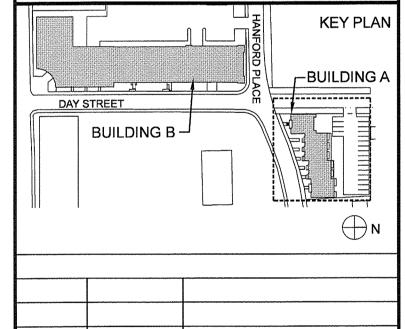SHEET TITLE

GRADING PLAN

L-2.0

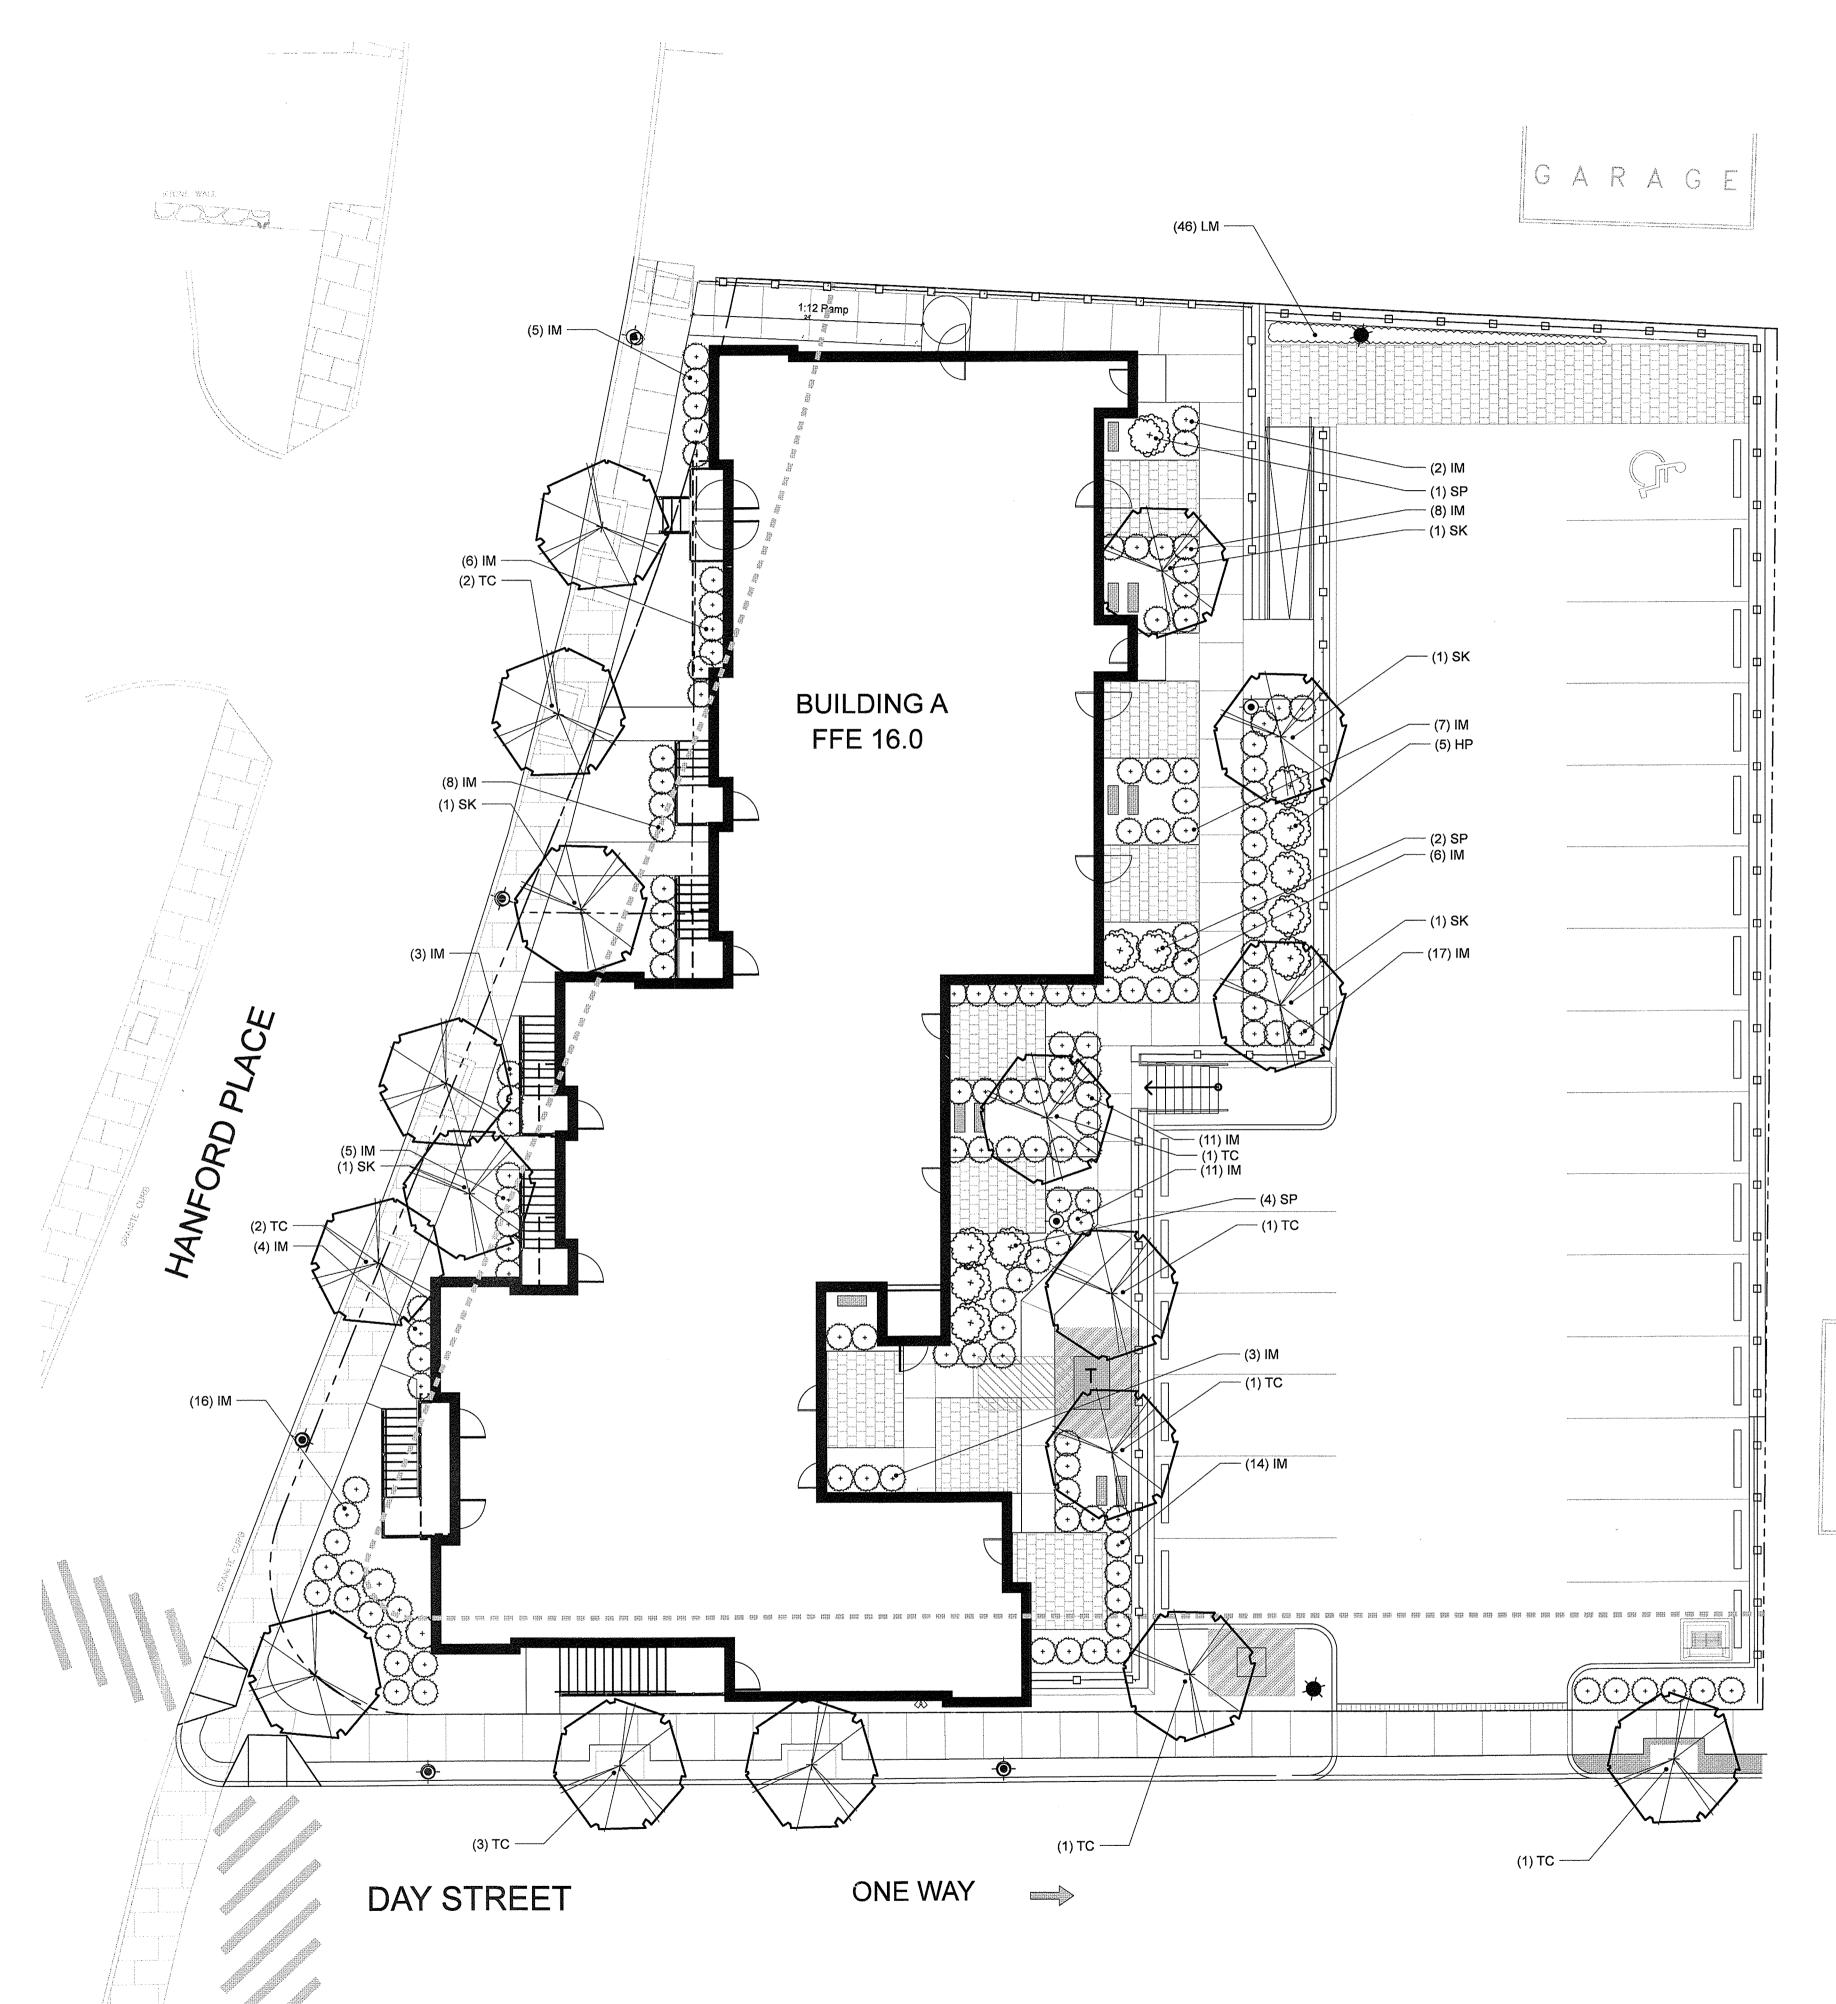

#### PLANT LIST

SYM	QTY	BOTANICAL NAME	COMMON NAME	ROOT	SIZE	COMMENTS
TREE	S					
SK	5	Stewartia koreana	KOREAN STEWARTIA	B&B	3 1/2" - 4" cal.	Full, Nicely Shaped, 6' clear to ground
TC	12	Tilla Cordata	LITTLE LEAF LINDEN	B&B	3 1/2" - 4" cal.	Full, Nicely Shaped, 6' clear to ground
SHRL	JBS					
HP	5	Hydrangea paniculata 'Vanilla Strawberry'	VANILLA STRAWBERRY HYDRANGEA	B&B	30"- 36" HT.	Specimen, 36" Spacing O.C.
IM	140	Illex x meserveae 'Blue Princess'	BLUE PRINCESS HOLLY	B&B	30"- 36" HT.	Specimen, 36" Spacing O.C.
SP	7	Syringa pubescens subsp. patula	MISS KIM LILAC	Cont.	2 Gal.	Full, Nicely Shaped
GRO	UNDCC	DVER				
LM	46	Liriope muscari 'Big Blue'	BIG BLUE LILY TURF	Cont.	1 Pint	12"-15" Spacing O.C.
				L		

## SOIL CHART POST CONSTRUCTION

POST CONSTRUCTION	TYPE OF PREPARATION	
SOIL CONDITION		
GOOD SOIL	LOOSEN EXISTING SOIL	
COMPACTED SOIL	LOOSEN EXISTING SOIL, ADD COMPOSTED ORGANIC MATTER TO BRING ORGANIC CONTENT TO 5% DRY WEIGHT	
CLAY CONTENT 5-35%	LOOSEN EXISTING SOIL, ADD ORGANIC MATTER TO BRING ORGANIC CONTENT TO 5% DRY WEIGHT	
SANDY LOAM SOILS	ADD CLEAN COMPOSTED ORGANIC MATERIAL (20% MAX. BY VOLUME) TO THE EXISTING SOIL.	
POOR QUALITY, HEAVY CLAY SOIL	REMOVE EXISTING SOIL, ADD LOAM TOPSOIL	

#### PLANTING NOTES

1) EACH TREE MUST BE PLANTED SUCH THAT THE TRUNK FLARE IS VISIBLE AT THE TOP OF THE ROOT BALL. TREES WHERE THE TRUNK FLARE IS NOT VISIBLE SHALL BE REJECTED. DO NOT COVER THE TOP OF THE ROOT BALL WITH SOIL.

2) DO NOT HEAVILY PRUNE THE TREE AT PLANTING. PRUNE ONLY CROSSOVER LIMBS, CO-DOMINANT LEADERS, AND BROKEN OR DEAD BRANCHES. SOME INTERIOR TWIGS AND LATERAL BRANCHES MAY BE PRUNED; HOWEVER, DO NOT REMOVE THE TERMINAL BUDS OF BRANCHES THAT EXTEND TO THE EDGE

3) STAKE TREE BASED ON CRITERIA BELOW OR AS REQUESTED BY THE LANDSCAPE ARCHITECT.

4) WRAP TREE TRUNKS ONLY UPON THE APPROVAL OF THE LANDSCAPE ARCHITECT.

5) BACK FILL WITH SOIL EXCAVATED TO MAKE HOLE. SEE SOIL CHART FOR SOIL AMENDMENTS.

6) DO NOT PLACE MULCH IN CONTACT WITH TREE TRUNK. MAINTAIN THE MULCH FREE OF WEEDS.

7) ALL PLANT MATERIAL SHALL BE INSPECTED FOR DEFECTS AND OR DAMAGE BEFORE PLANTING. SUBSTANDARD PLANTS SHALL BE RETURNED AND REPLACED BY THE CONTRACTOR. ACCEPTABLE PLANTS ARE TO BE PLANTED PER THE SPECIFICATIONS OF THE PLANT.

8) ALL PLANTINGS OPERATIONS SHALL BE PERFORMED AND COMPLETED BETWEEN OCTOBER 1 AND THE DATE AT WHICH FROZEN SOIL CONDITIONS EXIST, AND/OR FROM APRIL 15 TO JUNE 15.

9) ALL PLANT MATERIAL IS TO HAVE A ONE YEAR WARRANTEE THAT WILL INCLUDE ALL MATERIALS AND LABOR. REPLACEMENT OPERATIONS SHALL OCCUR DURING THE APPROPRIATE GROWING SEASON AND SHALL INCLUDE ALL MATERIAL THAT HAS LOST UP TO 25% OF ITS AREA OR MASS.

10) THE ACCEPTABILITY OF THE PLANT MATERIAL FURNISHED AND PLANTED SHALL BE DETERMINED AT THE END OF THE FIRST FULL GROWING SEASON. SHOULD THE INSTALLING CONTRACTOR NOT BE THE MAINTENANCE CONTRACTOR, THE INSTALLING CONTRACTOR SHALL, AS NECESSARY, INFORM THE OWNER OF ANY CONDITIONS THAT ARE CAUSING THE INSTALLED PLANT MATERIAL TO SUFFER OR DECLINE.

11) AT THE END OF ONE FULL GROWING SEASON, AN INSPECTION TO DETERMINE THE ACCEPTABILITY OF PLANT ESTABLISHMENT WILL BE HELD BY THE CONTRACTOR AND OWNER NO LATER THAN OCTOBER 1. AT THE END OF ONE YEAR, CONTRACTOR SHALL REPLACE ALL DEAD SHRUBS AND PLANTINGS AND PERFORM ANY NECESSARY CORRECTIVE ACTION.

12) REFER TO CIVIL DRAWINGS AND DETAILS FOR INFORMATION AND SITE GRADING/UTILITY COORDINATION.

13) ALL PLANT MATERIAL TO MEET THE STANDARDS ESTABLISHED BY THE AMERICAN NURSERY AND LANDSCAPE ASSOCIATION. SPECIFICALLY THE AMERICAN STANDARD FOR NURSERY STOCK ANSI-Z60.1-2004.

G A R A G E

## Washington Village Phase 1

## 13 Day Street Building A

Norwalk, CT

Trinity Washington Village Limited Partnership &

the Norwalk Housing Authority





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CONSULTANT

erla er i c r a i n s
landscape architecture, llc
33 x Water Street SoNo, CT 203.853,7600 www.erlerains.com

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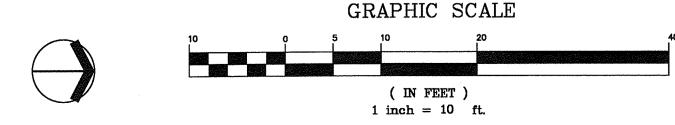
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3	06.13.2014	PRICING
2	11.18.2013	40% CHFACD SET
1	09.19.2013	CAM/SPECIAL PERMI
MARK	DATE	DESCRIPTION


PROJECT NO.: 21222
DRAWN BY:
CHECKED BY:

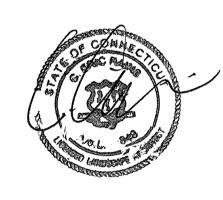SHEET TITLE

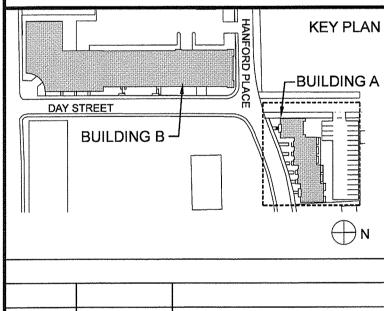PLANTING PLAN

L-3.0



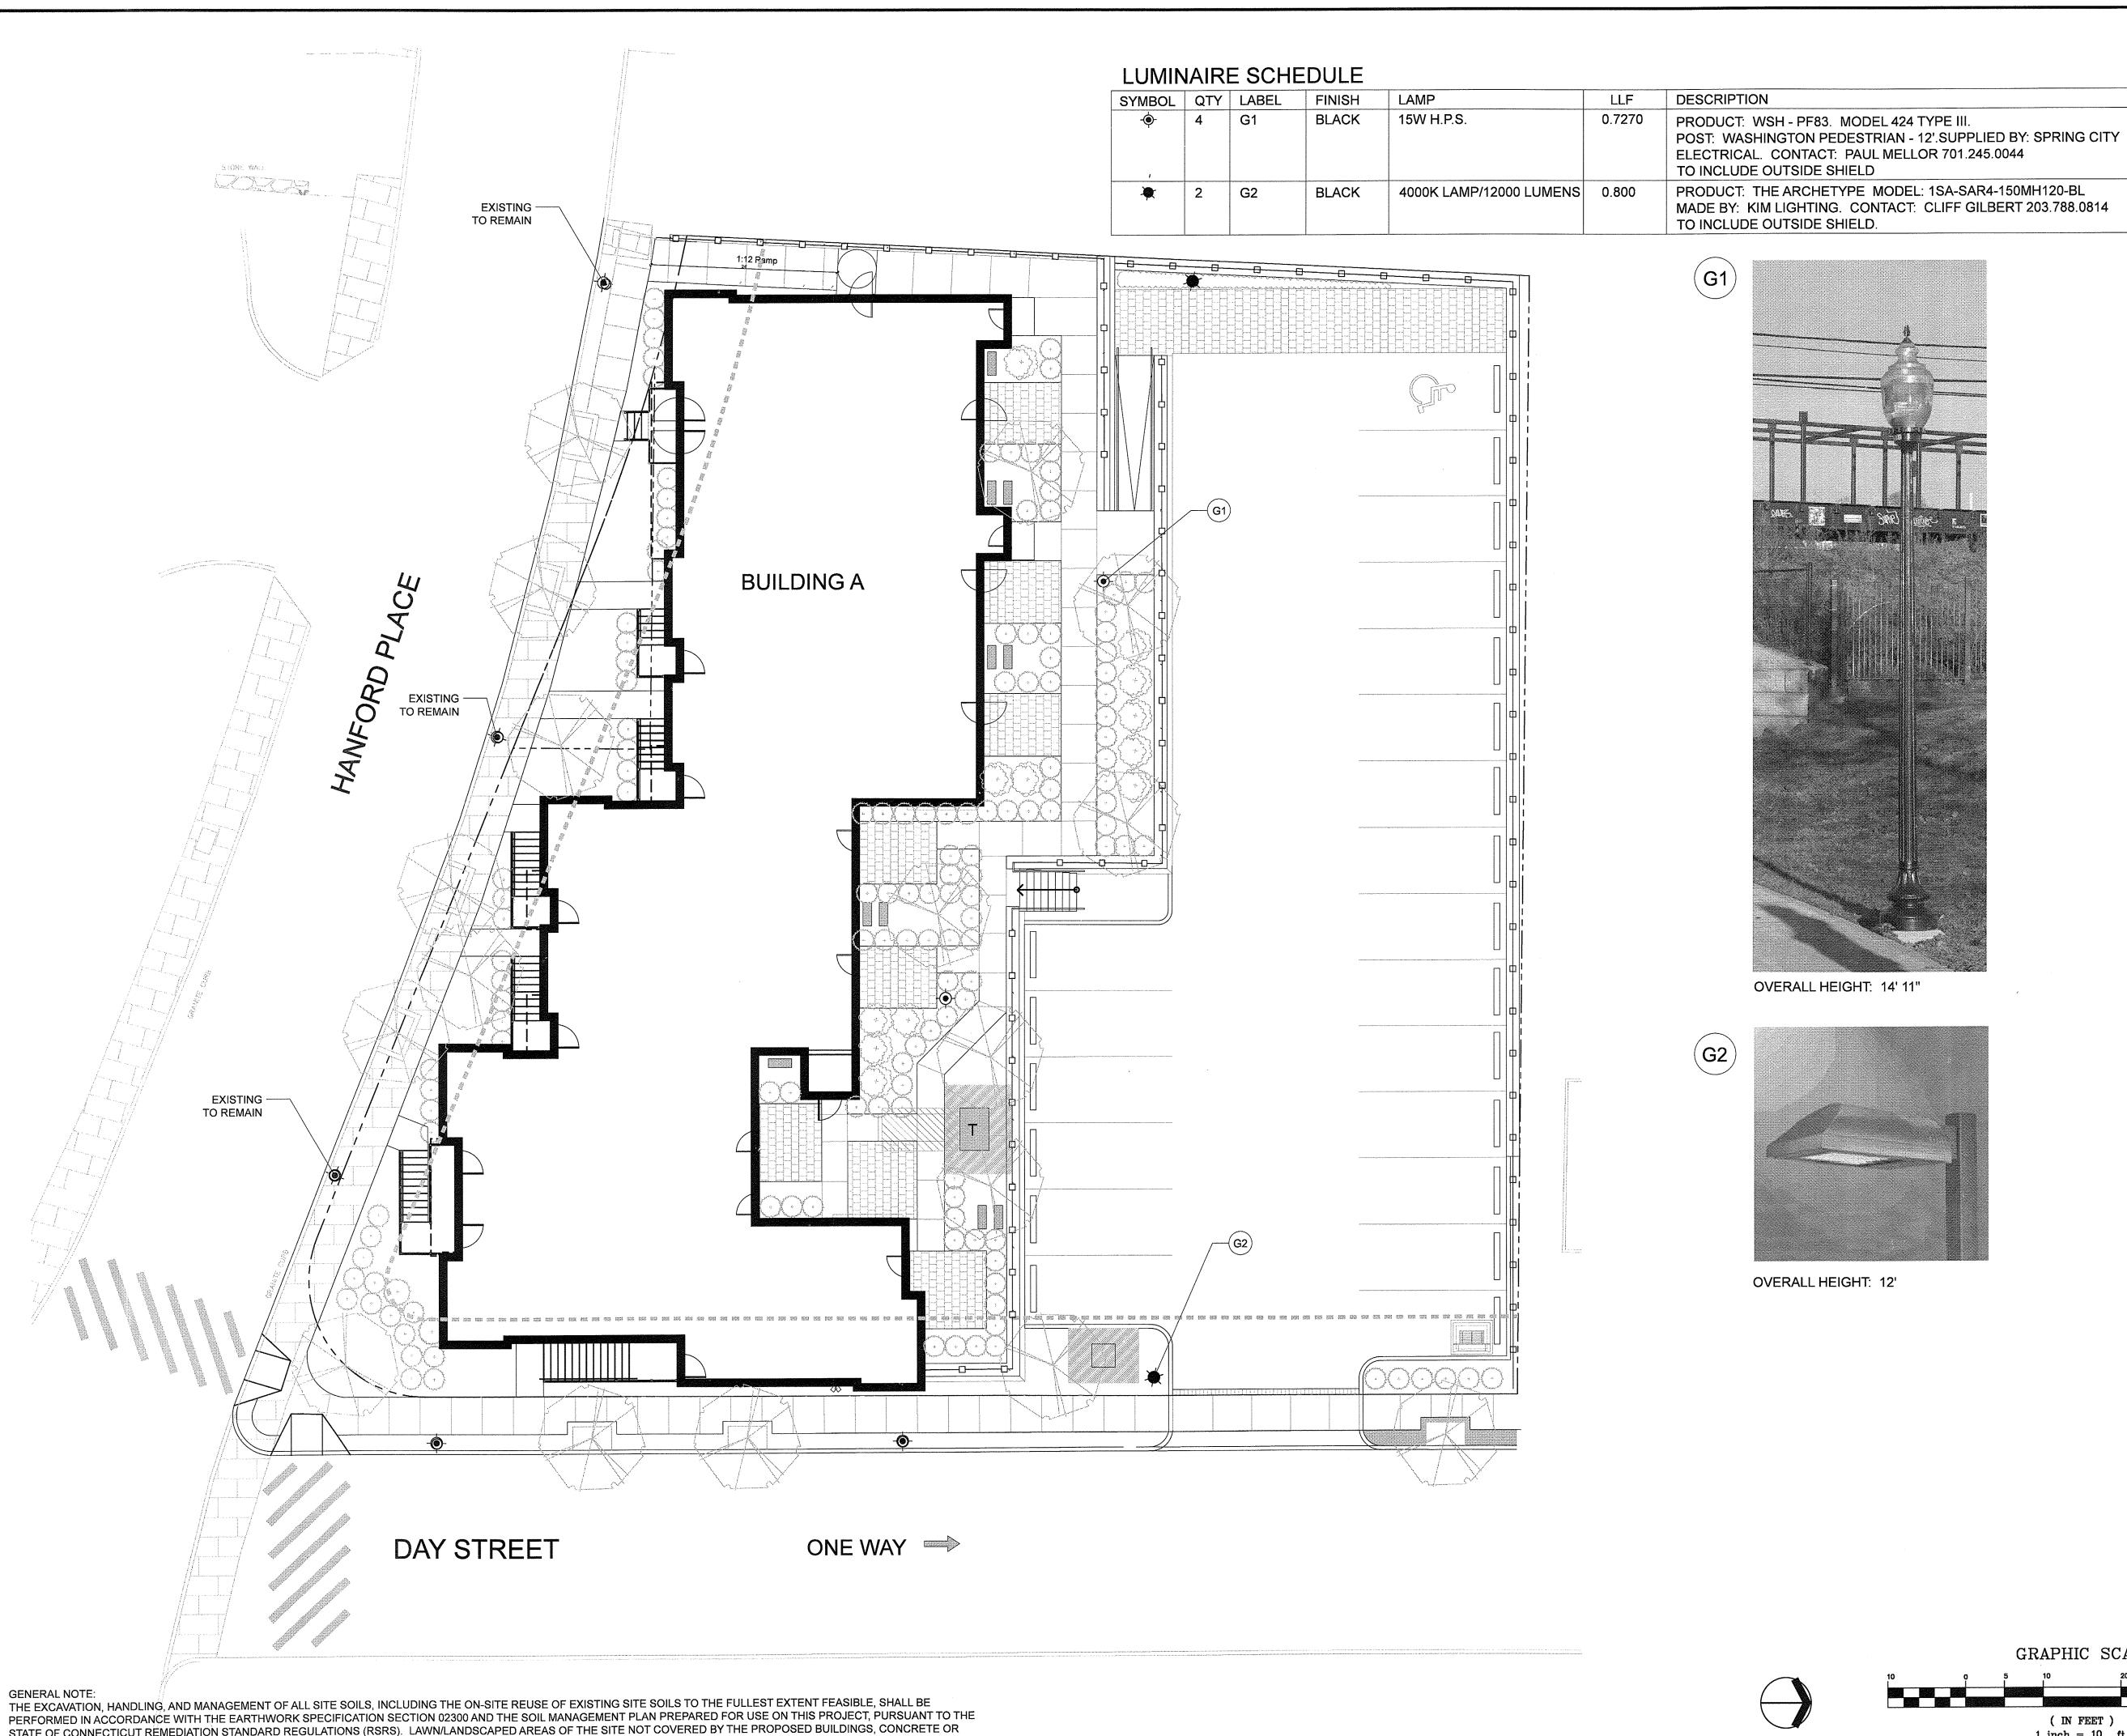



## 13 Day Street Building A

Norwalk, CT

Trinity Washington Village Limited Partnership the Norwalk Housing Authority

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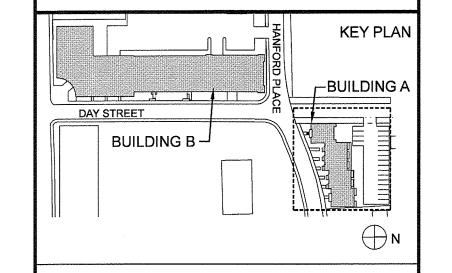
CONSULTANT

HEIGHT

14' 11"

STAMP





4	09.15.2014	PERMIT/PRICING
3	06.13.2014	PRICING
2	11.18.2013	40% CHFACD SET
1	09.19.2013	CAM/SPECIAL PERM

MARK DATE DESCRIPTION

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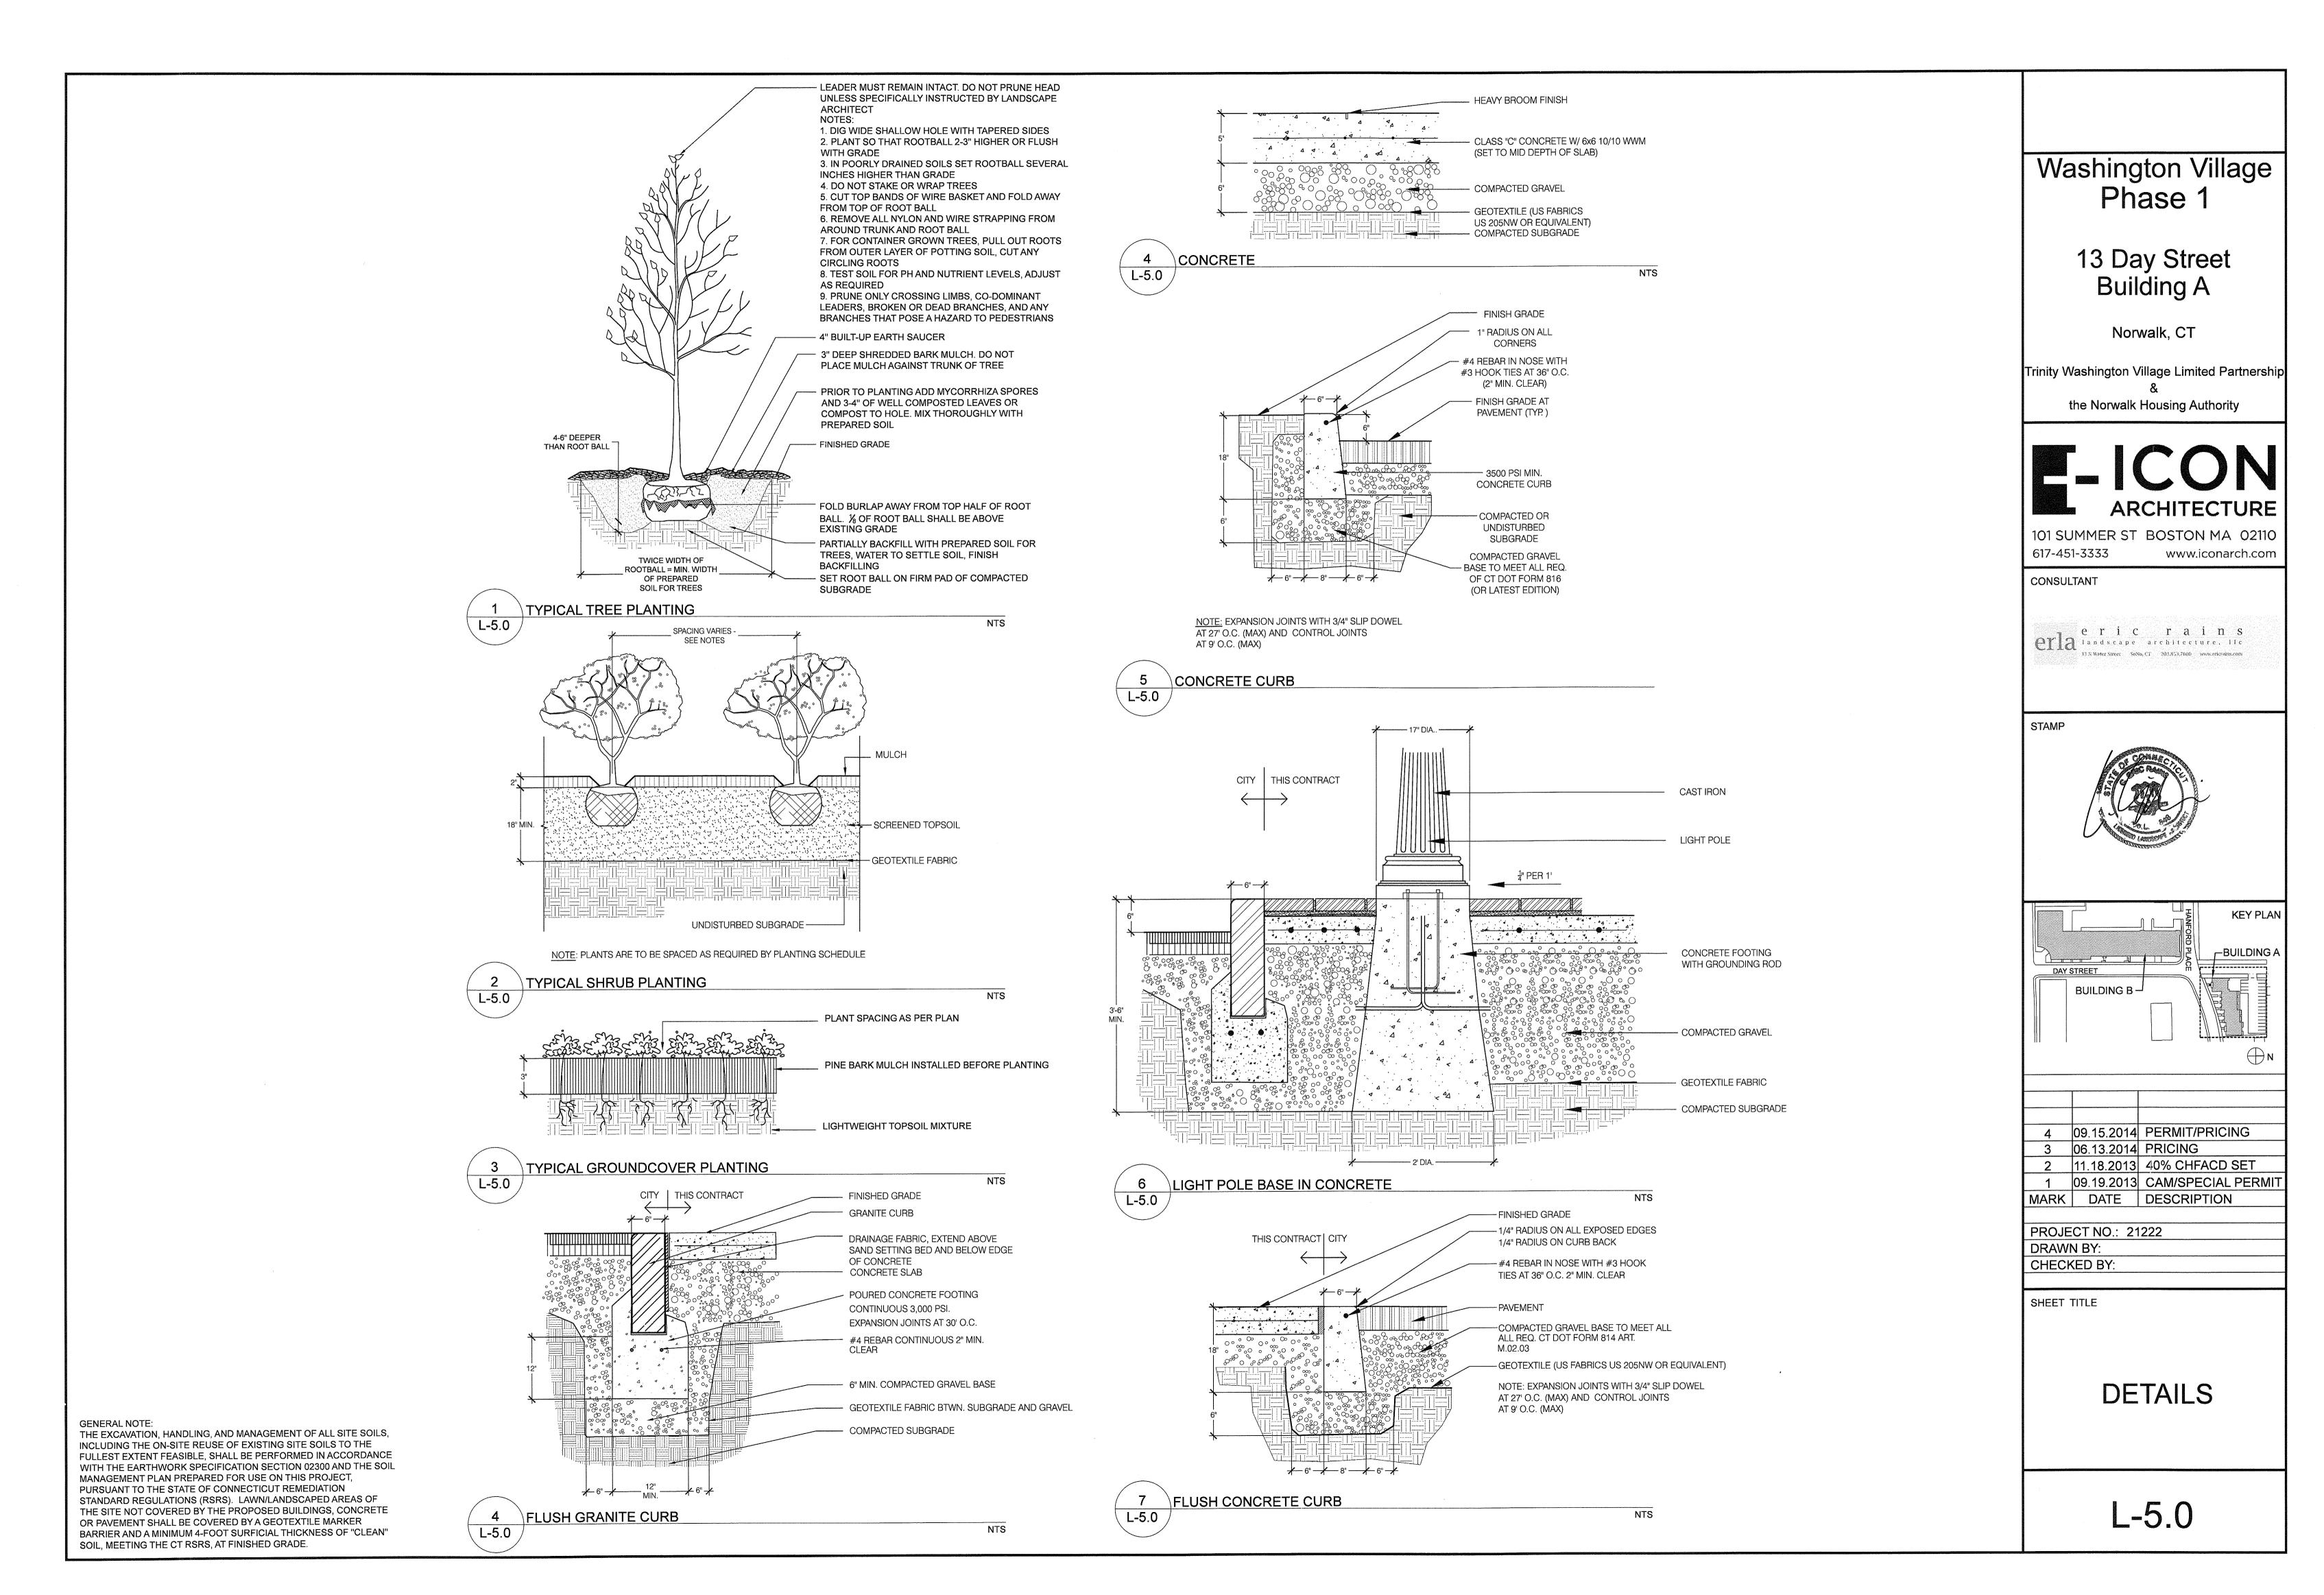
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LIGHTING PLAN


GRAPHIC SCALE ( IN FEET ) 1 inch = 10 ft.


OVERALL HEIGHT: 14' 11"

OVERALL HEIGHT: 12'




Sep 16 14:50:14 2014

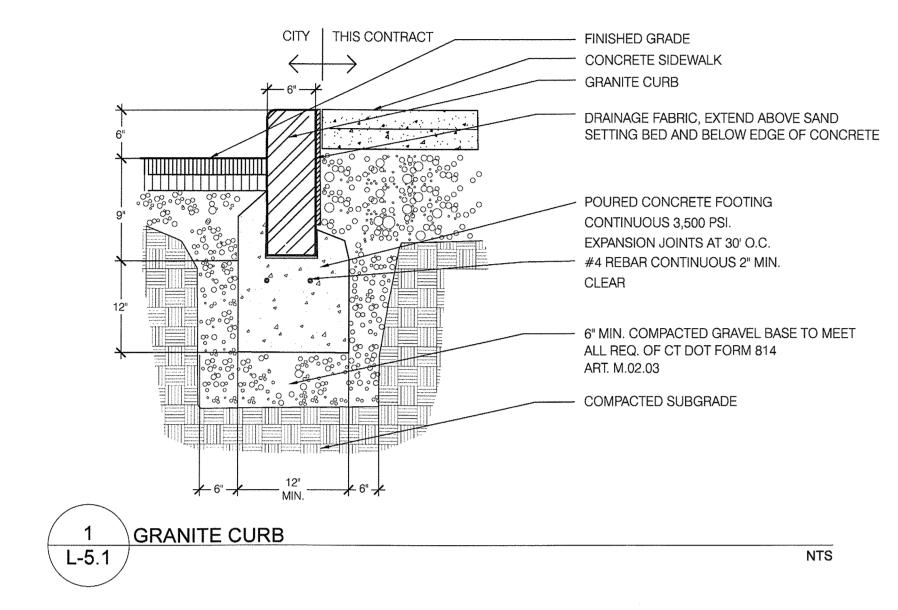

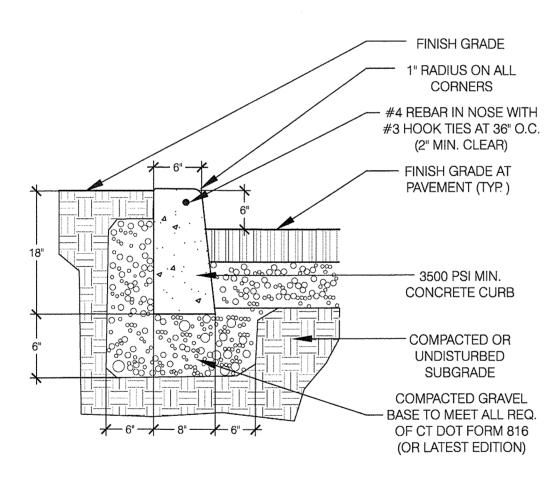

NOTE: EXPANSION JOINTS WITH 3/4" SLIP DOWEL AT 27' O.C. (MAX) AND CONTROL JOINTS AT 9' O.C. (MAX)

2 CONCRETE CURB
N

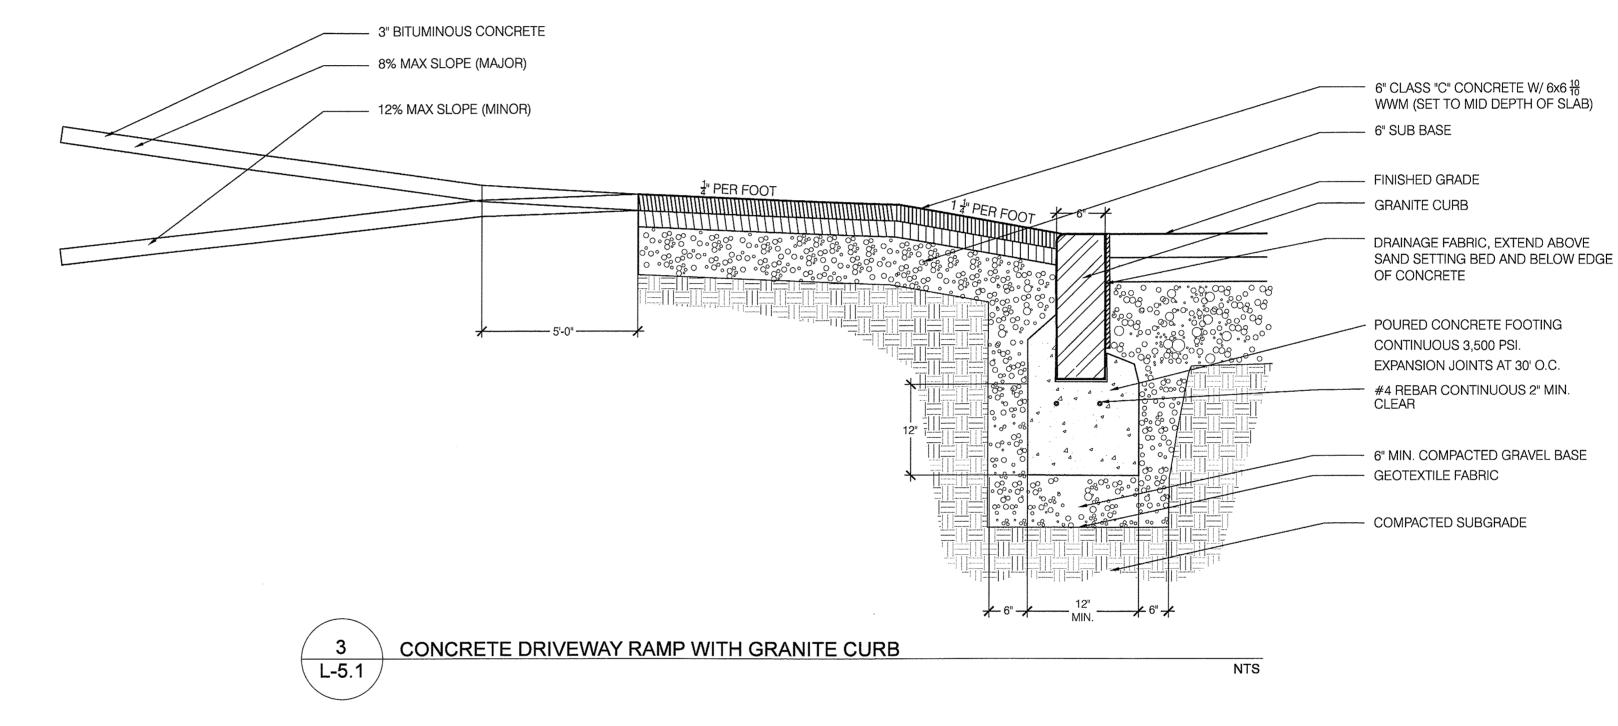

## Washington Village Phase 1

## 13 Day Street Building A

Norwalk, CT

Trinity Washington Village Limited Partnership & the Norwalk Housing Authority

## E-ICON ARCHITECTURE


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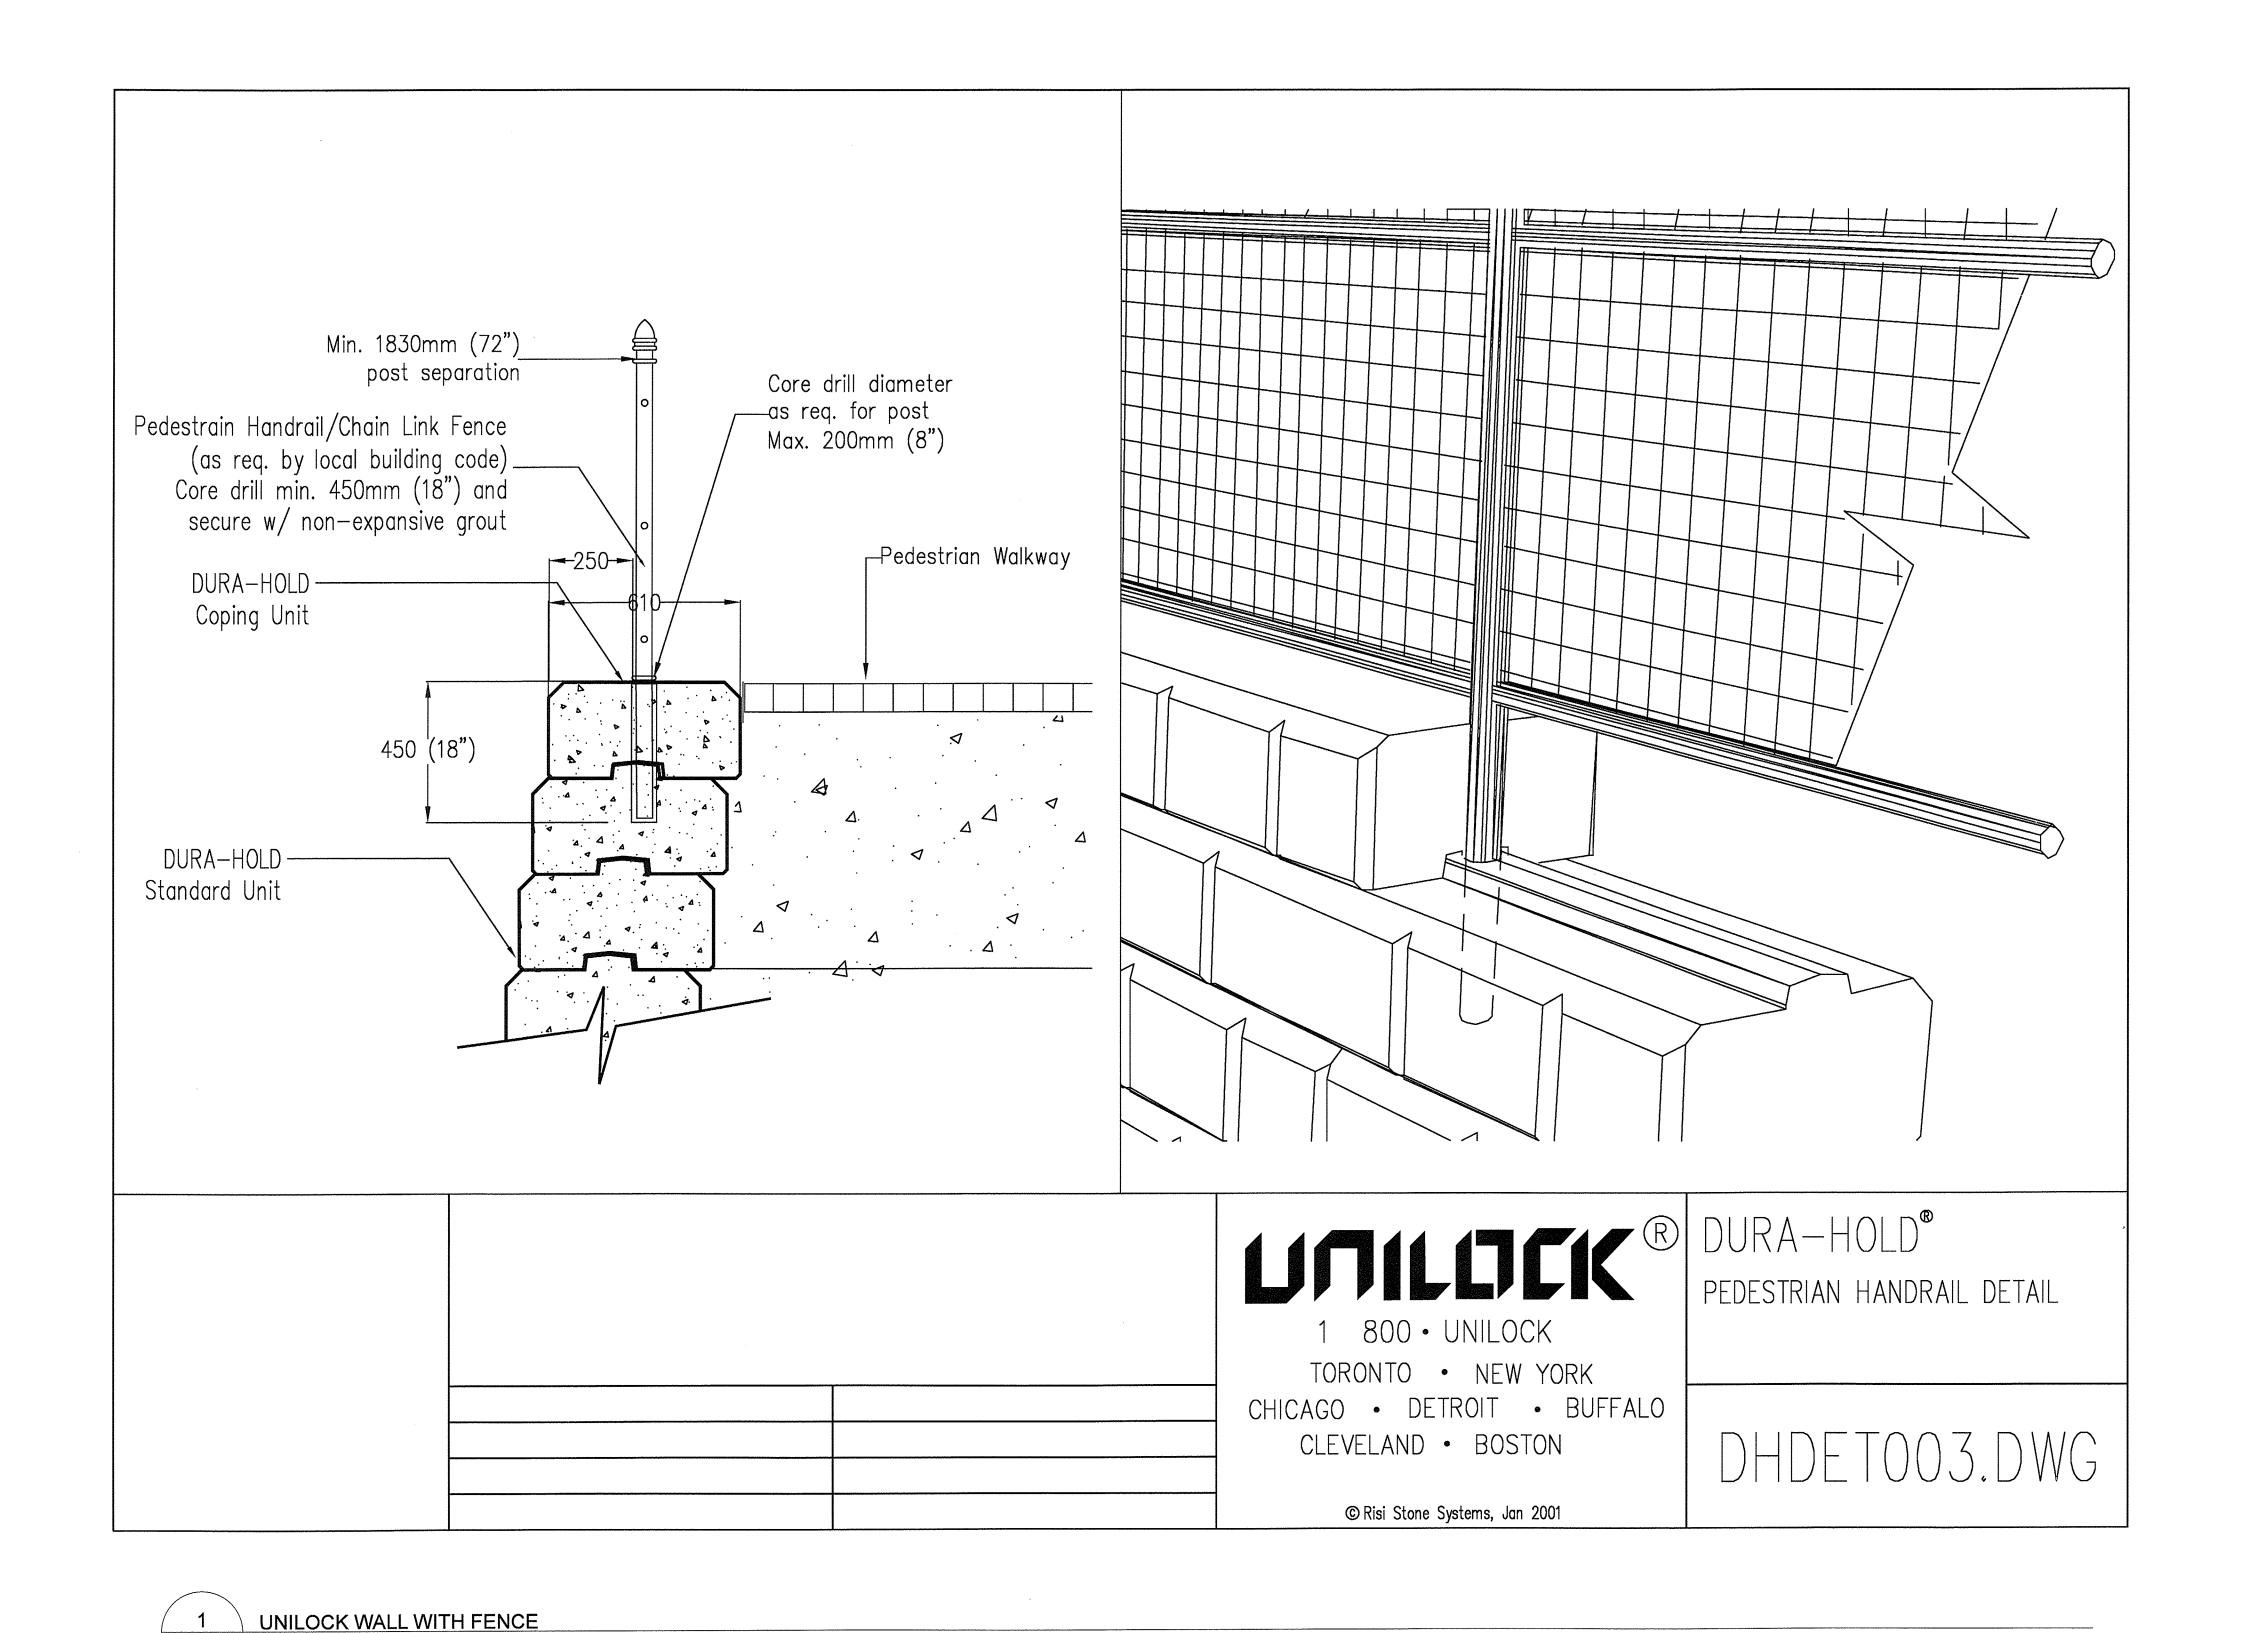
PROJECT NO.: 21222
DRAWN BY:
CHECKED BY:

SHEET TITLE

**DETAILS** 

L-5.1

GENERAL NOTE:
THE EXCAVATION, HANDLING, AND MANAGEMENT OF ALL SITE SOILS, INCLUDING THE ON-SITE REUSE OF EXISTING SITE SOILS TO THE FULLEST EXTENT FEASIBLE, SHALL BE
PERFORMED IN ACCORDANCE WITH THE EARTHWORK SPECIFICATION SECTION 02300 AND THE SOIL MANAGEMENT PLAN PREPARED FOR USE ON THIS PROJECT, PURSUANT TO THE
STATE OF CONNECTICUT REMEDIATION STANDARD REGULATIONS (RSRS). LAWN/LANDSCAPED AREAS OF THE SITE NOT COVERED BY THE PROPOSED BUILDINGS, CONCRETE OR
PAVEMENT SHALL BE COVERED BY A GEOTEXTILE MARKER BARRIER AND A MINIMUM 4-FOOT SURFICIAL THICKNESS OF "CLEAN" SOIL, MEETING THE CT RSRS, AT FINISHED GRADE.

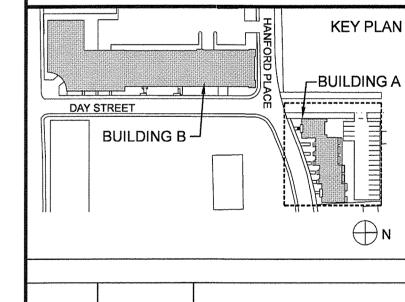

NOTE: DETAIL PROVIDED BY DANIEL NEVIACKAS T UNILOCK.
PLEASE DIRECT ANY QUESTIONS TO UNILOCK

Phase 1

Washington Village

13 Day Street Building A

Norwalk, CT

Trinity Washington Village Limited Partnership & the Norwalk Housing Authority



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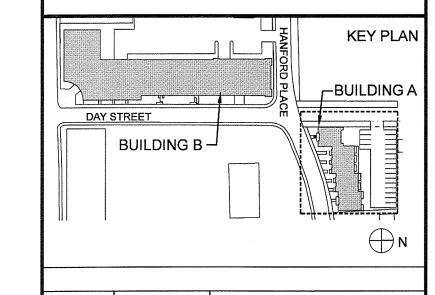
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4 09.15.2014 PERMIT/PRICING 3 06.13.2014 PRICING 2 11.18.2013 40% CHFACD SET

1 09.19.2013 CAM/SPECIAL PERMIT MARK DATE DESCRIPTION


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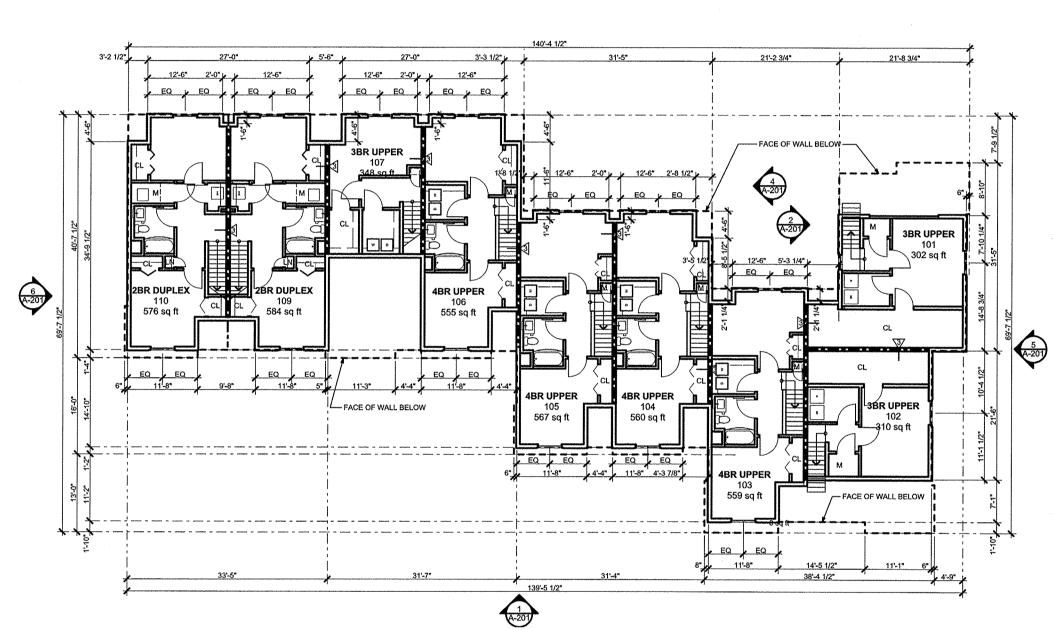
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**DETAILS** 

L-5.2


GENERAL NOTE:
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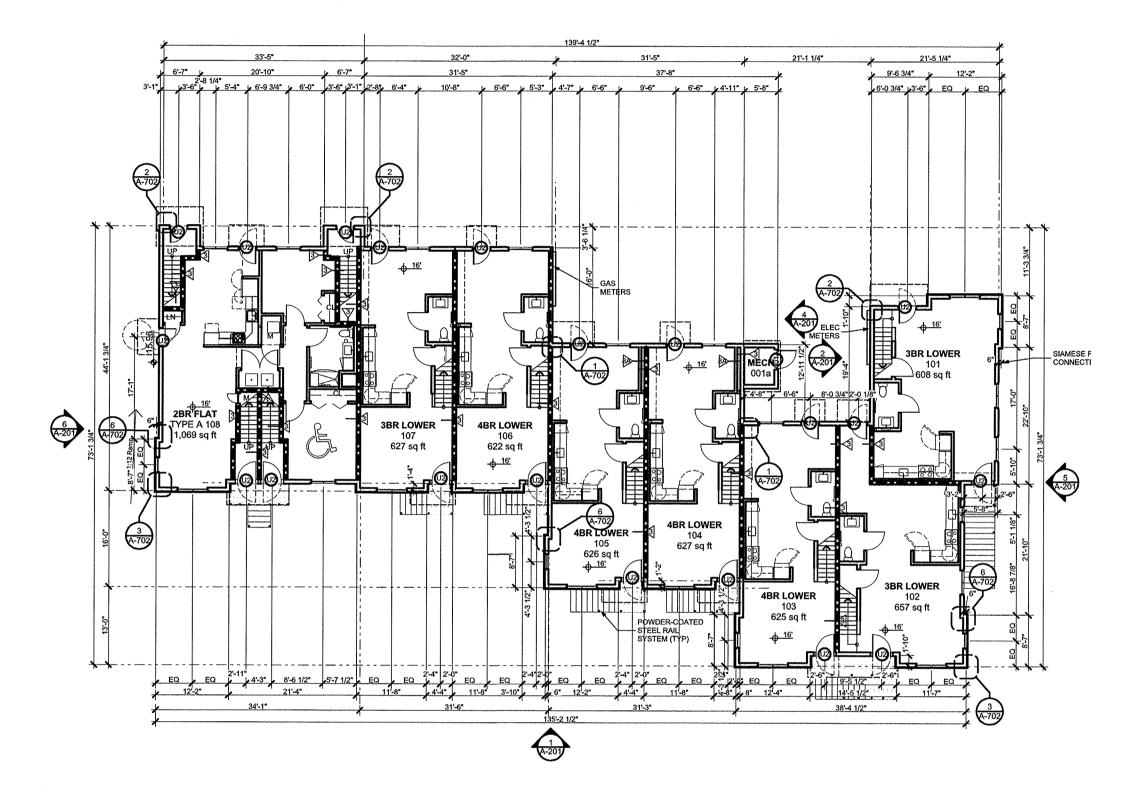





THIRD FLOOR

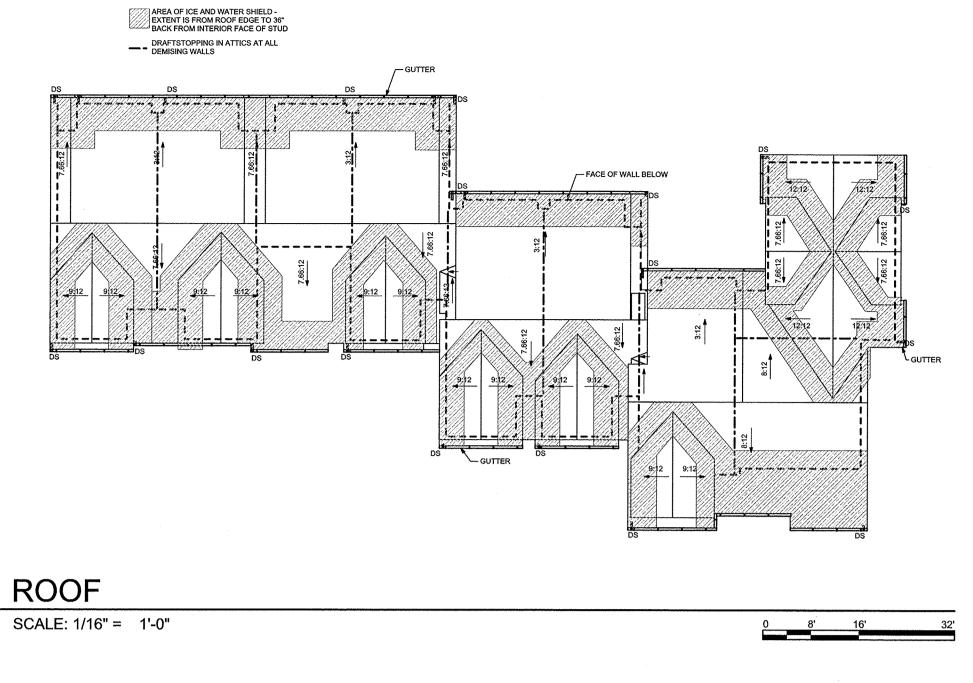SCALE: 1/16" = 1'-0"



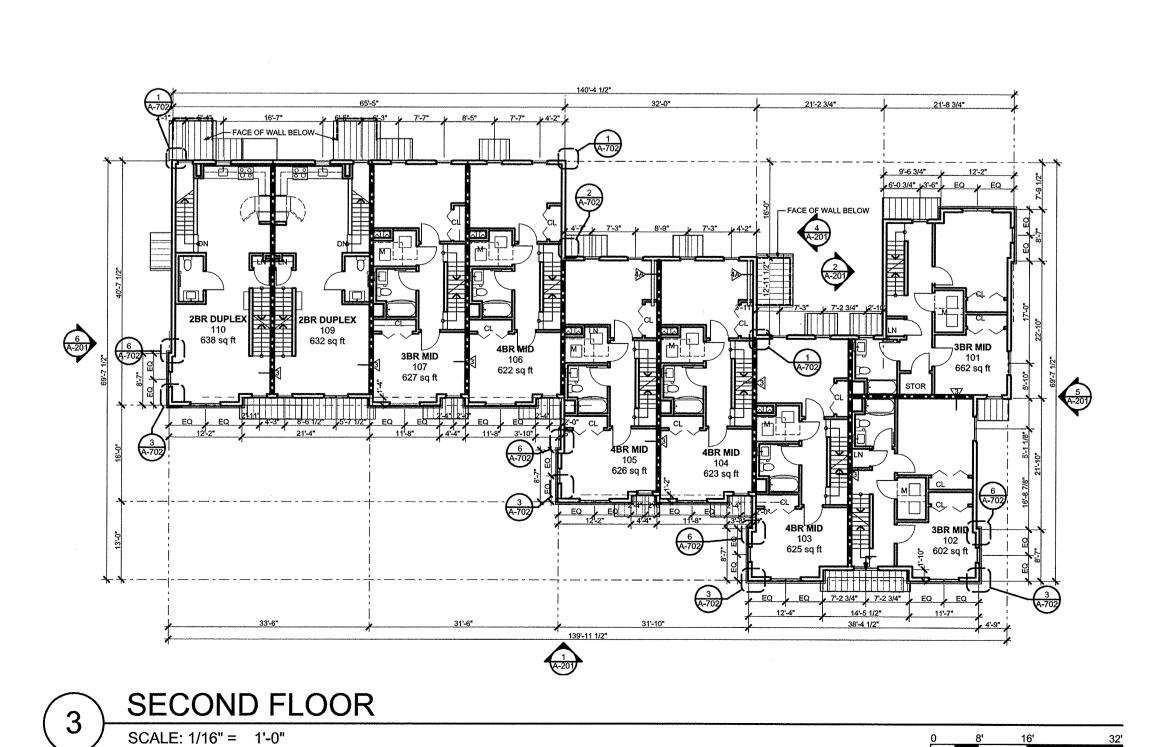



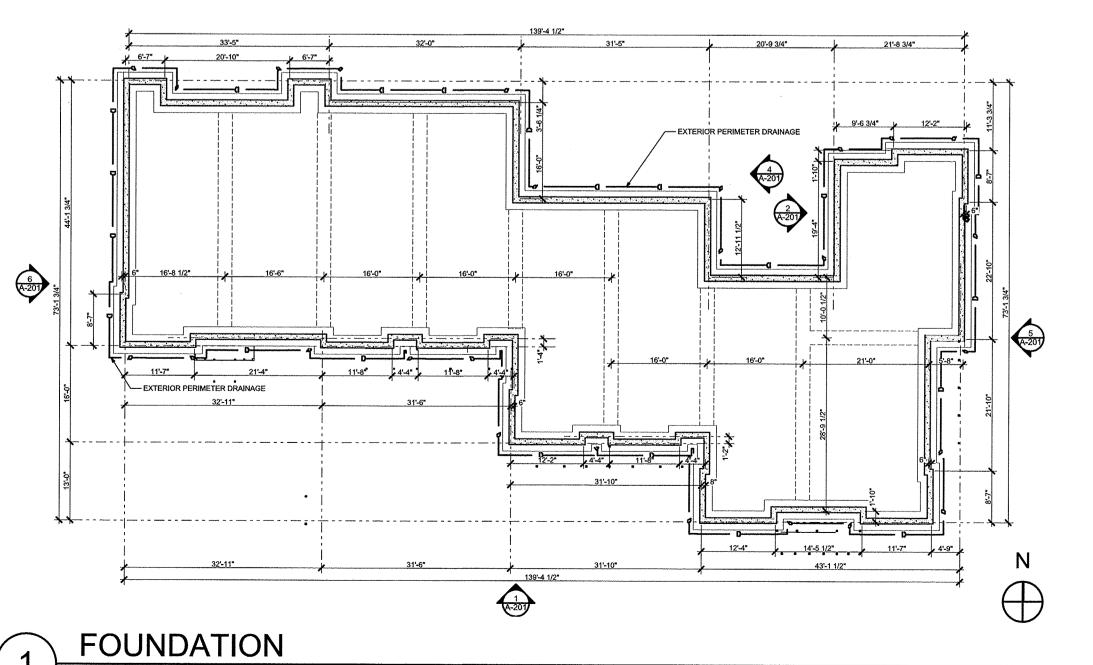

SCALE: 1/16" = 1'-0"

## Washington Village Phase 1

### 13 Day Street Building A

Norwalk, CT

Trinity Washington Village Limited Partnership the Norwalk Housing Authority



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MARK DATE DESCRIPTION


PROJECT NO.: 21222 DRAWN BY: JR,AF,GA,KH,SO CHECKED BY: KH

SHEET TITLE

**BUILDING A FLOOR PLANS** 

A-101



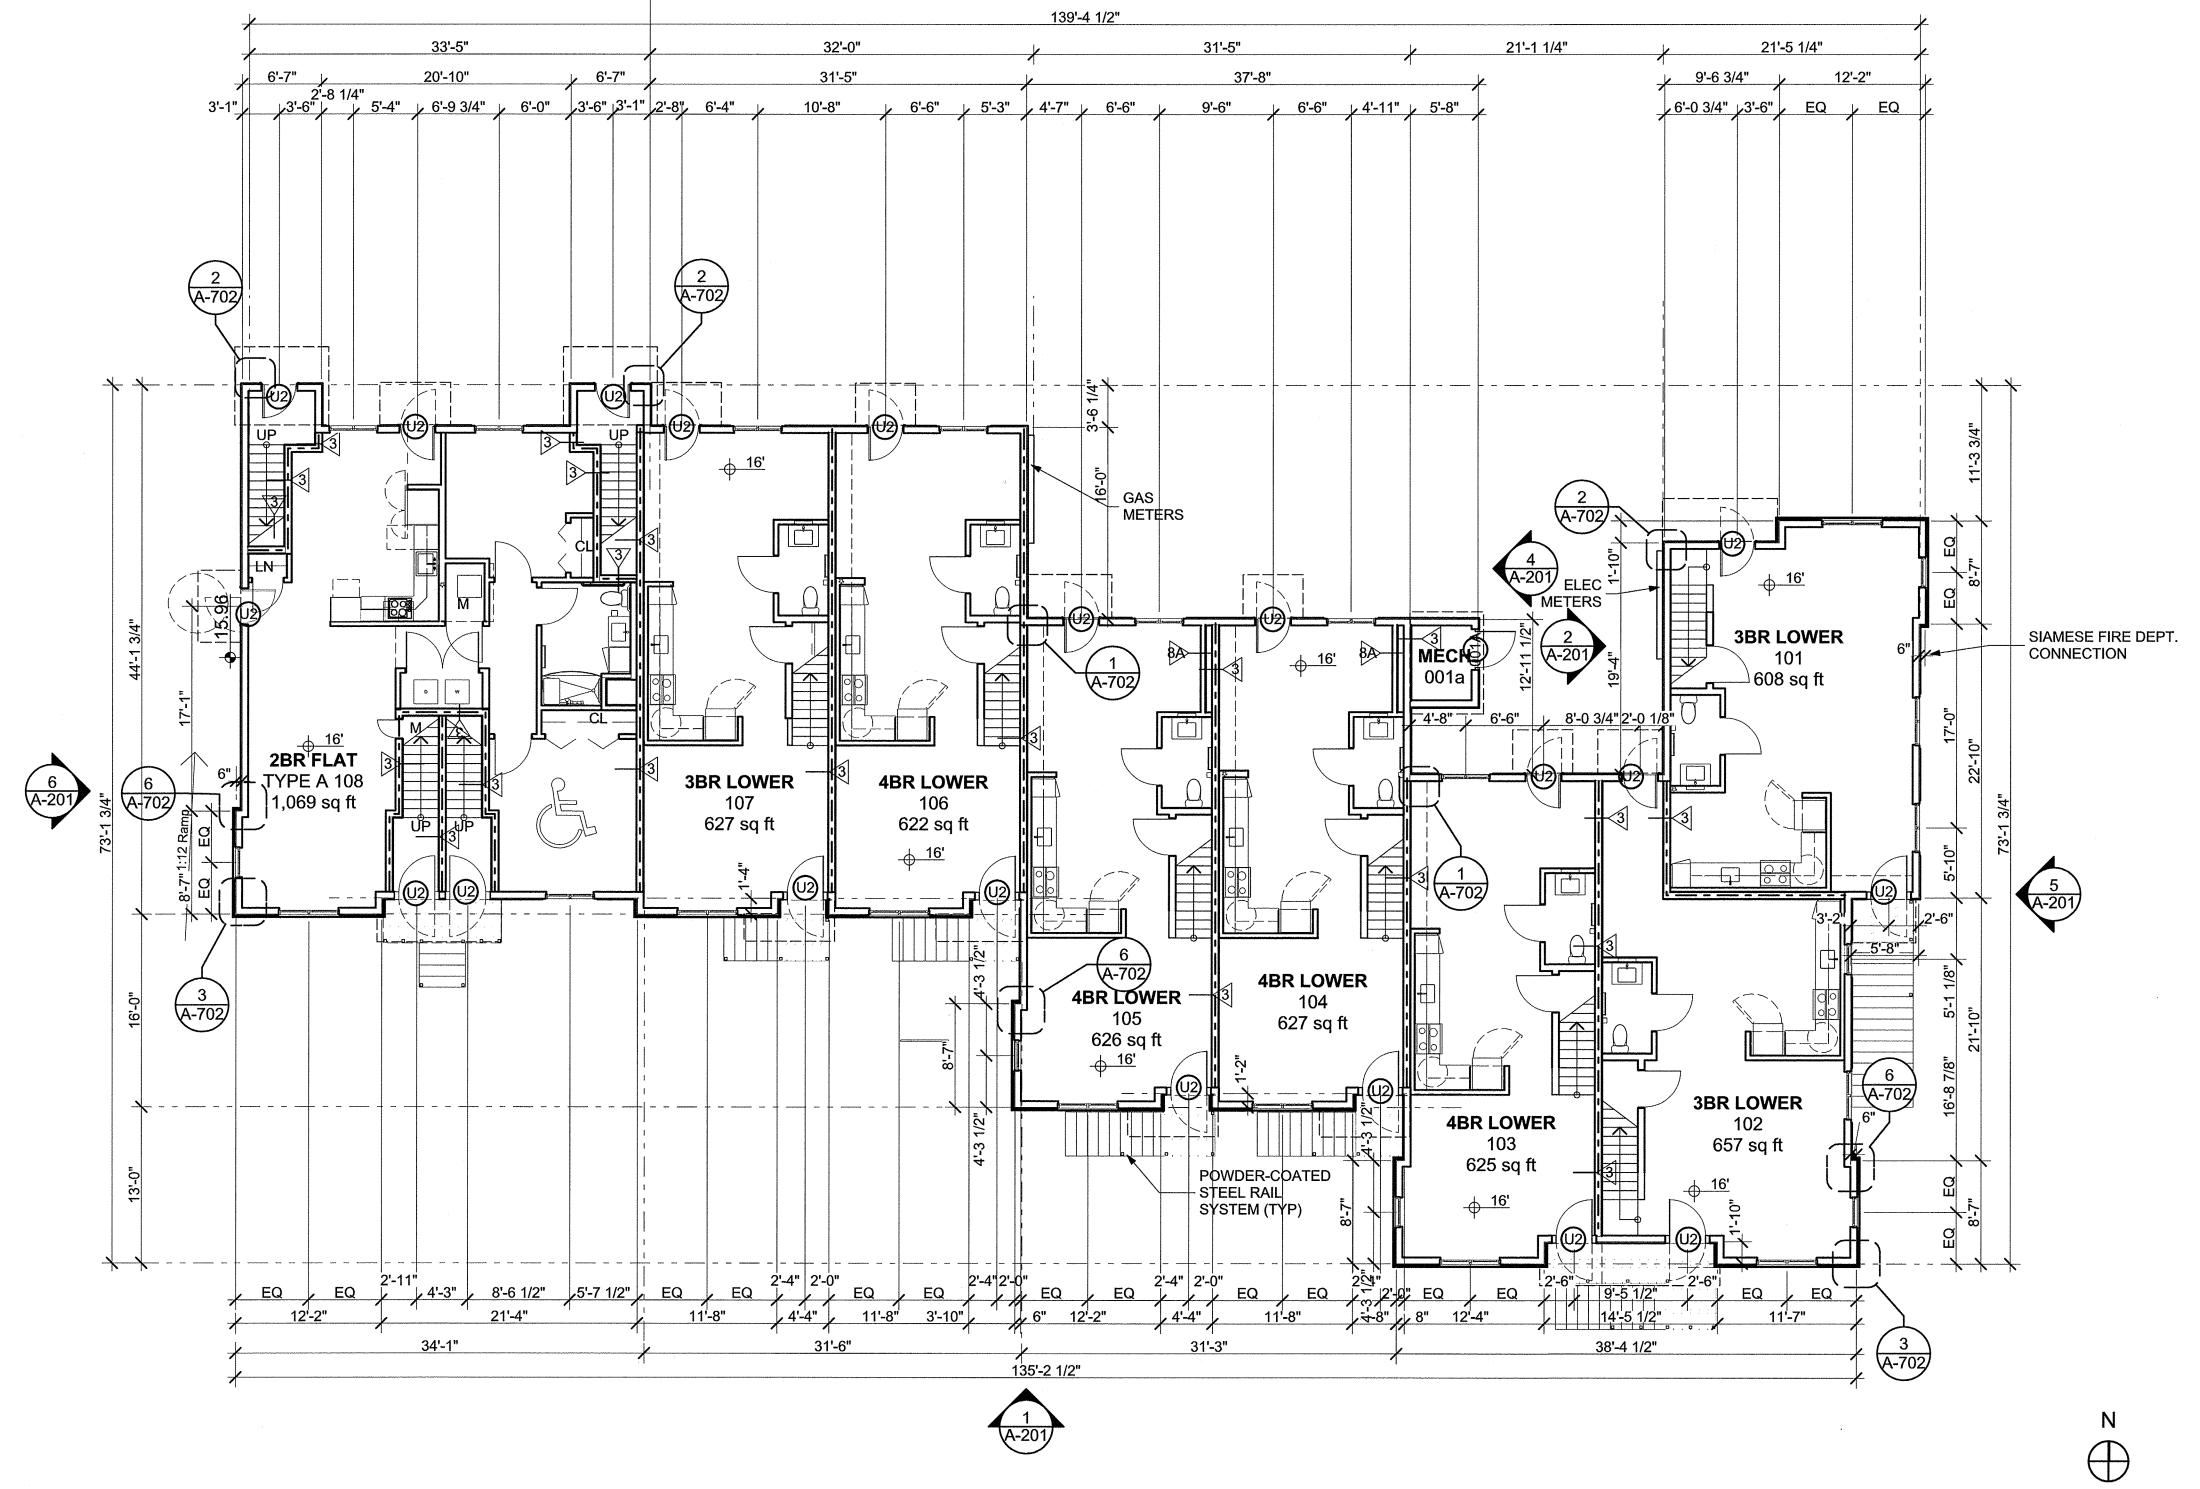

FIRST FLOOR

SCALE: 1/8" = 1'-0"

## Washington Village Phase 1

## 13 Day Street Building A

Norwalk, CT

Trinity Washington Village Limited Partnership & the Norwalk Housing Authority



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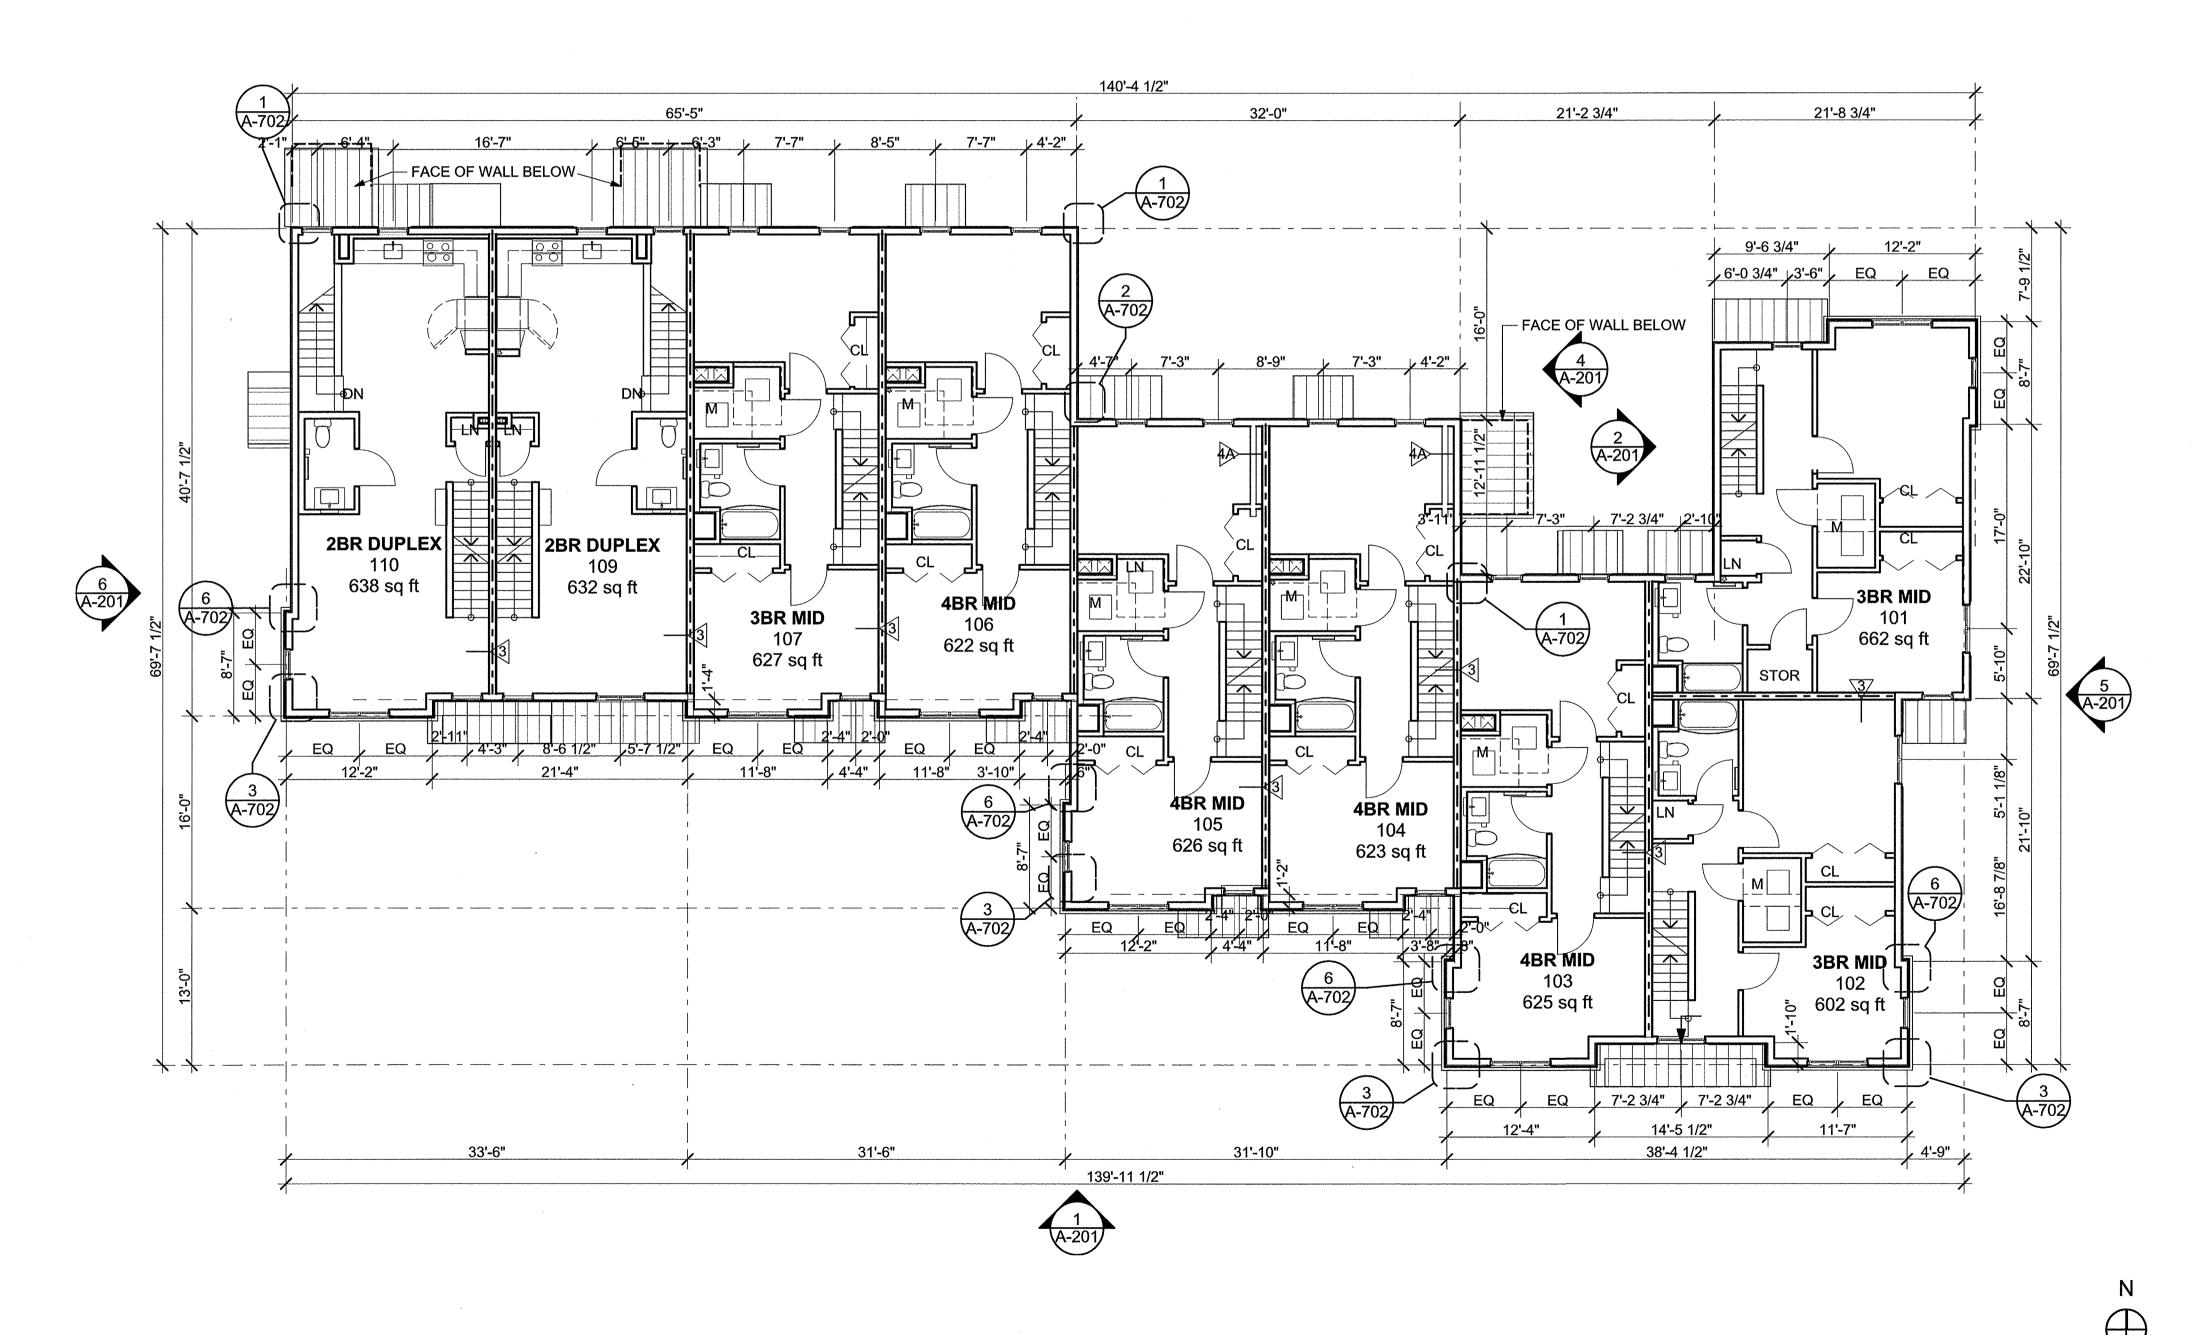
MARK DATE DESCRIPTION

PROJECT NO.: 21222
DRAWN BY: JR,AF,GA,KH,SO
CHECKED BY: KH

SHEET TITLE

BUILDING A FIRST FLOOR PLAN

A-102



## Washington Village Phase 1

### 13 Day Street Building A

Norwalk, CT


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	09-15-2014	PERMIT/ PRICING
	06-13-2014	PRICING
	11-18-2013	40% CHFA
	09-19-2013	CAM/ SPECIAL PERMI
MARK	DATE	DESCRIPTION

PROJECT NO.: 21222 DRAWN BY: JR,AF,GA,KH,SO CHECKED BY: KH


SHEET TITLE

**BUILDING A SECOND** FLOOR PLAN

A-103

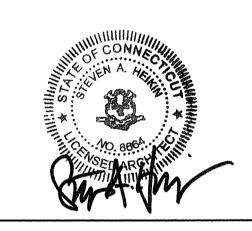SECOND FLOOR

SCALE: 1/8" = 1'-0"

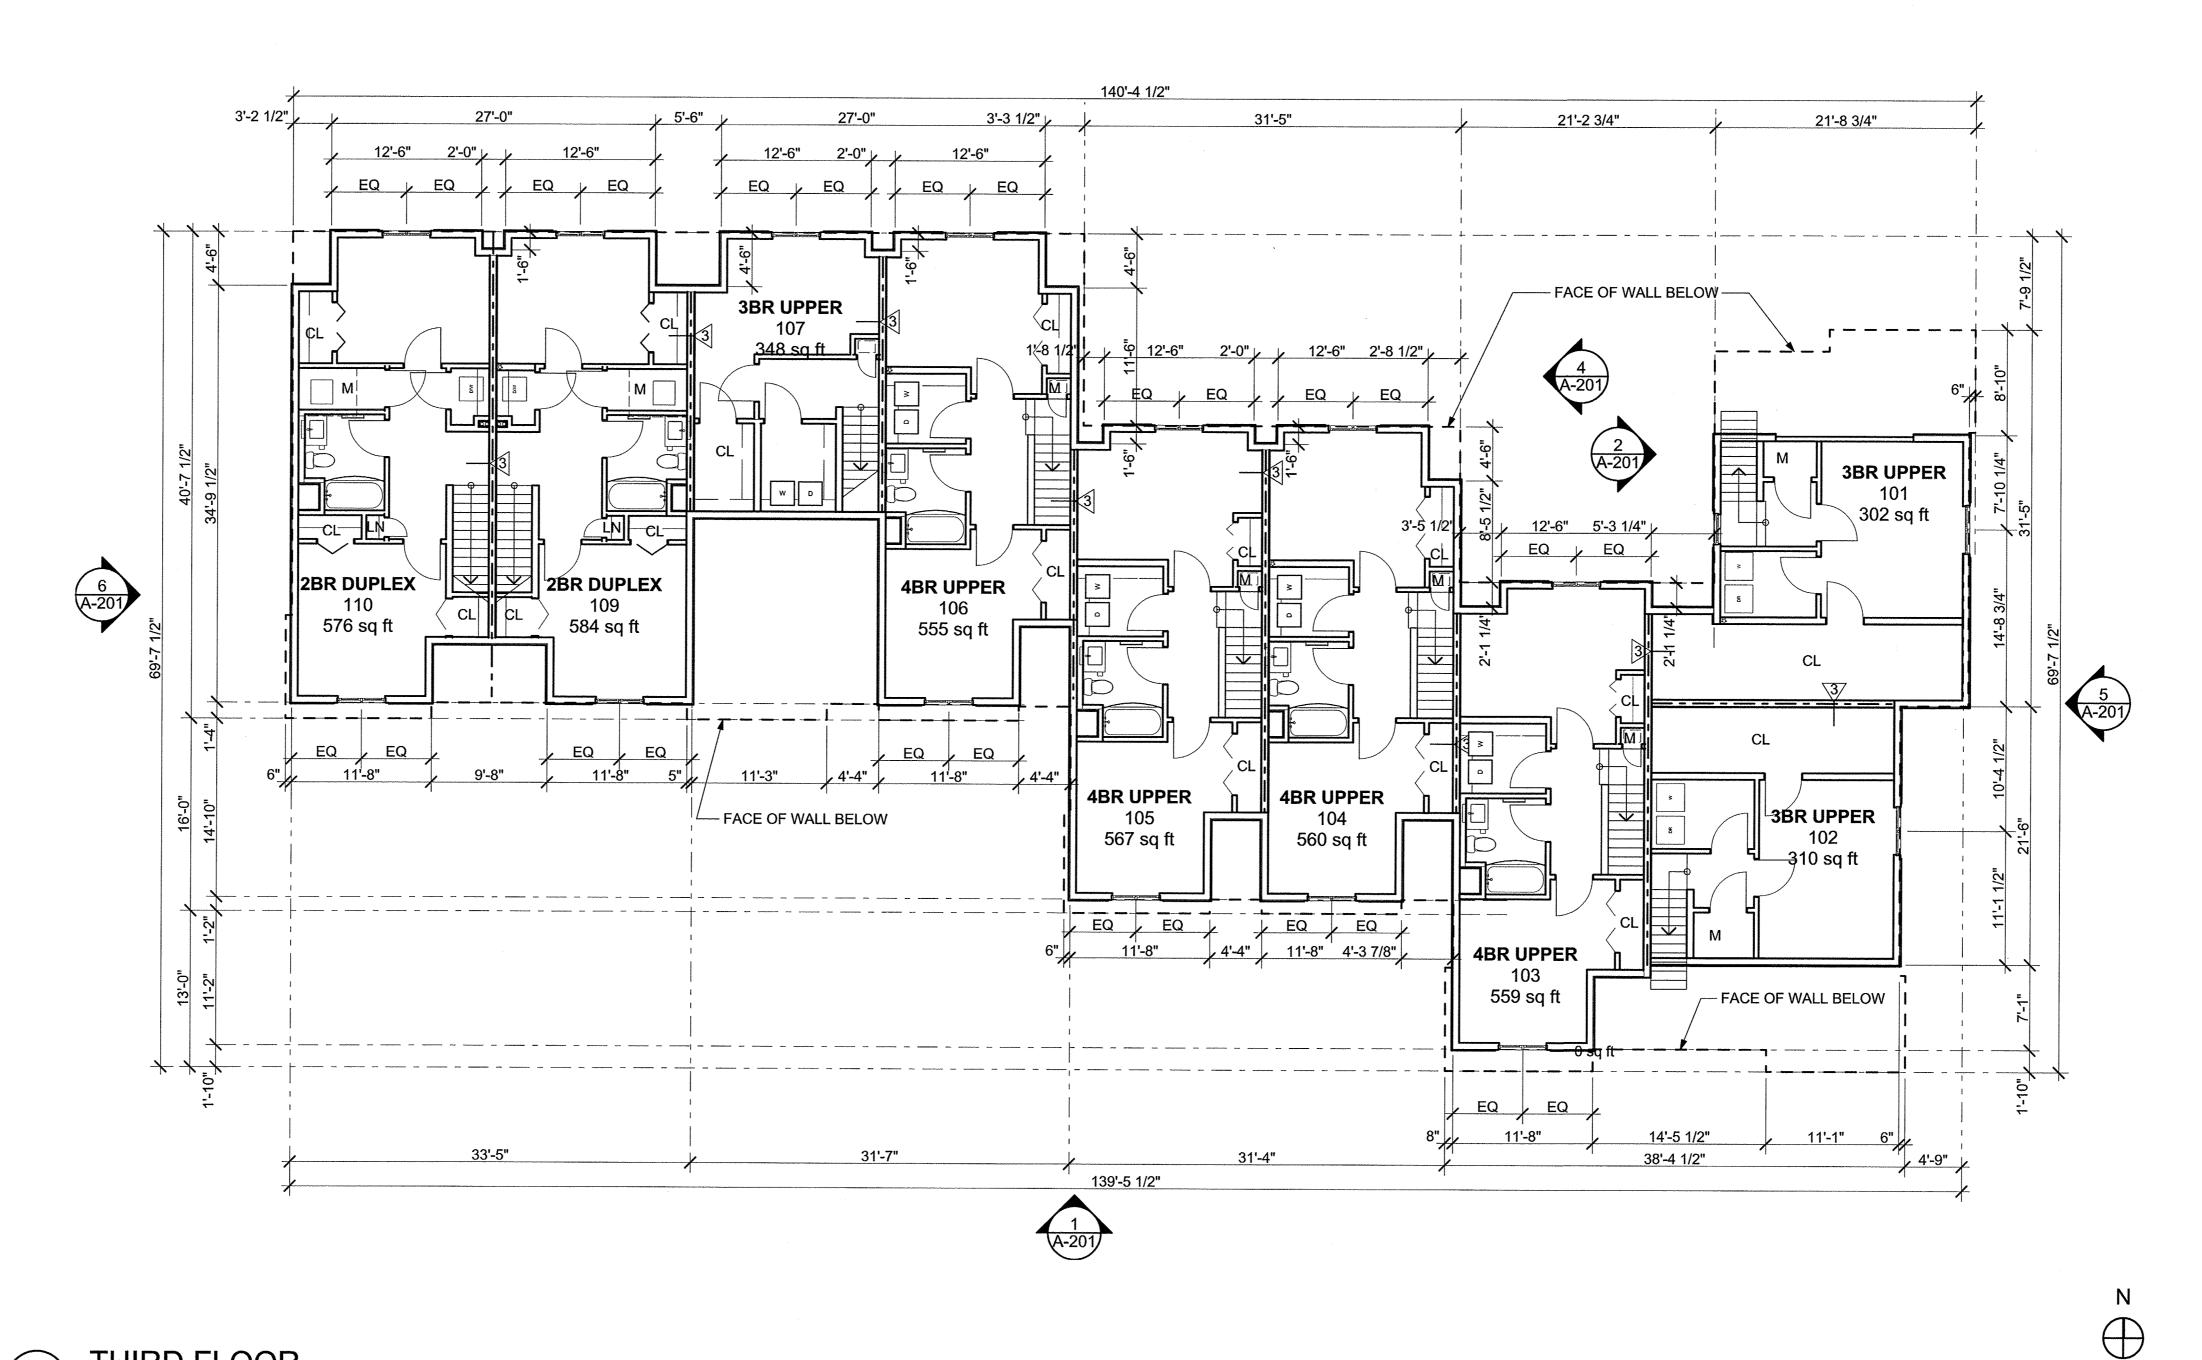

## Washington Village Phase 1

### 13 Day Street Building A

Norwalk, CT


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MARK DATE DESCRIPTION

PROJECT NO.: 21222
DRAWN BY: JR,AF,GA,KH,SO
CHECKED BY: KH

SHEET TITLE

BUILDING A THIRD FLOOR PLAN

A-104

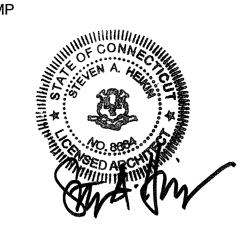
THIRD FLOOR

SCALE: 1/8" = 1'-0"

#### <u>LEGEND</u>

AREA OF ICE AND WATER SHIELD -EXTENT IS FROM ROOF EDGE TO 36" BACK FROM INTERIOR FACE OF STUD

DRAFTSTOPPING IN ATTICS AT ALL DEMISING WALLS

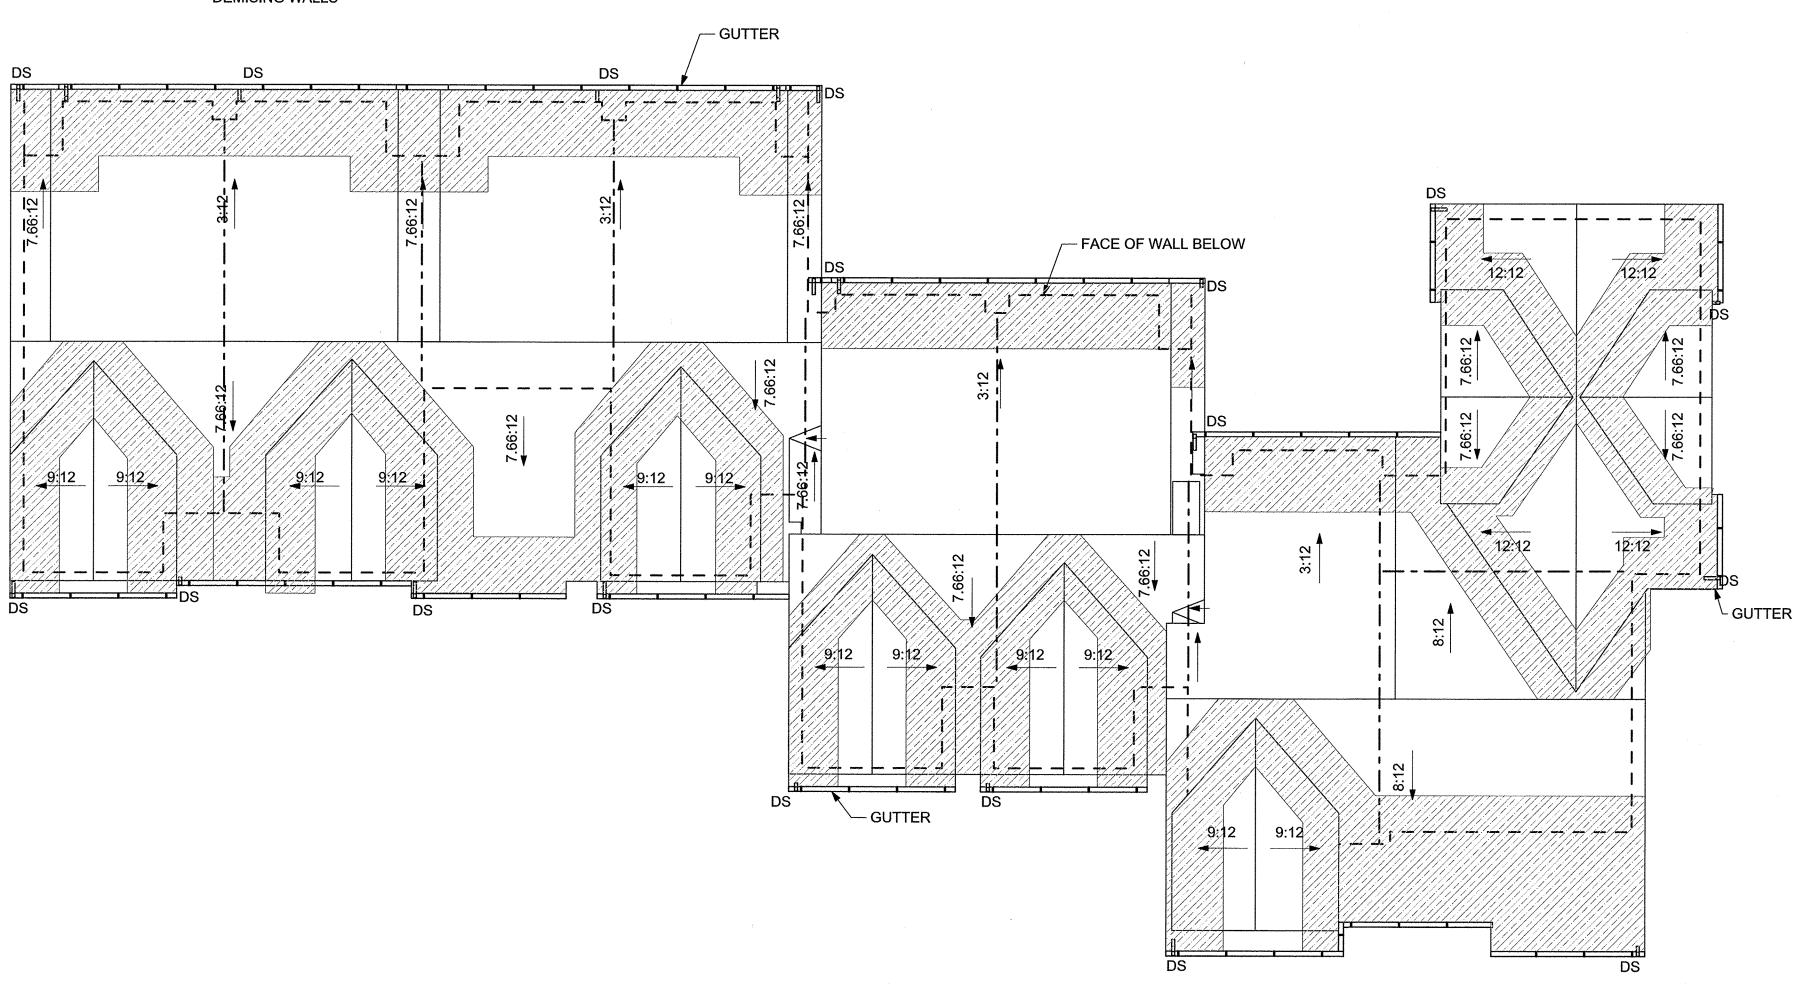

## Washington Village Phase 1

## 13 Day Street Building A

Norwalk, CT


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MARK DATE DESCRIPTION PROJECT NO.: 21222
DRAWN BY: JR,AF,GA,KH,SO
CHECKED BY: KH


SHEET TITLE

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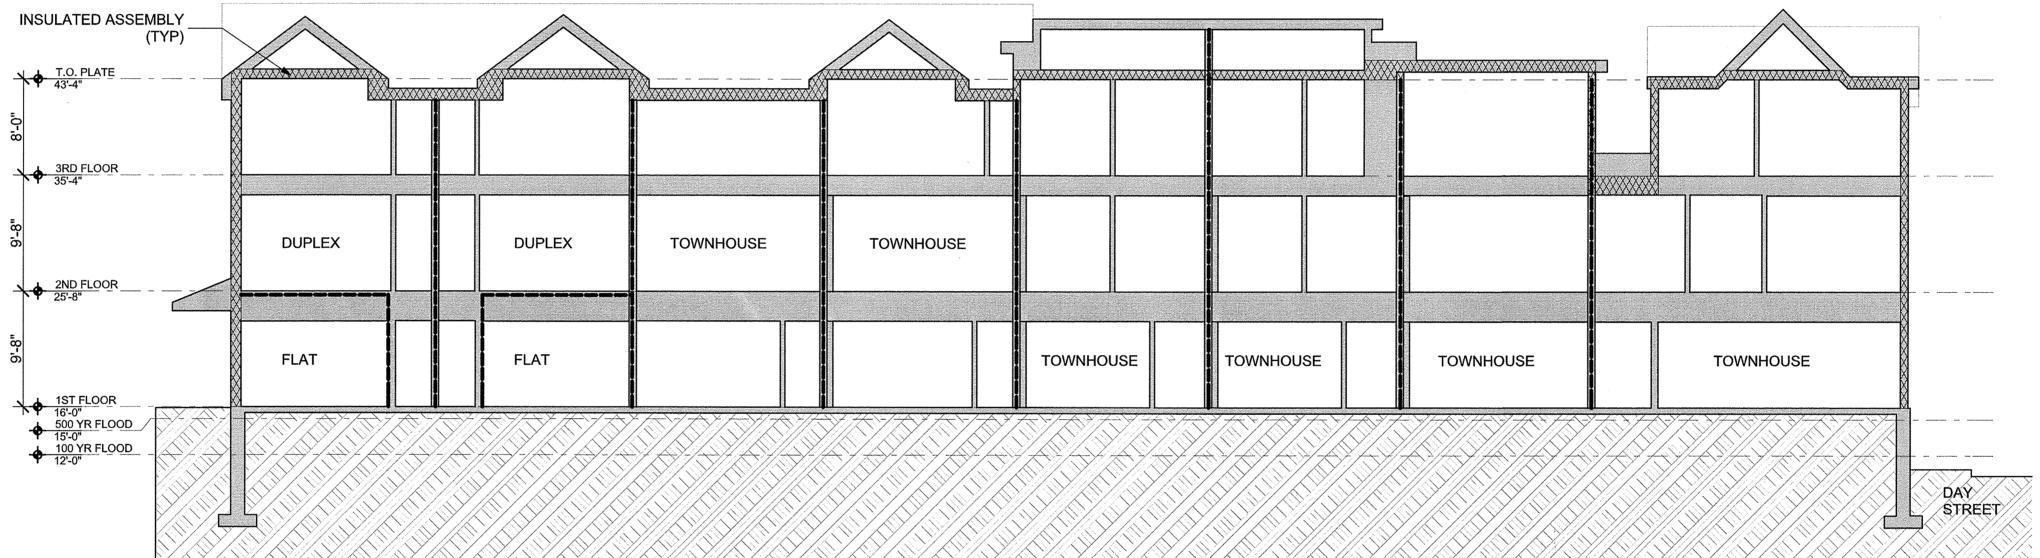
**BUILDING A ROOF** PLAN

A-105

ROOF SCALE: 1/8" = 1'-0"

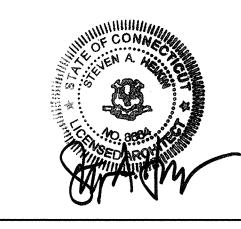


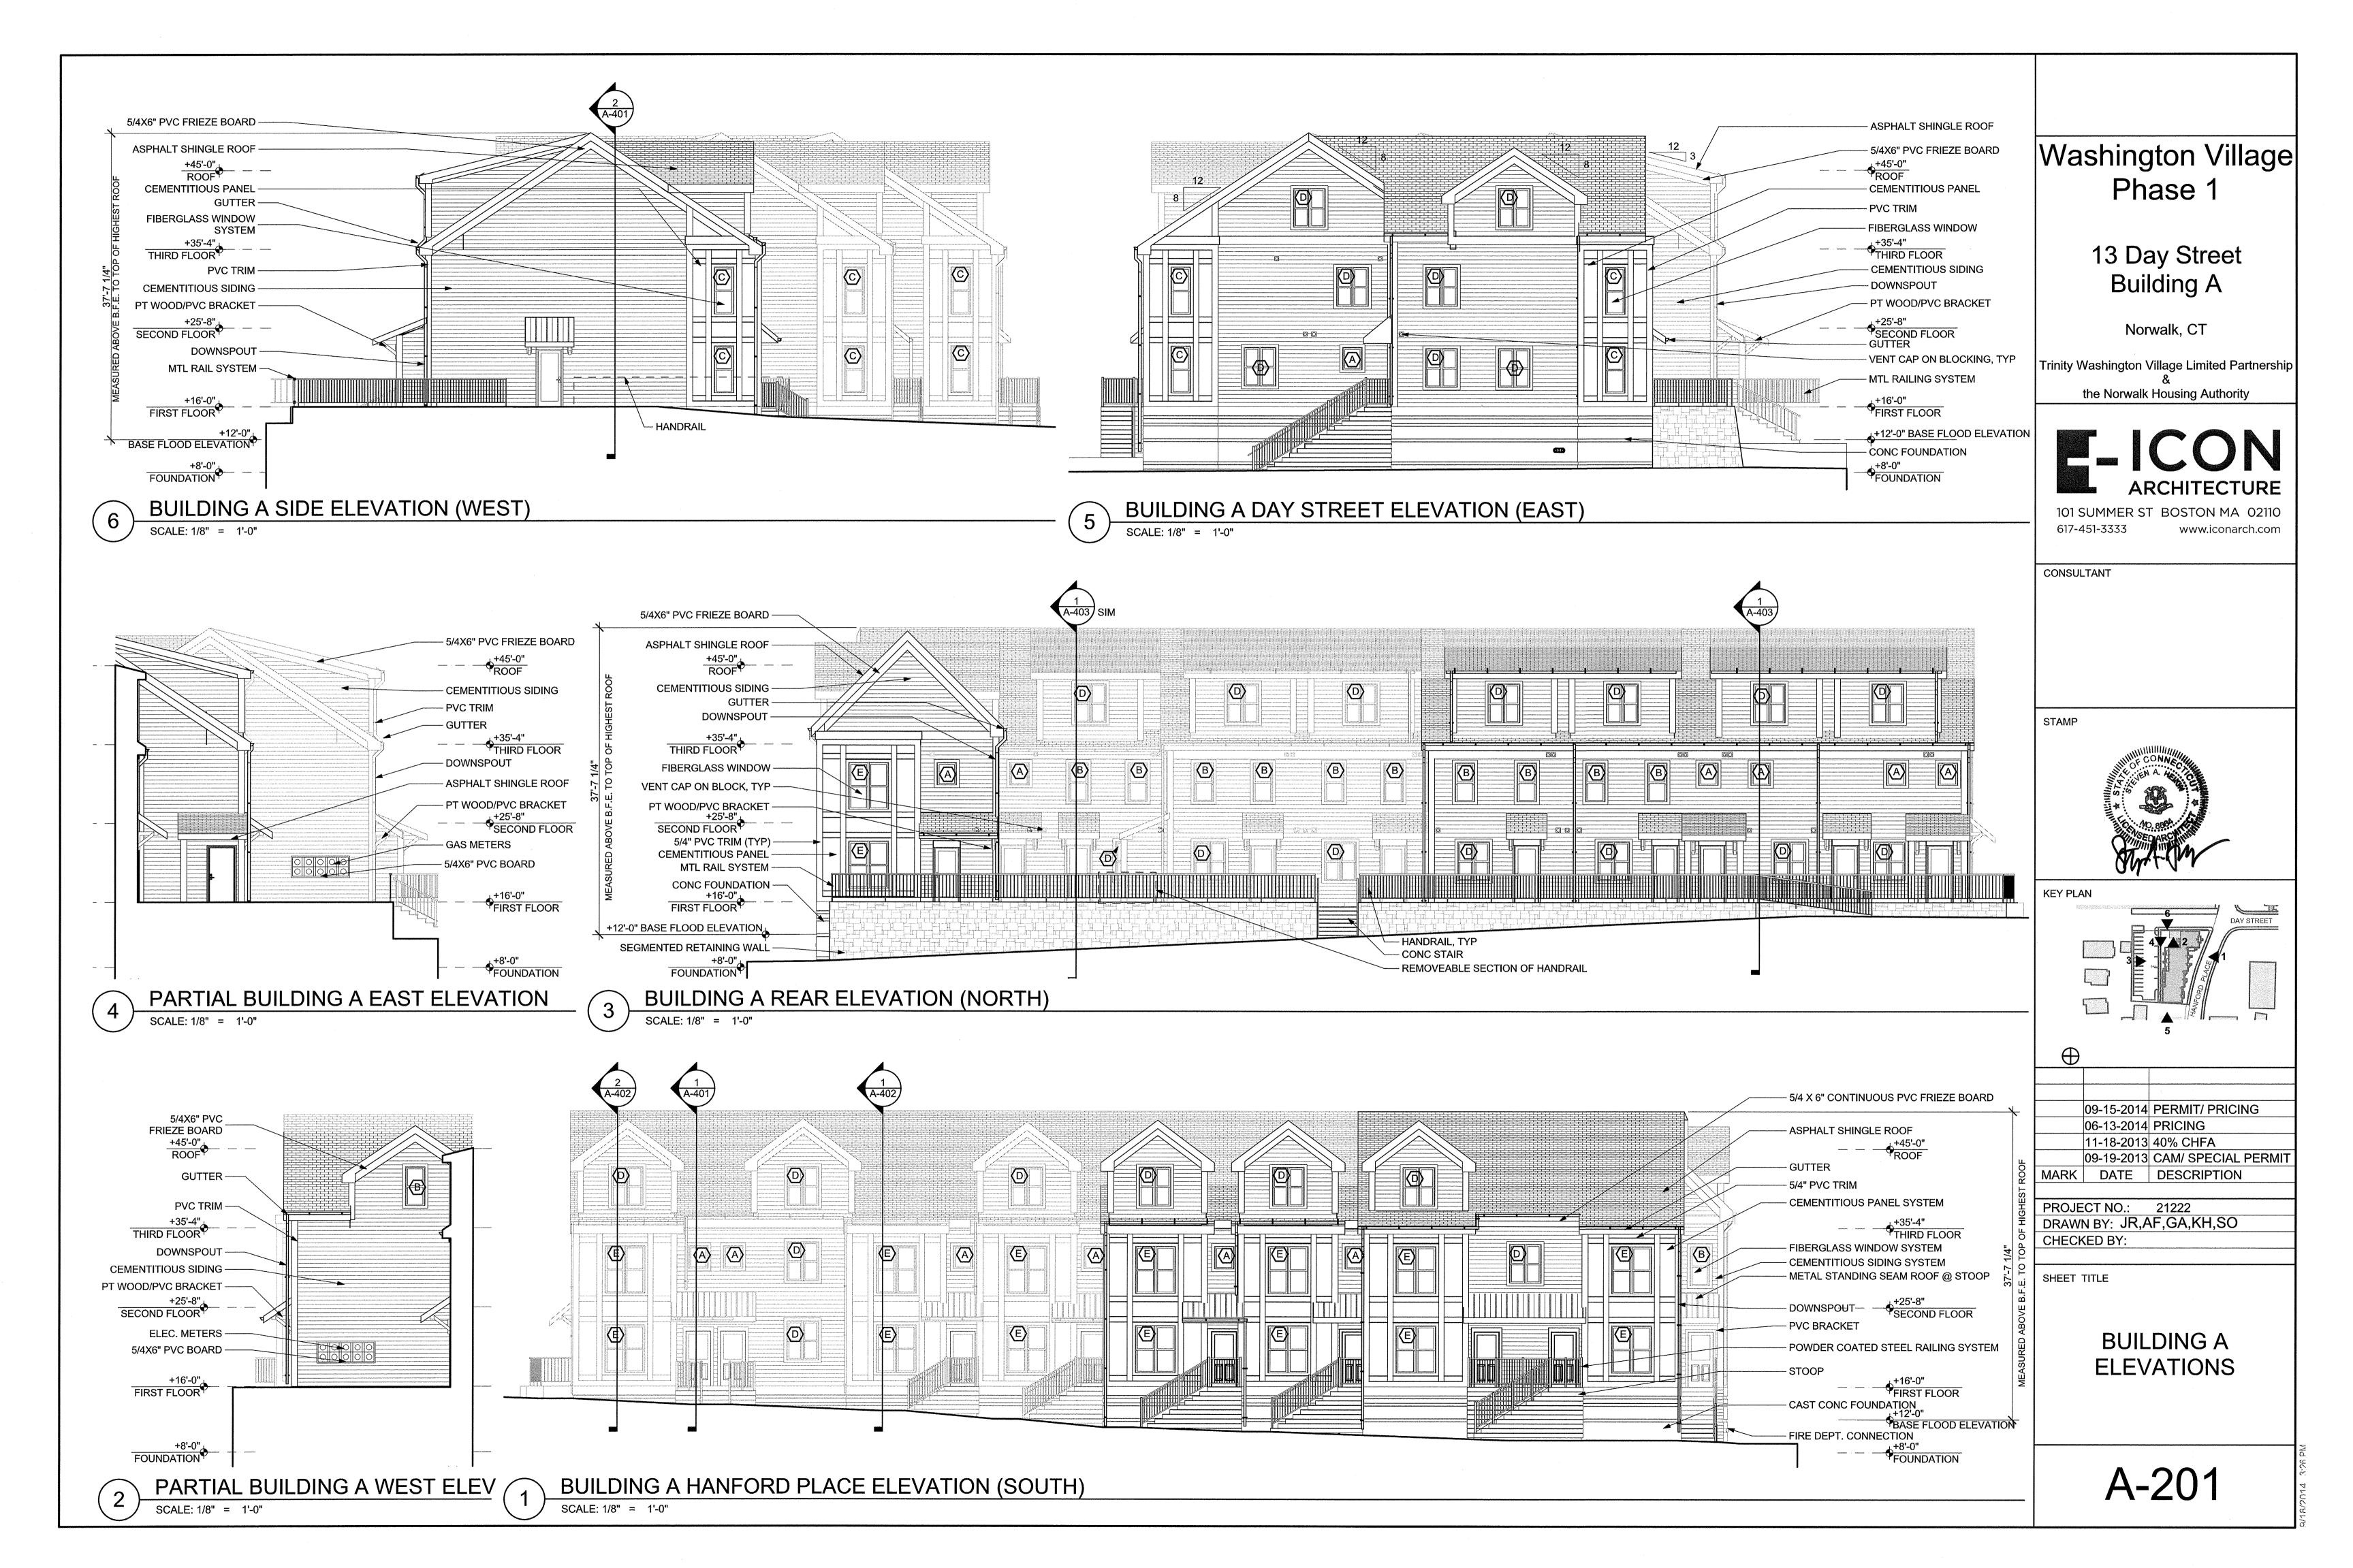



BUILDING A LONGITUDINAL SECTION

SCALE: 1/8" = 1'-0"

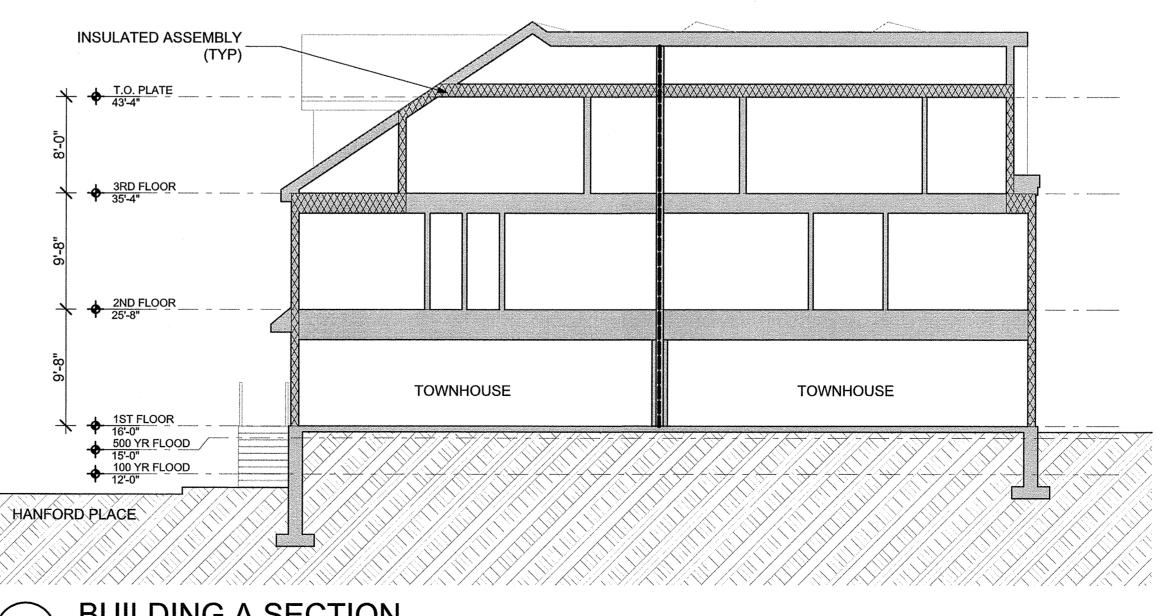

**BUILDING A SECTION** SCALE: 1/8" = 1'-0"

## Washington Village Phase 1

## 13 Day Street Building A

Norwalk, CT

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MARK DATE DESCRIPTION

PROJECT NO.: 21222 DRAWN BY: AF,PG, SW CHECKED BY:

SHEET TITLE

**BUILDING A SECTION** 

A-301

## Washington Village Phase 1

## 13 Day Street Building A

Norwalk, CT


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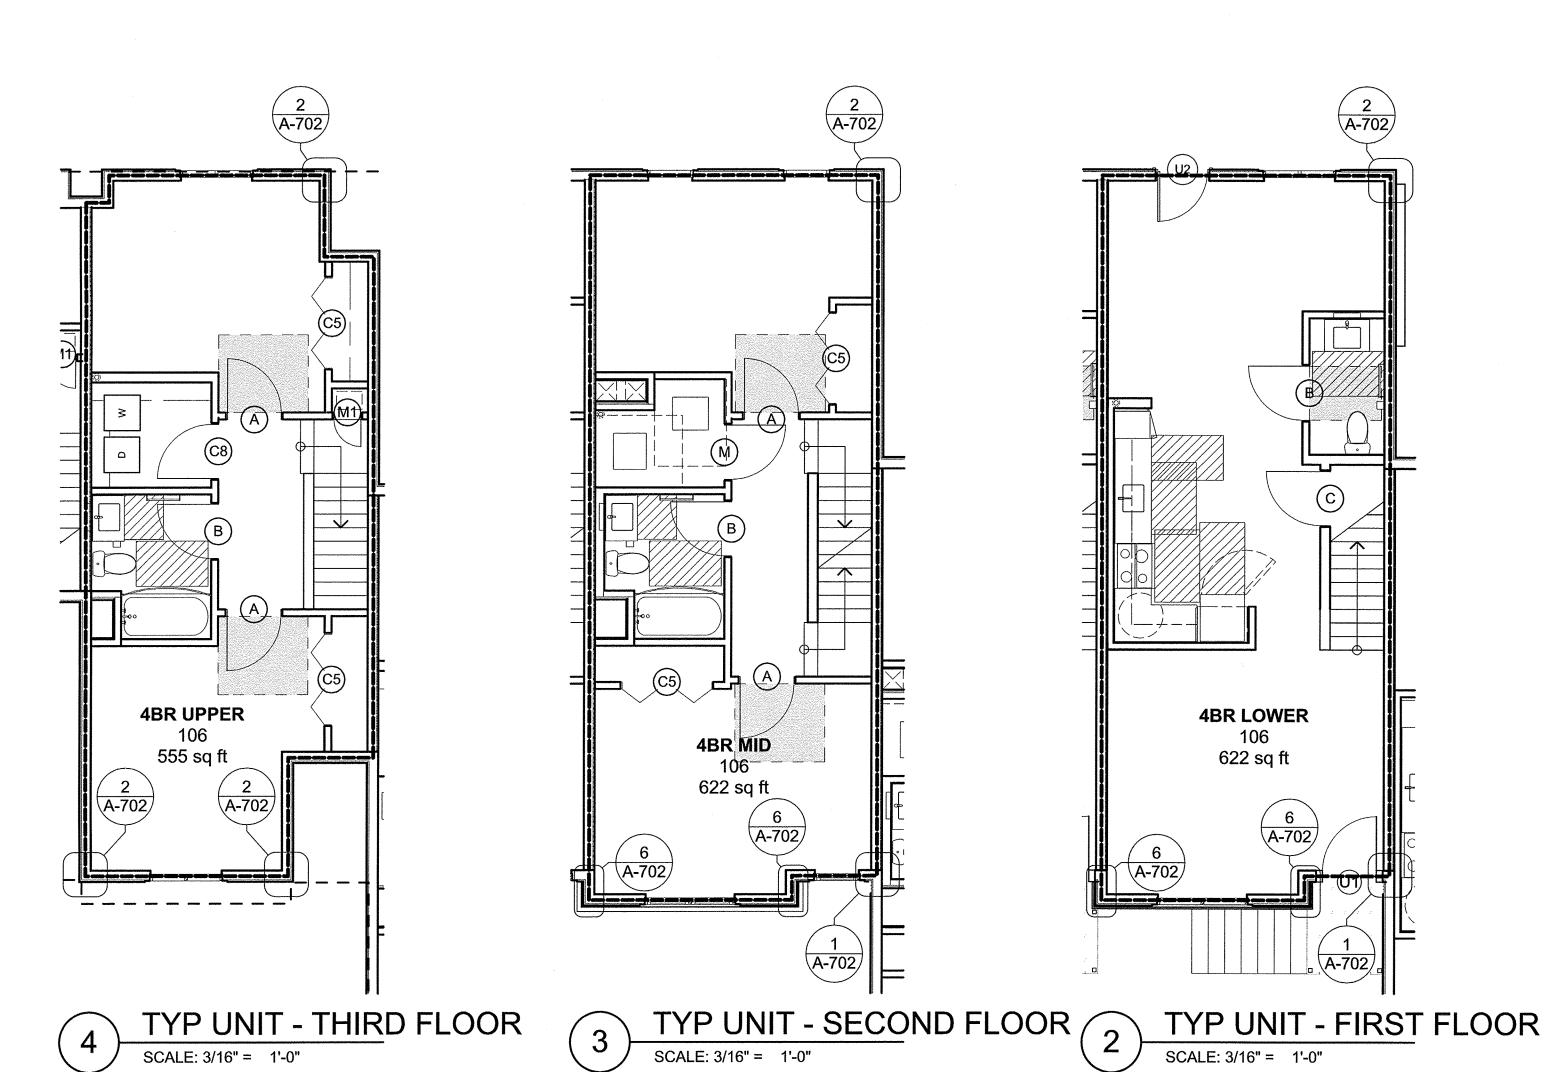


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BUILDING A COMPARTMENTALIZATION SECTION

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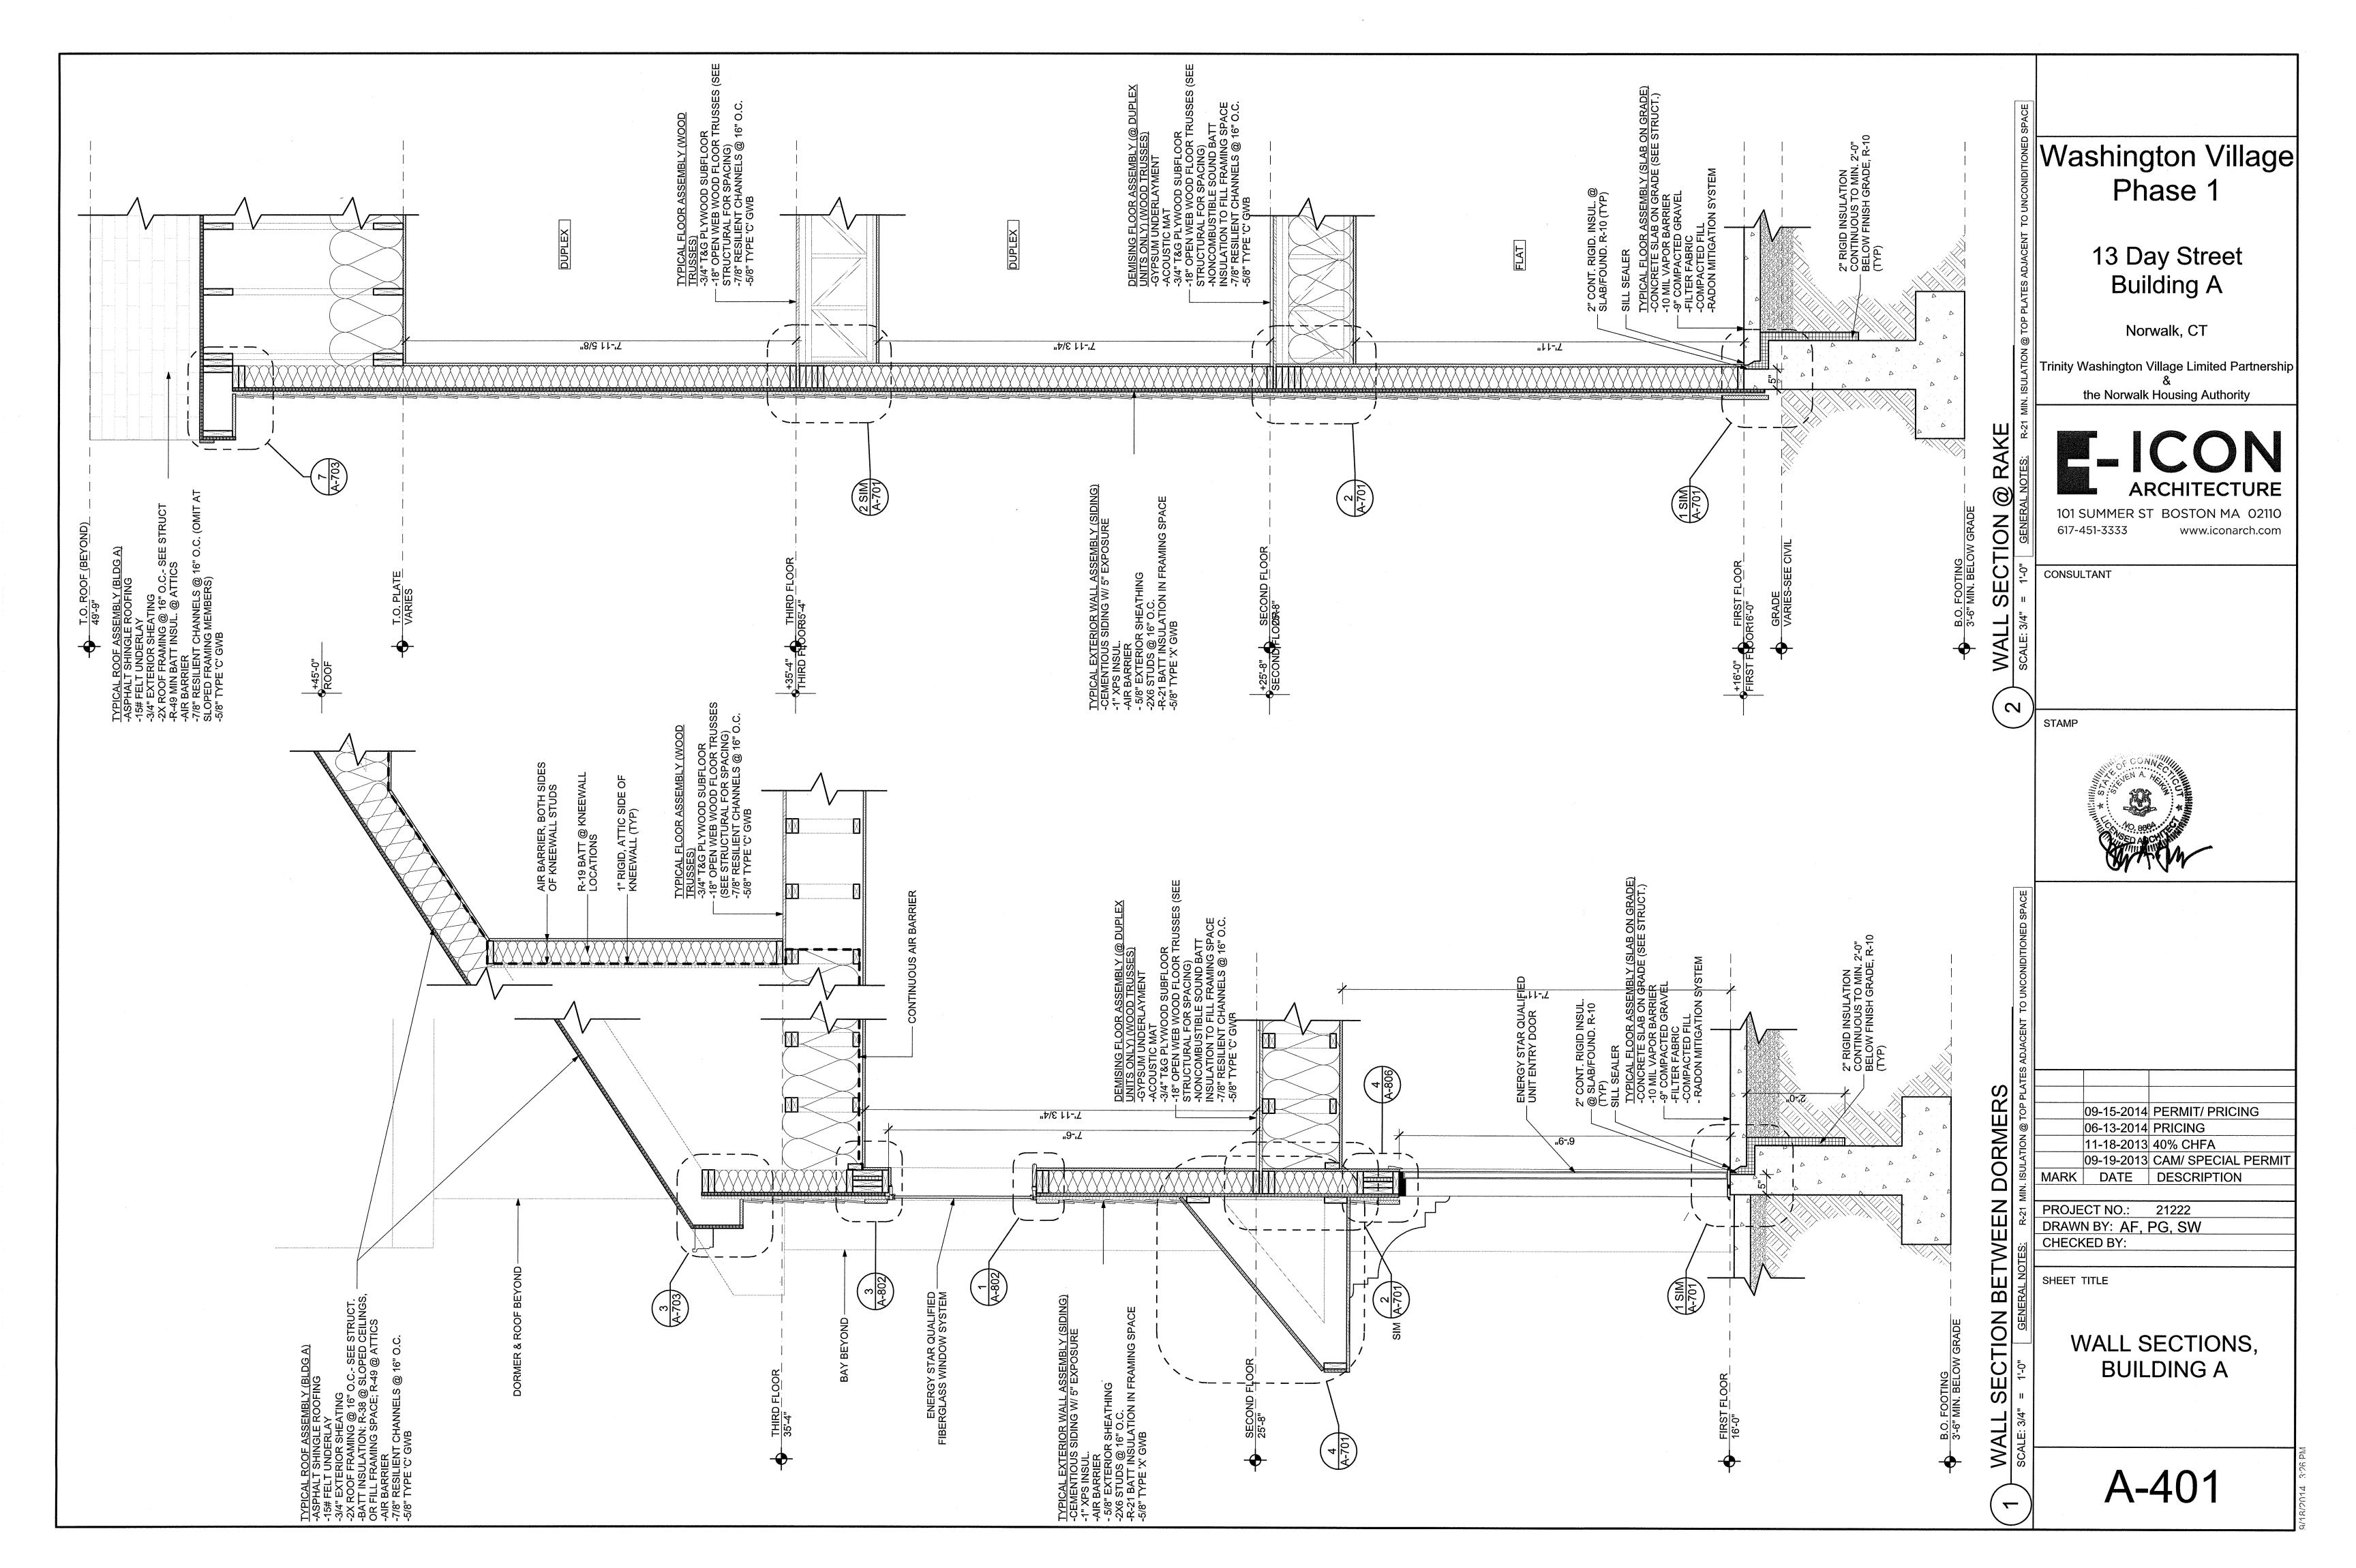
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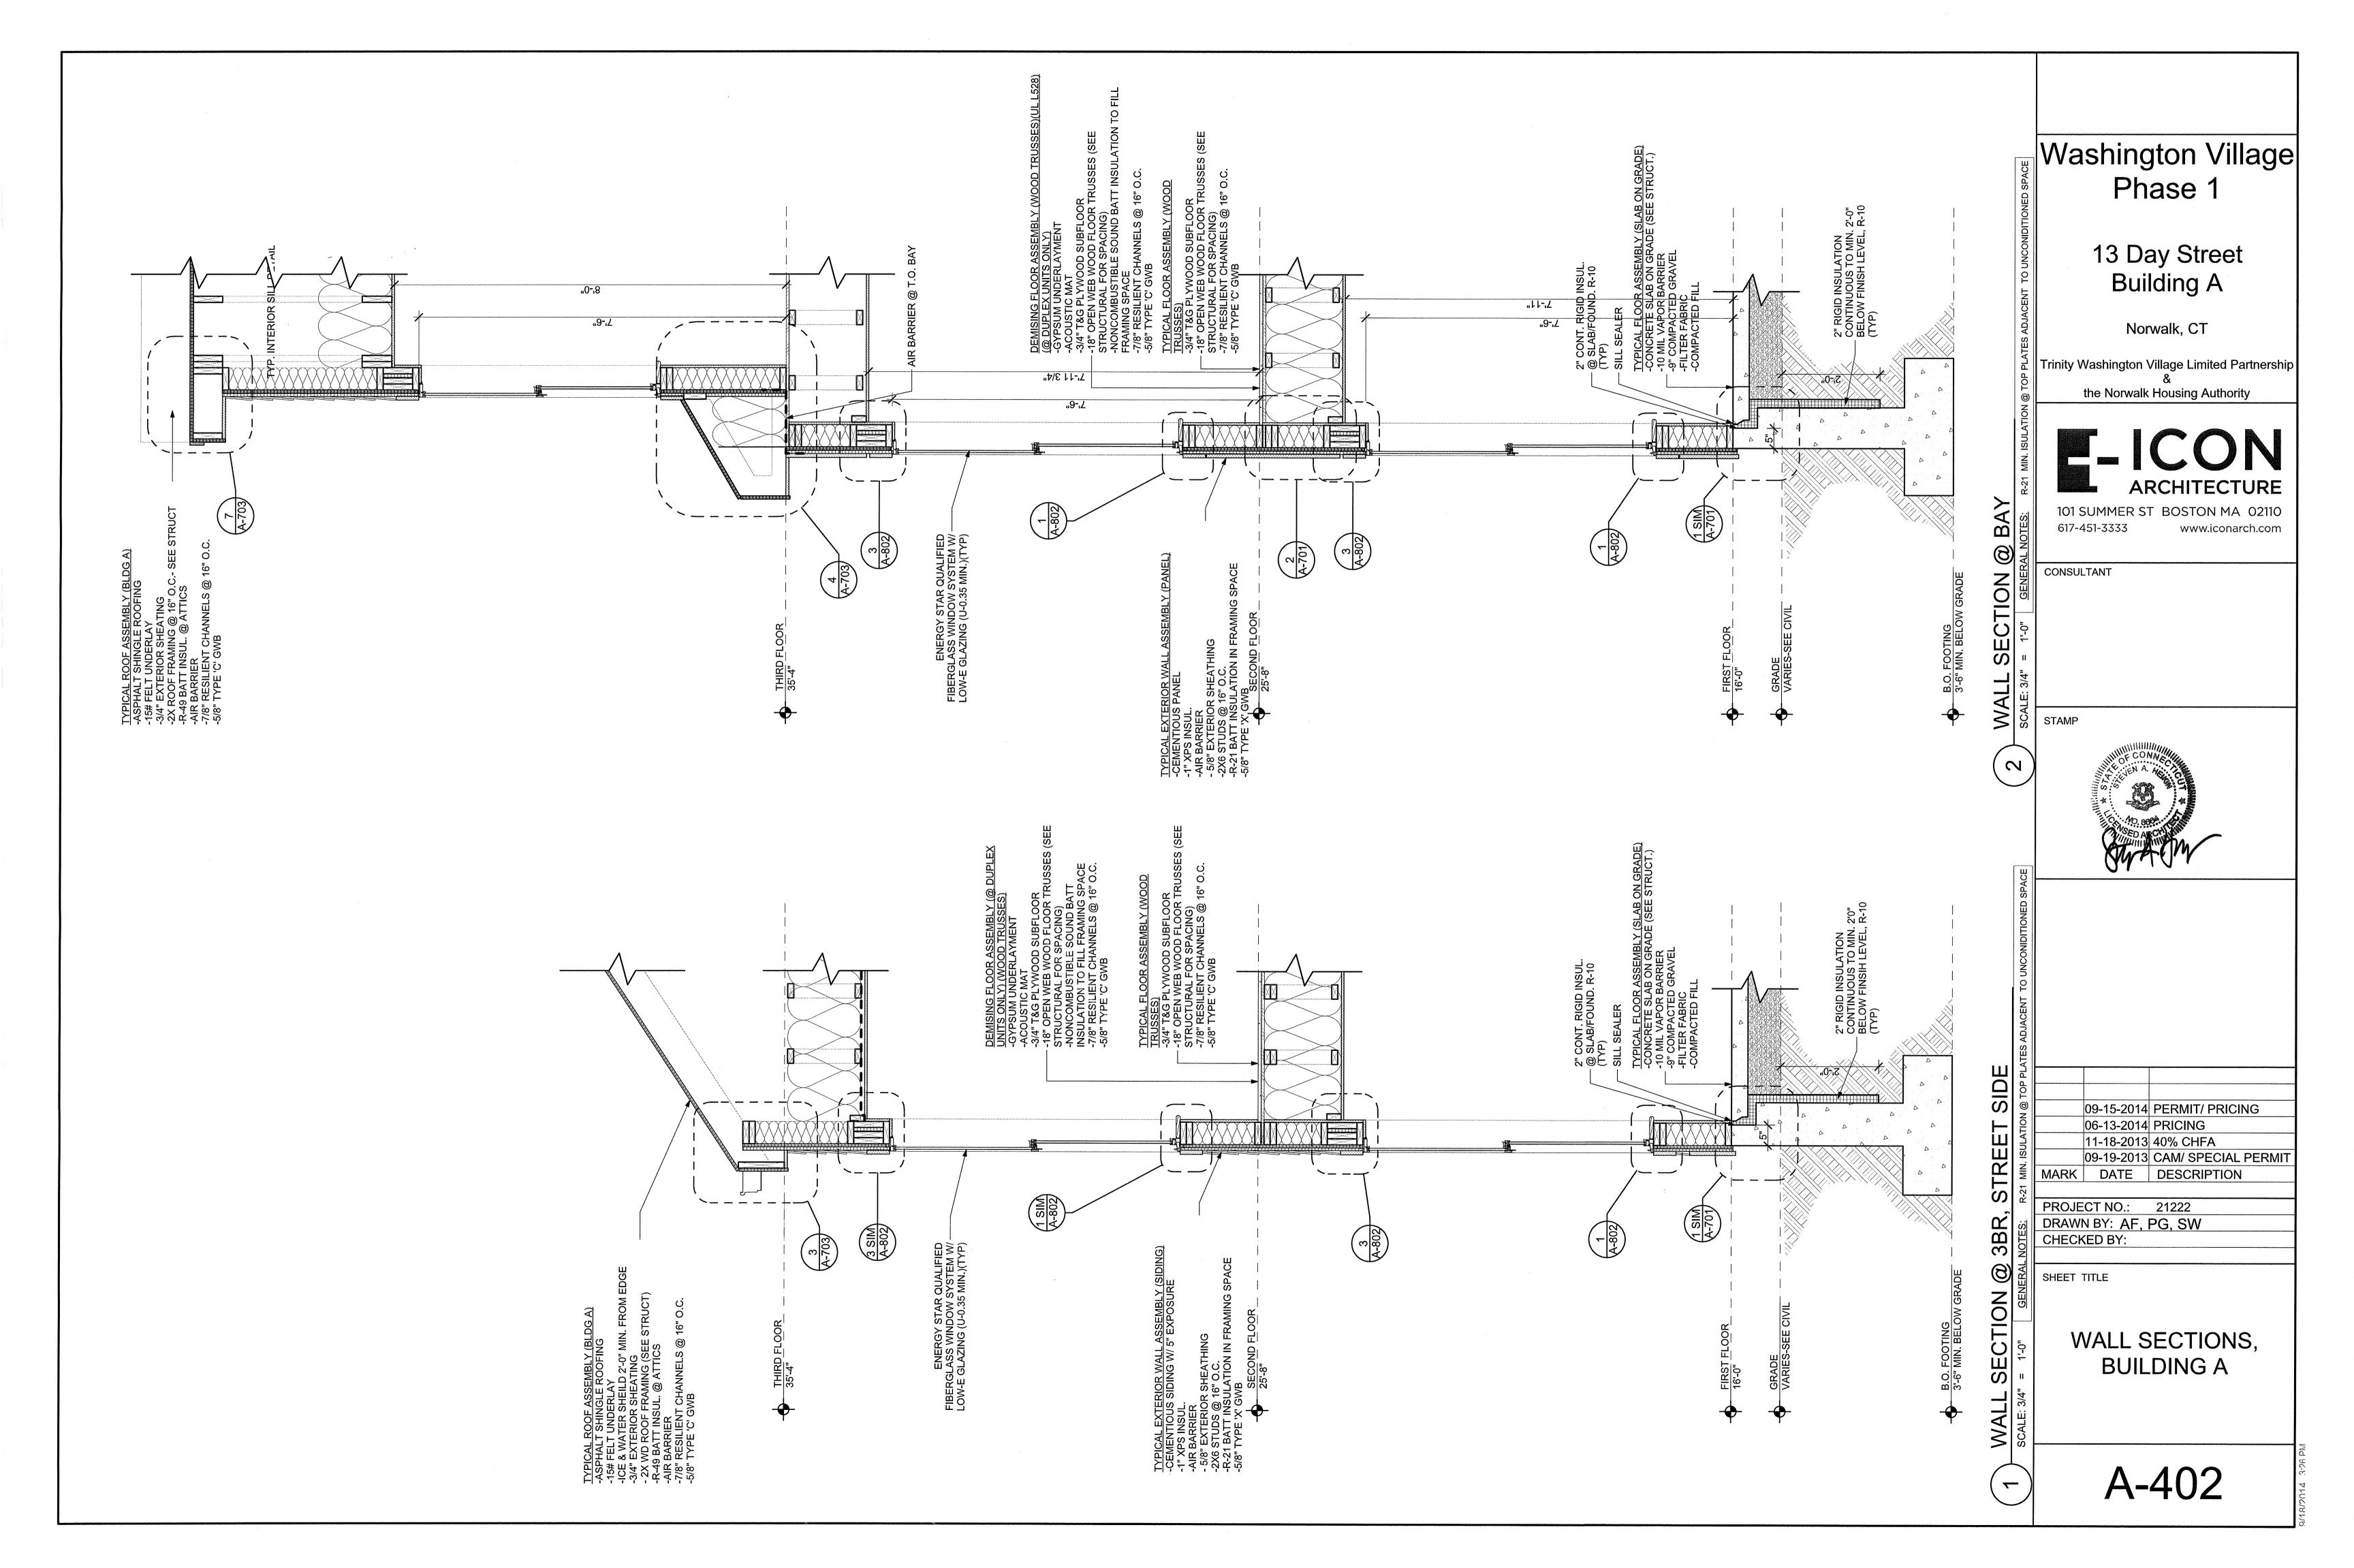
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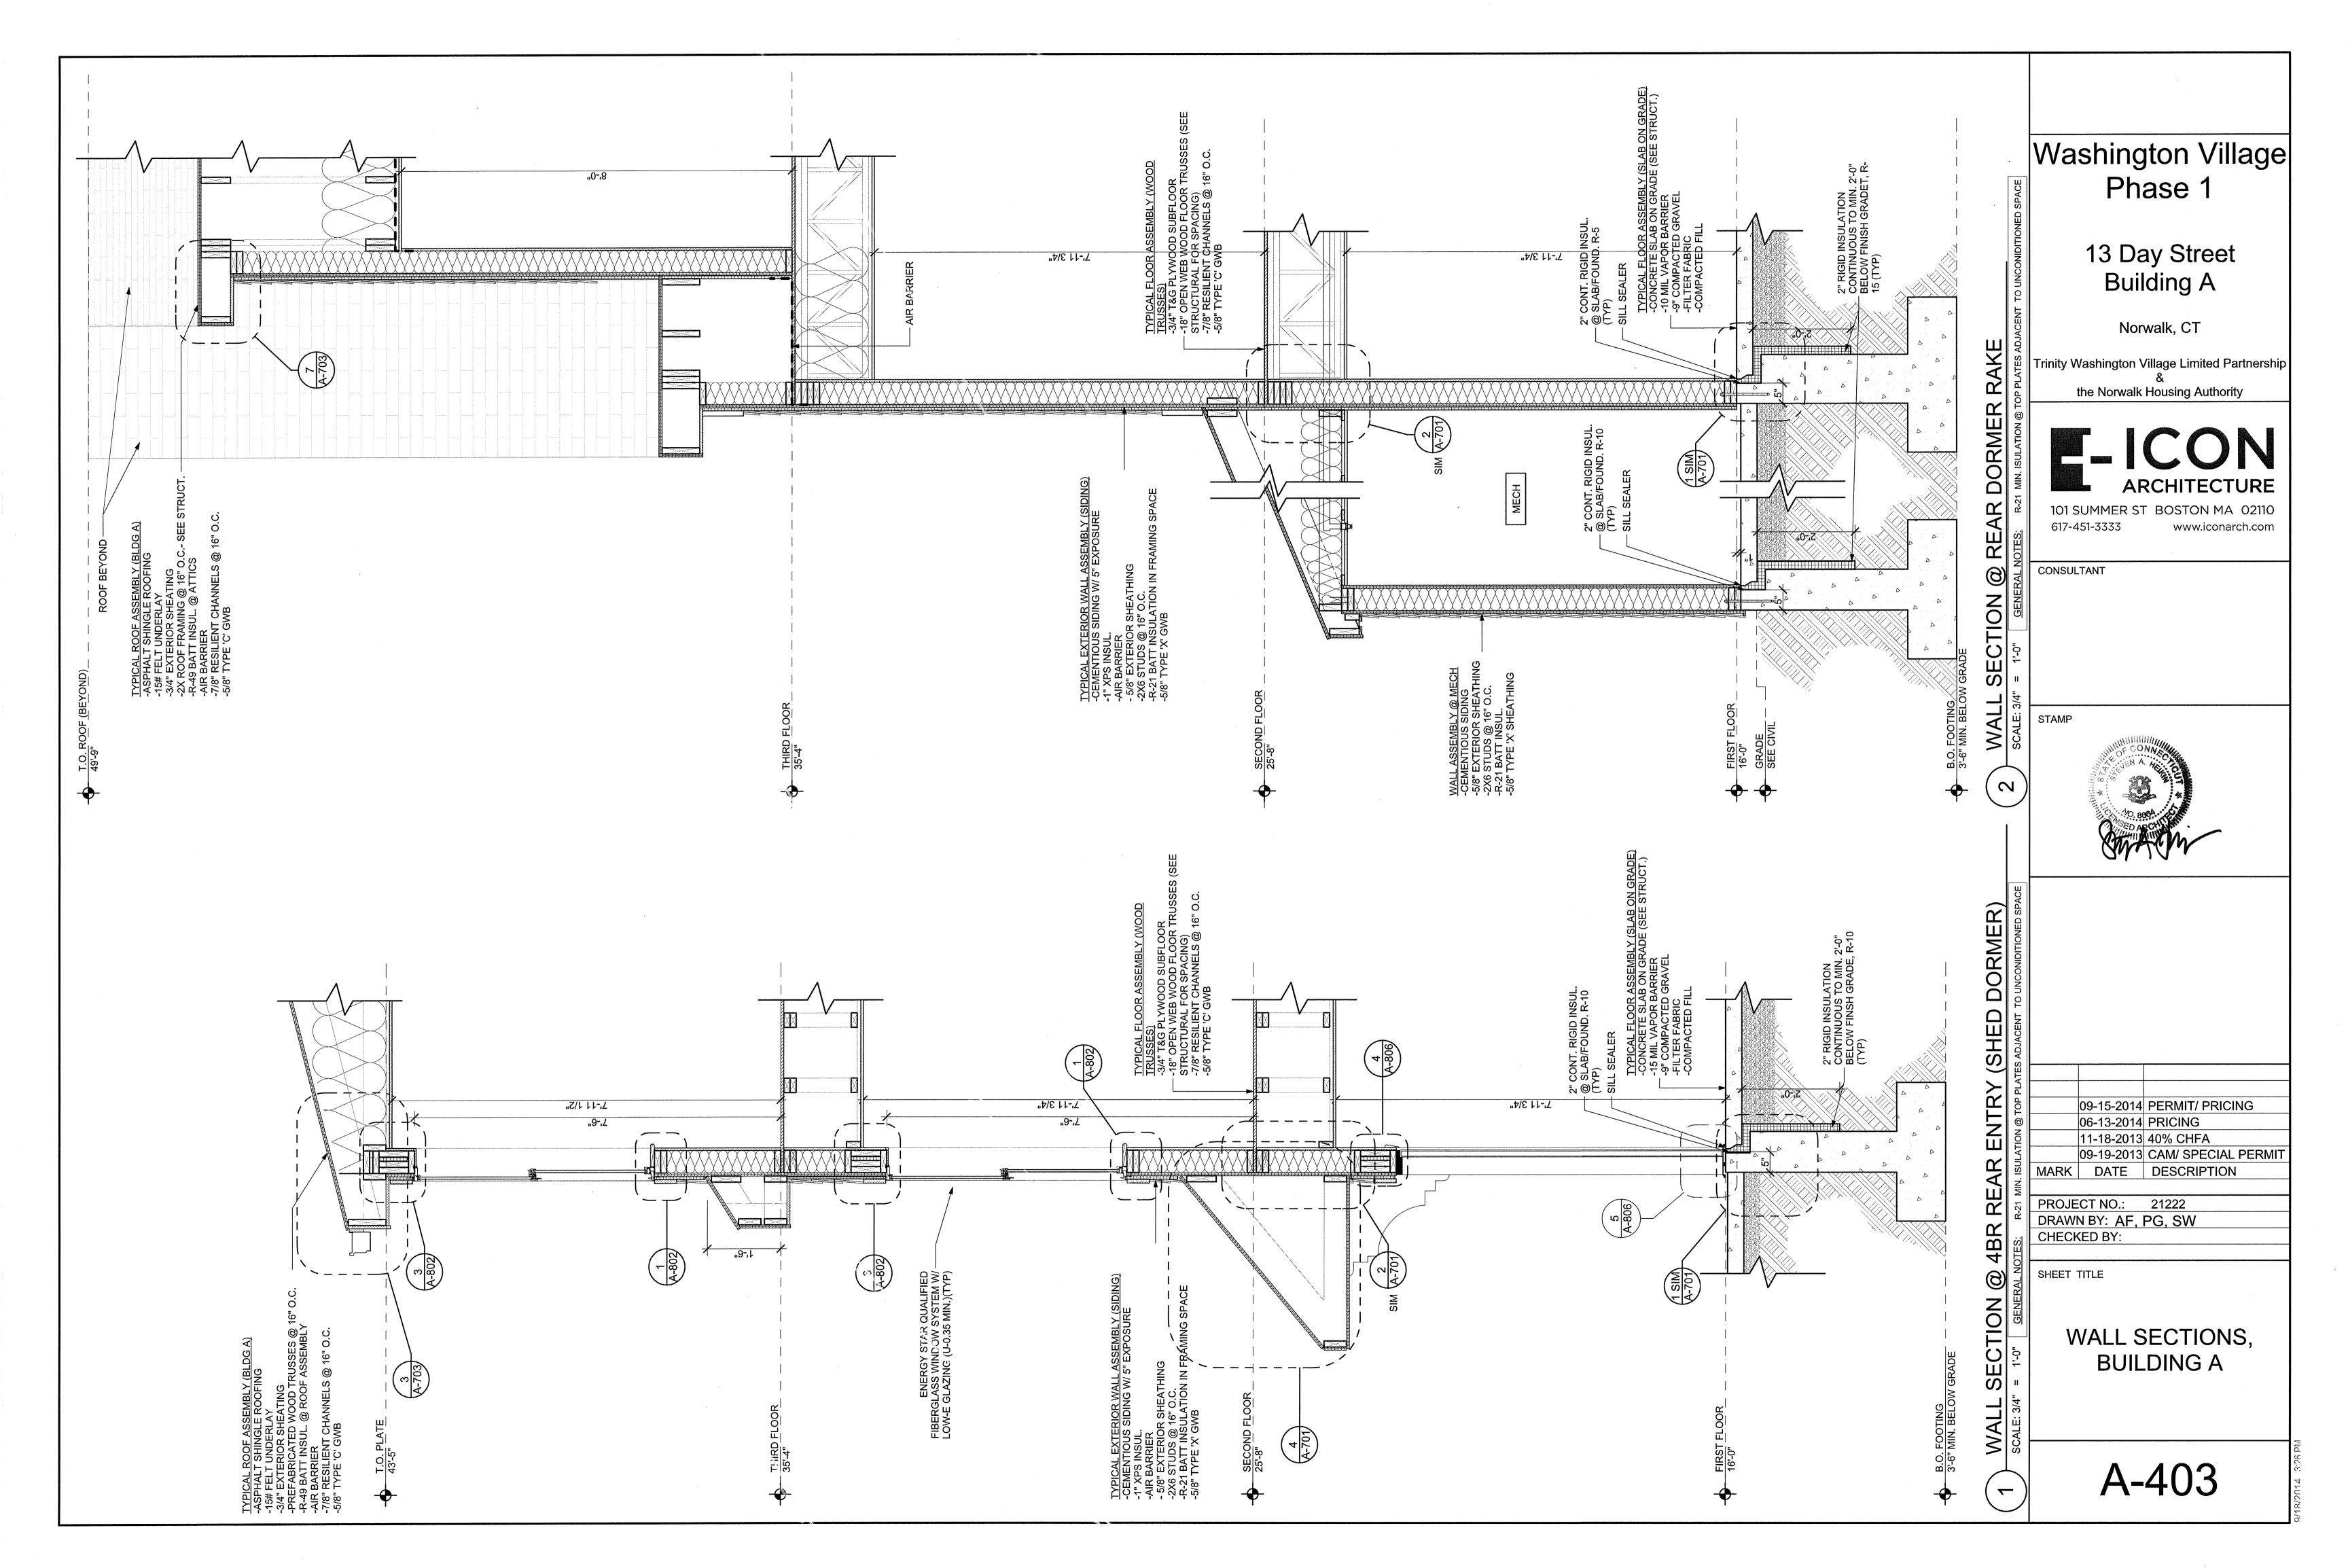
SHEET TITLE


COMPARTMENT -**ALIZATION PLAN** 

A-302

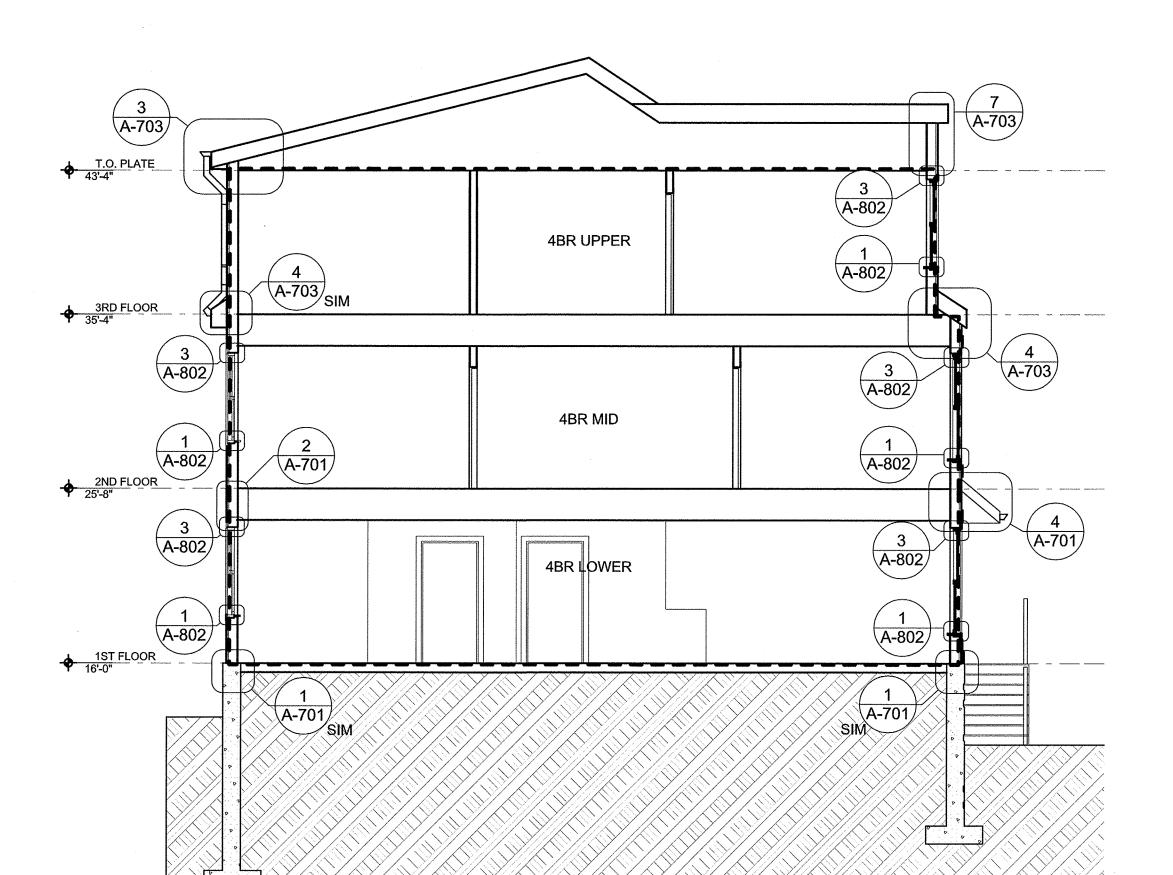





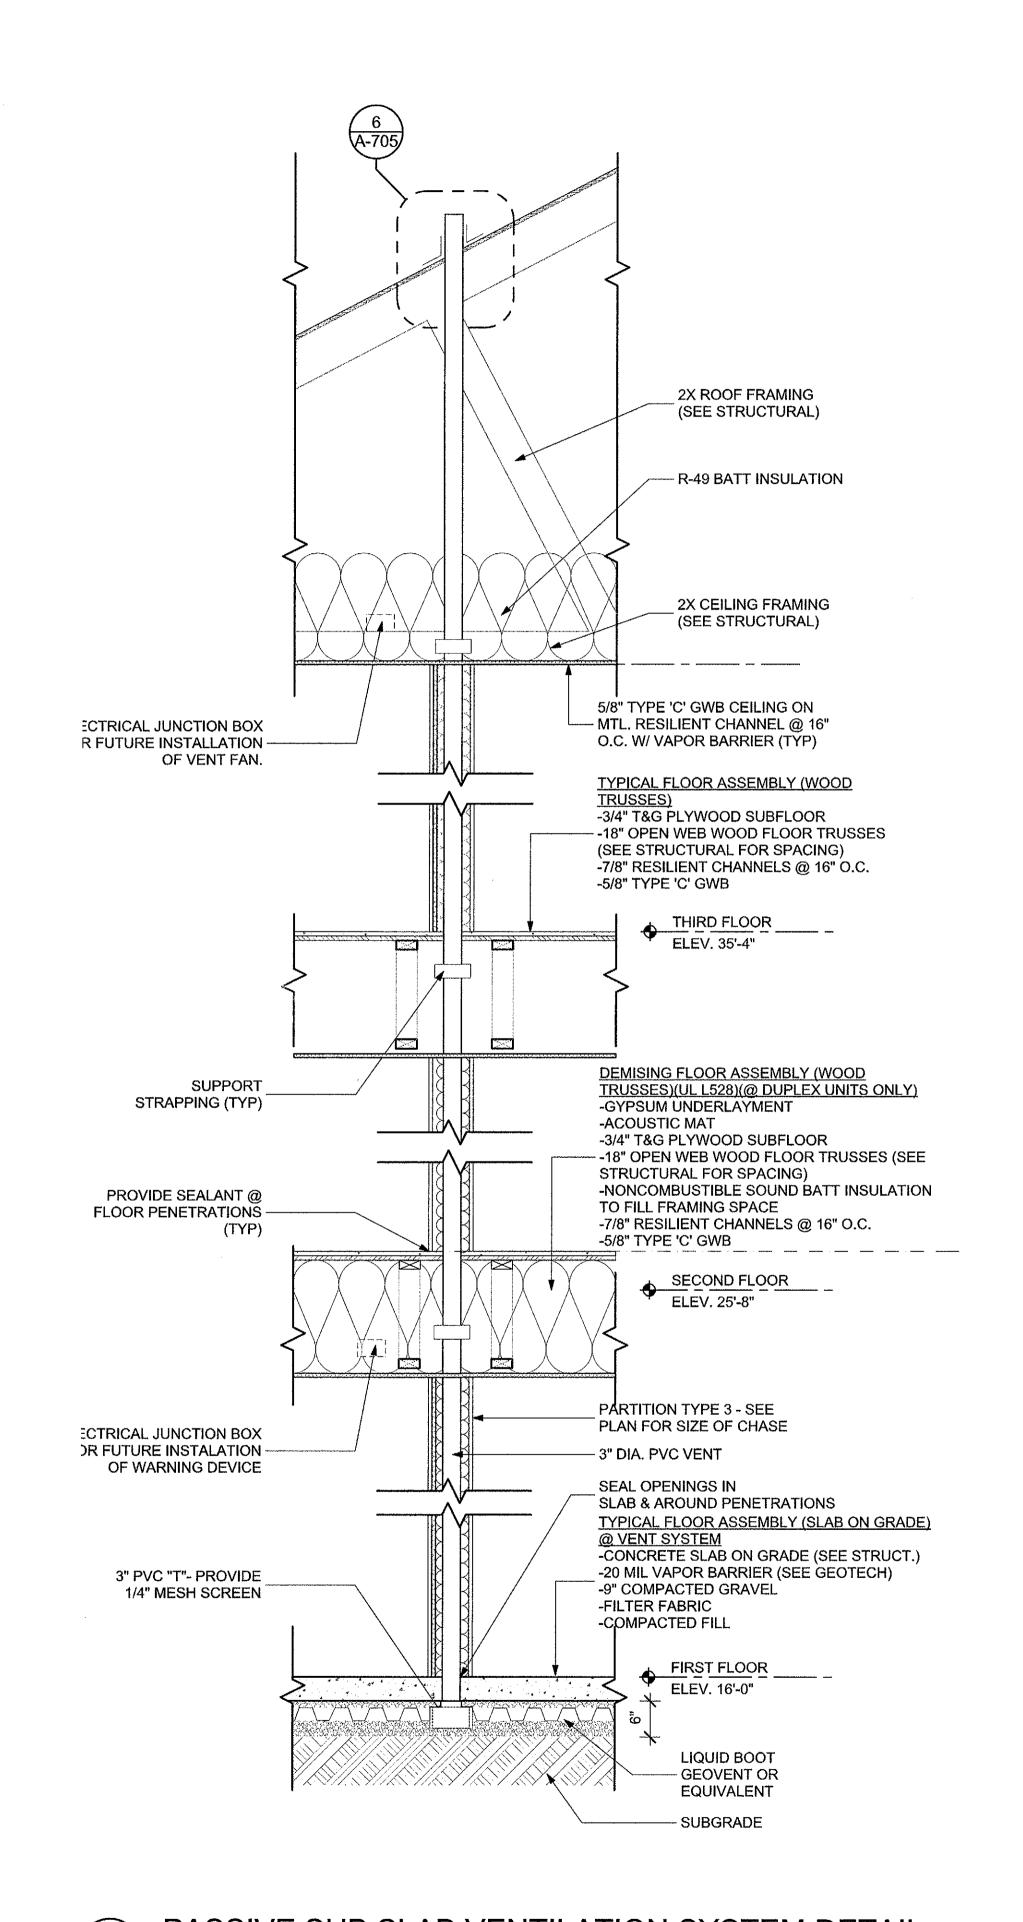

## Washington Village Master Plan

Norwalk, CT

Trinity Washington Village
Limited Partnership &
the Norwalk Housing Authority




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KEY PLAN



MARK DATE DESCRIPTION

PROJECT NO.: 21222
DRAWN BY: PG
CHECKED BY:

SHEET TITLE

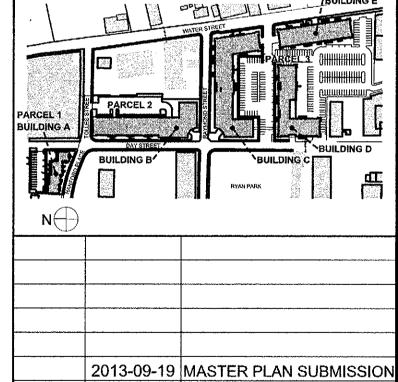WALL SECTIONS, BUILDING A

A-404

PASSIVE SUB SLAB VENTILATION SYSTEM DETAIL

SCALE: 3/4" = 1'-0"

KEY:

UNIT LOAD CENTER

## Washington Village Phase 1

## 13 Day Street Building A

Norwalk, CT

Trinity Washington Village Limited Partnership the Norwalk Housing Authority

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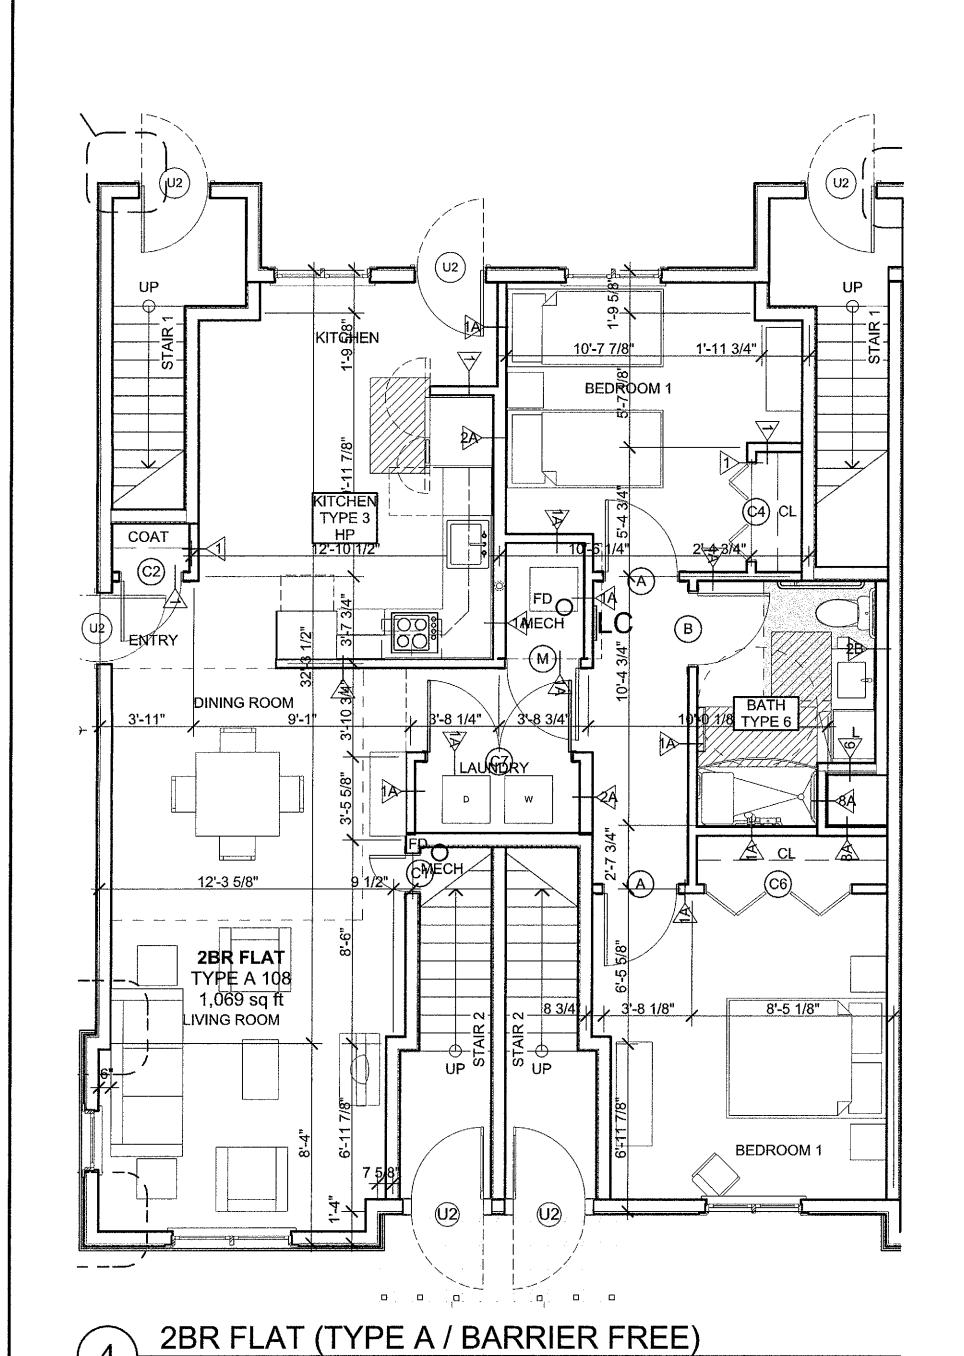
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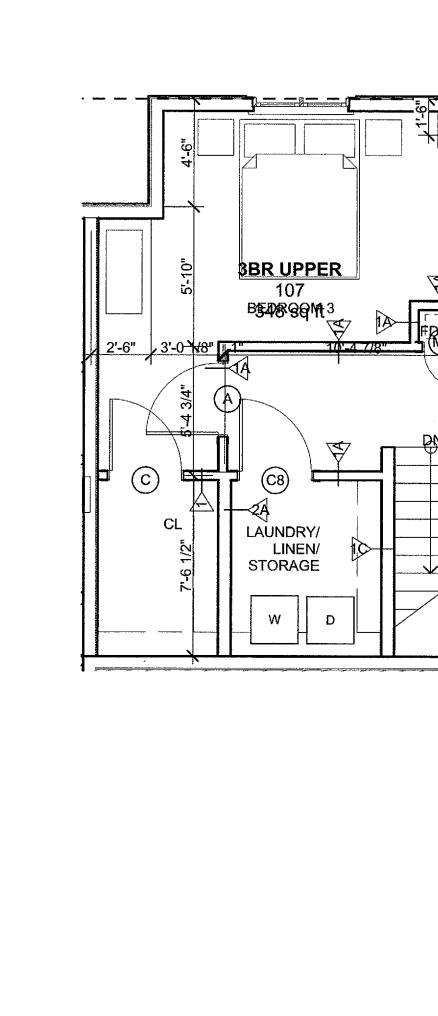
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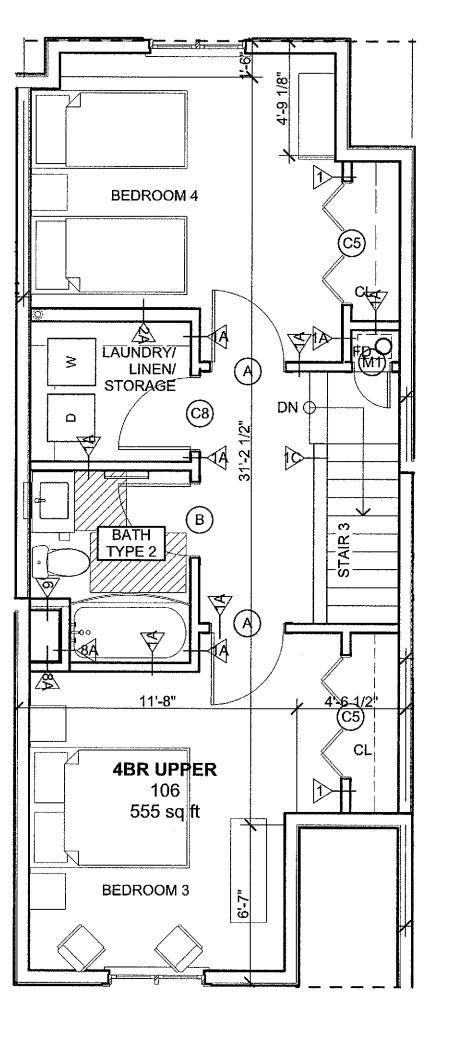
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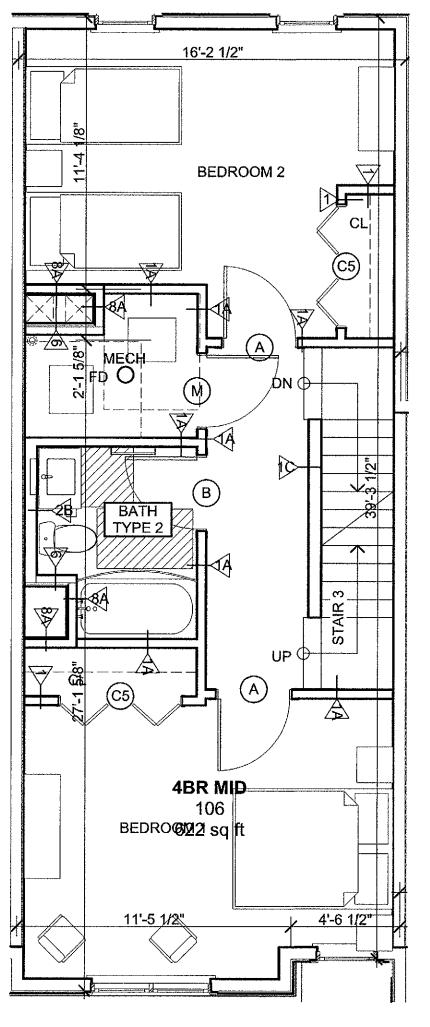
TYPICAL UNIT PLANS **BUILDING A** 


A-501










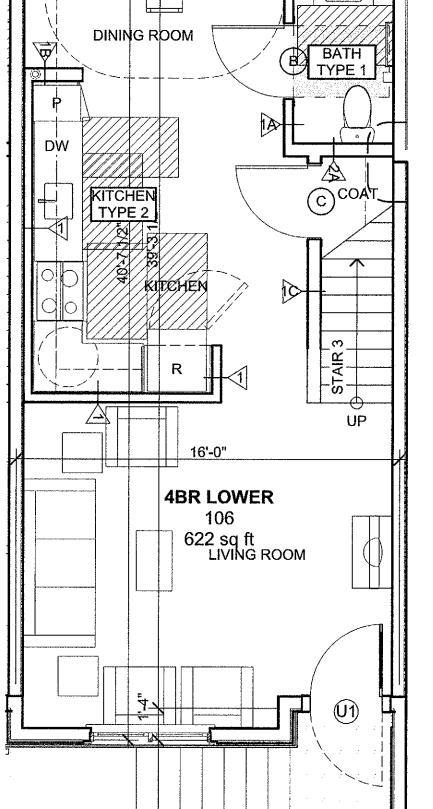

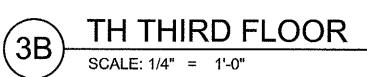

TH THIRD FLOOR

SCALE: 1/4" = 1'-0"


TH SECOND FLOOR


(THREE & FOUR BEDROOM TOWNHOUSE)

TH FIRST FLOOR


(THREE BEDROOM TOWNHOUSE TOP FLOOR) (FOUR BEDROOM TOWNHOUSE TOP FLOOR)


(THREE & FOUR BEDROOM TOWNHOUSE)

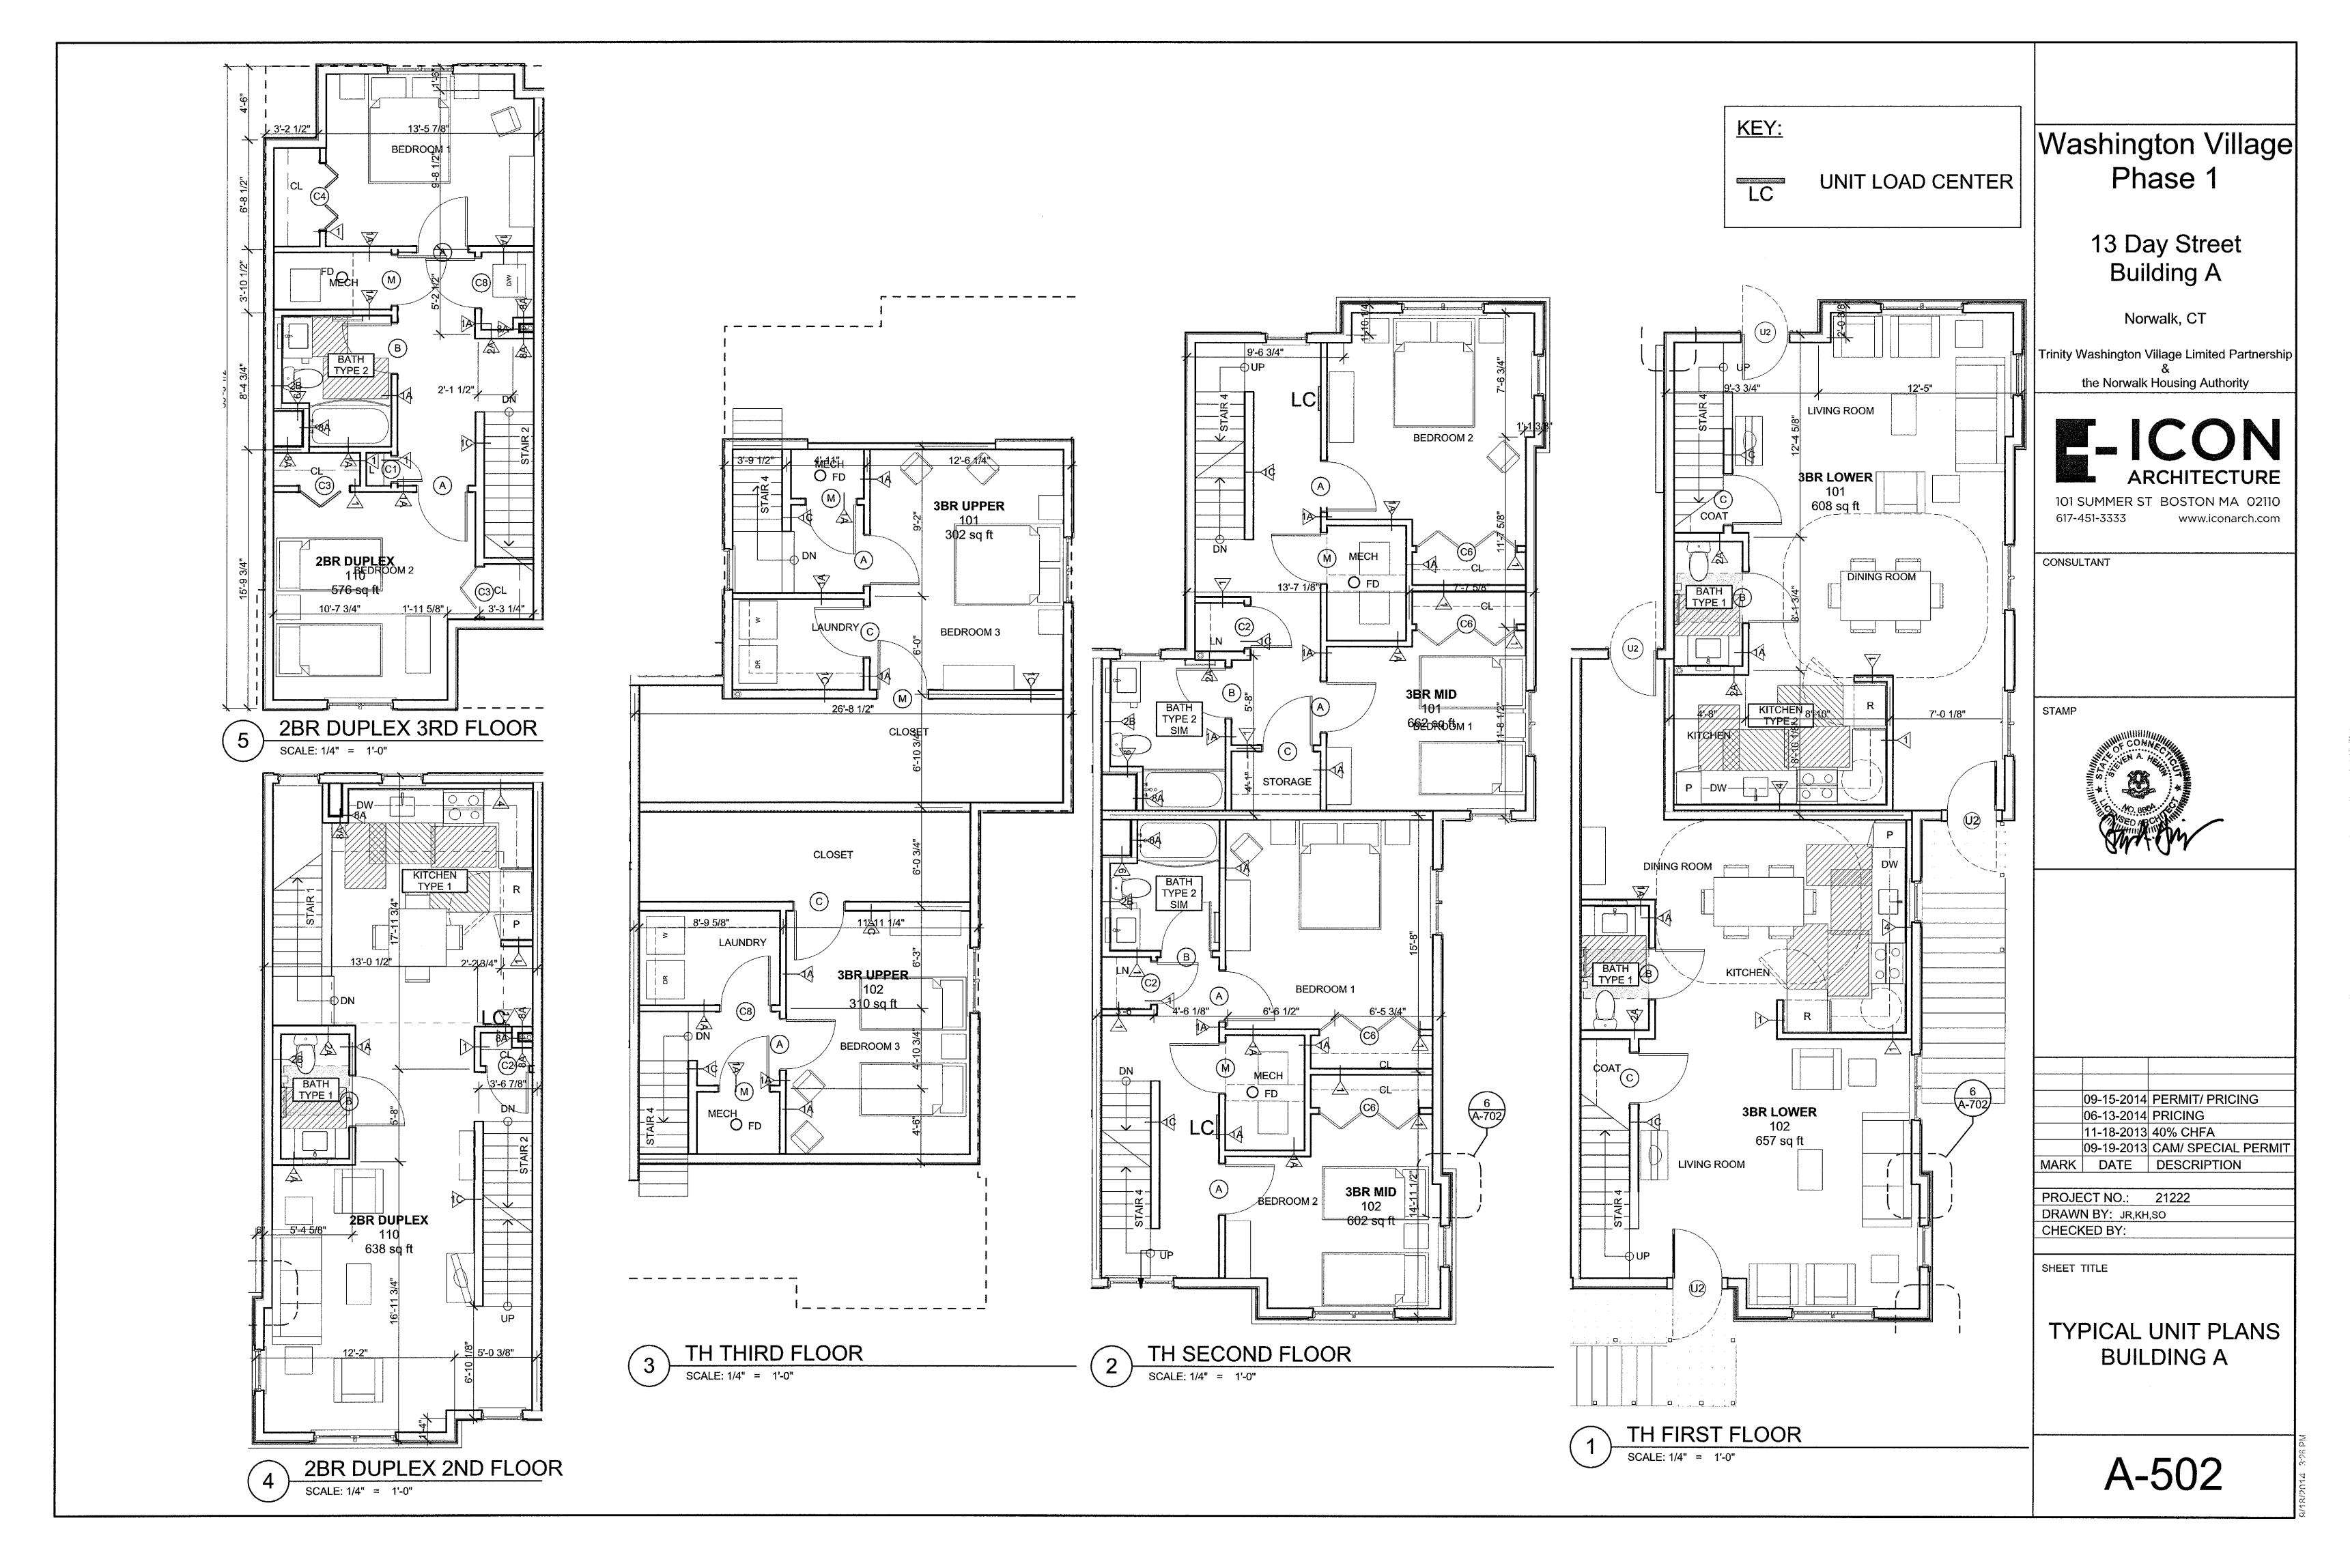


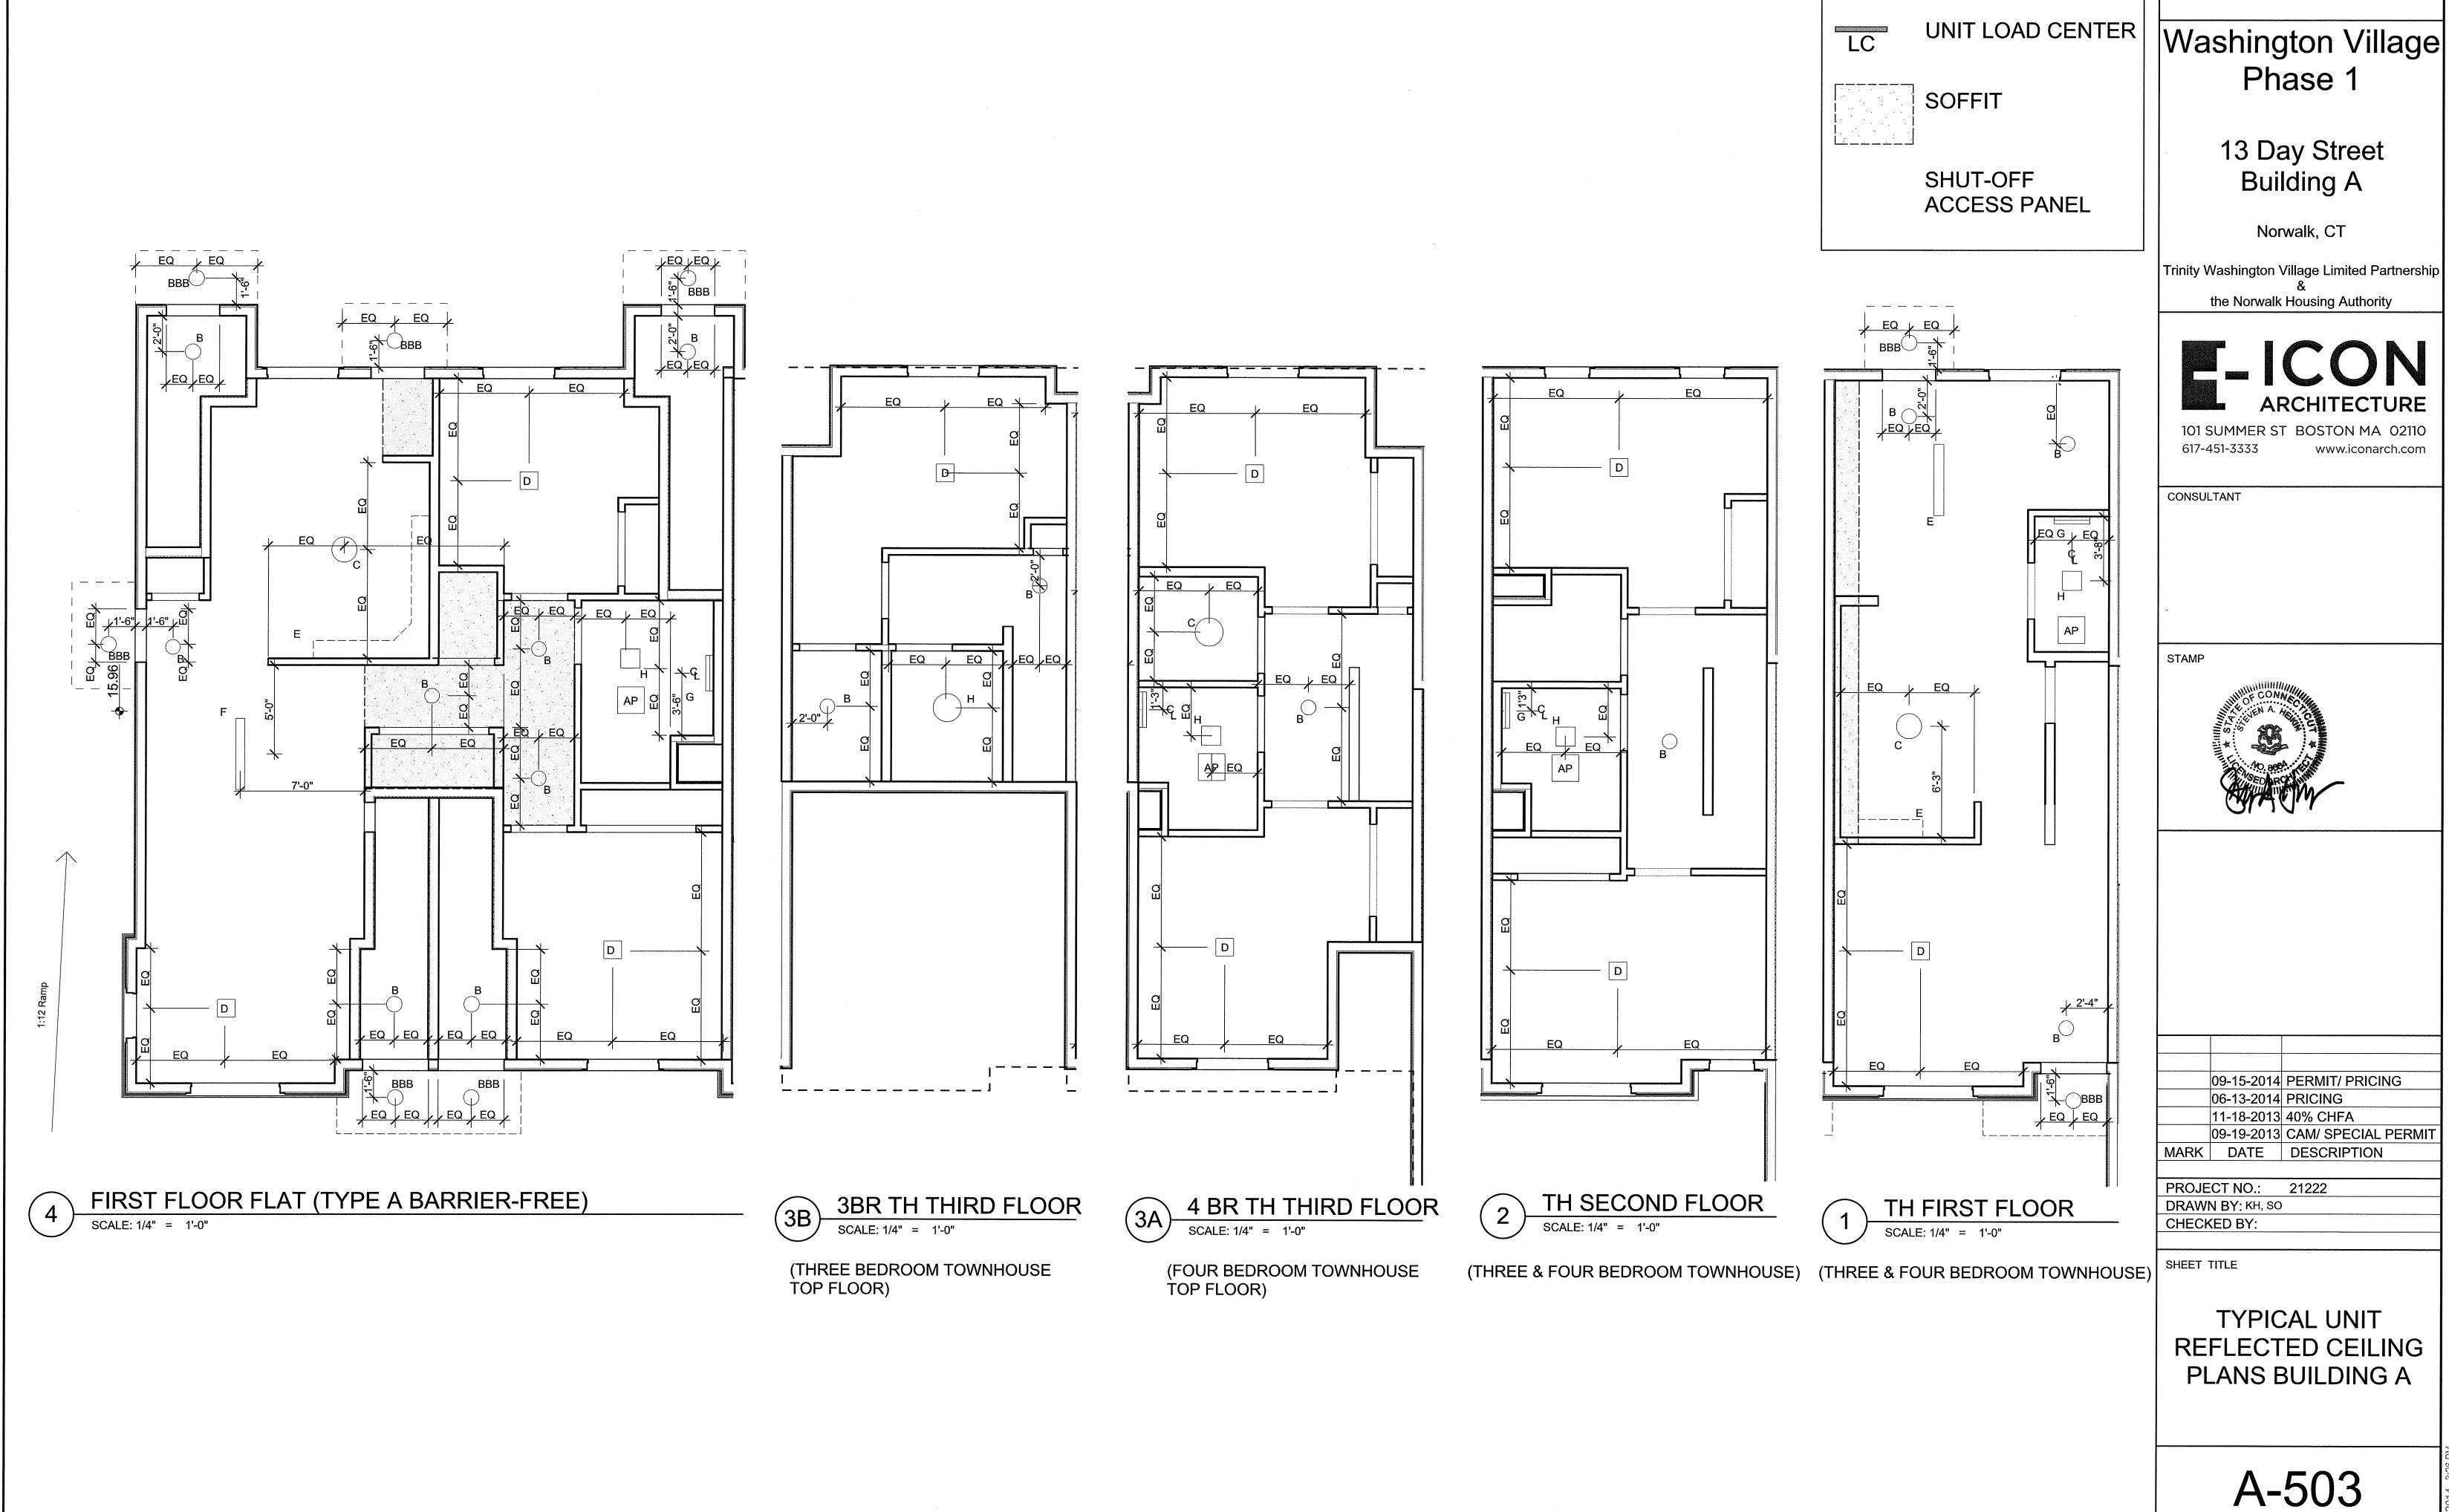


KEY:

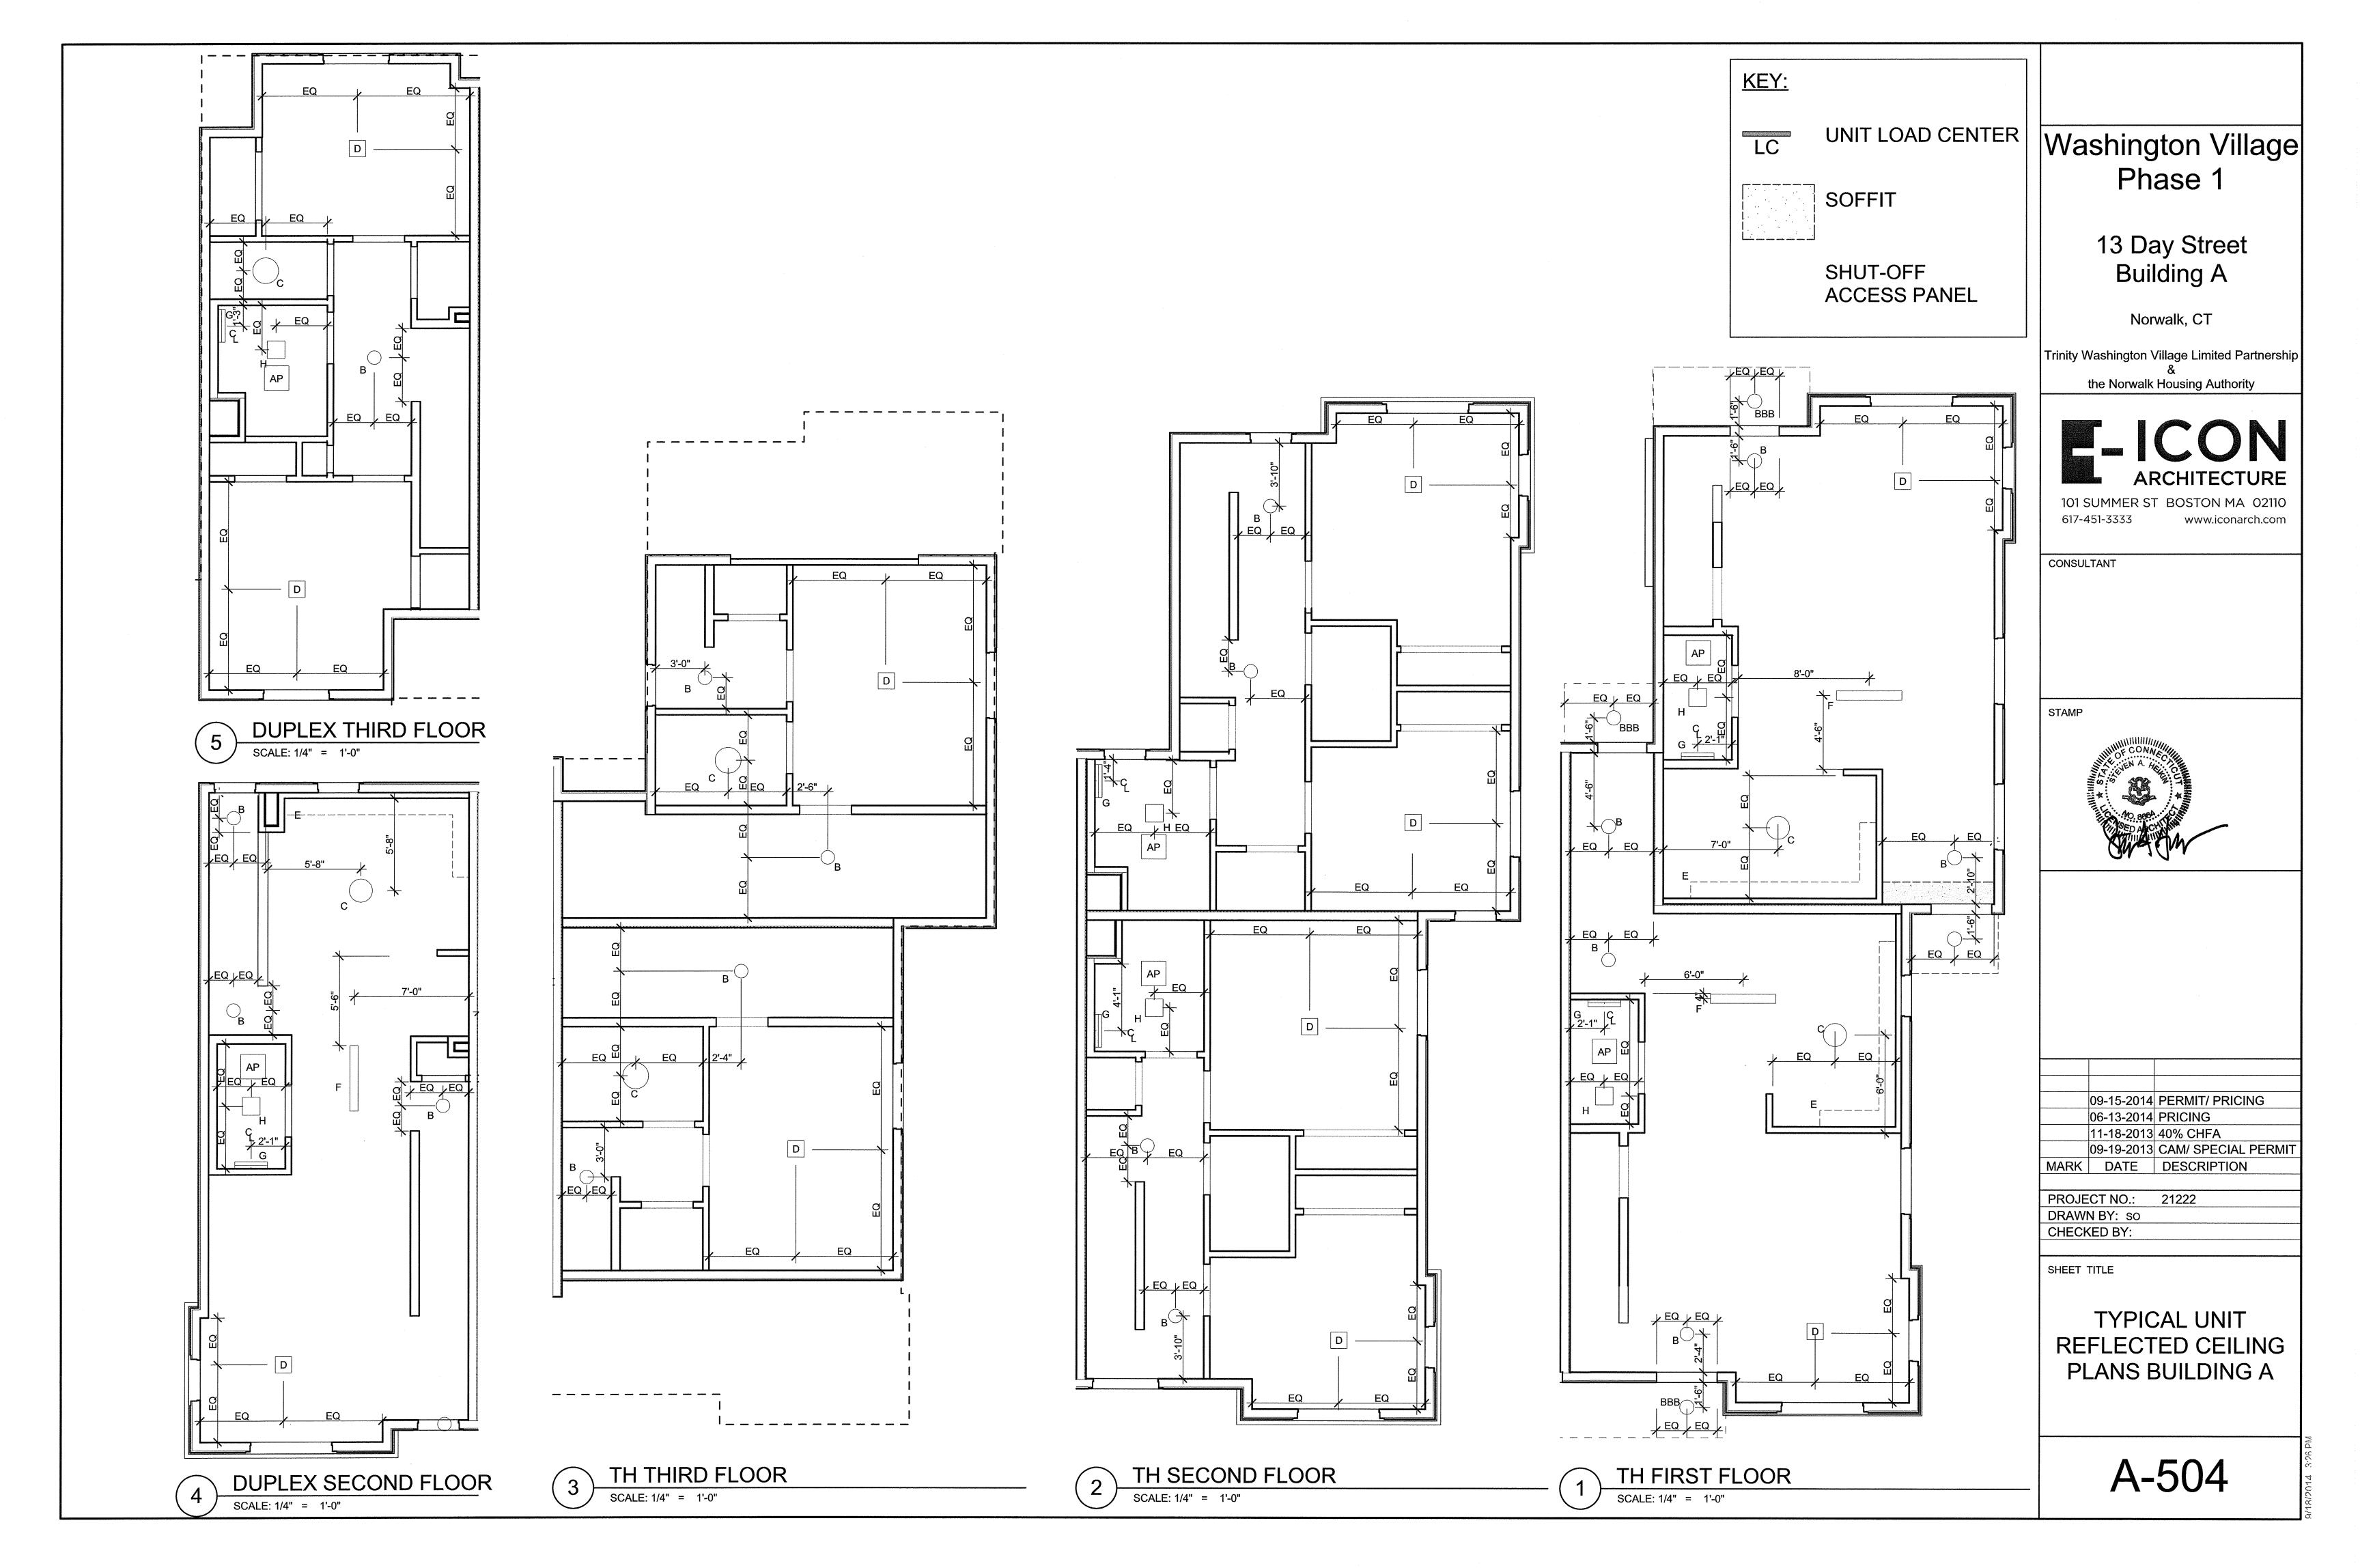

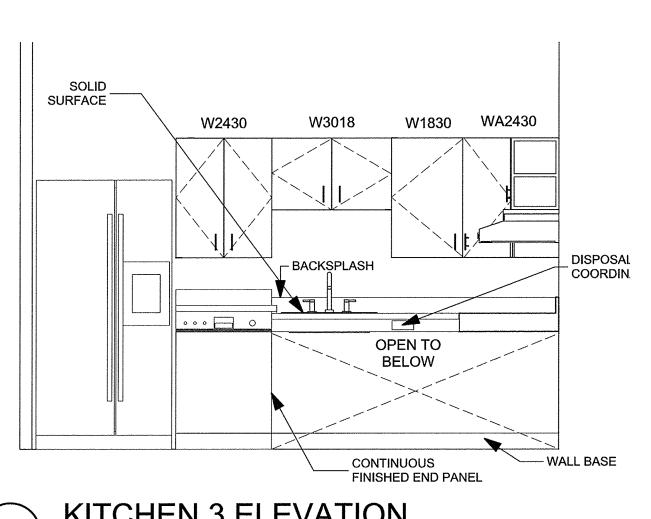

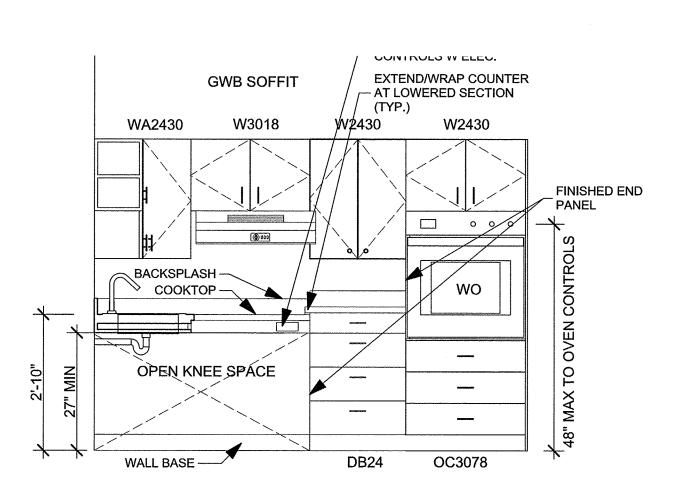

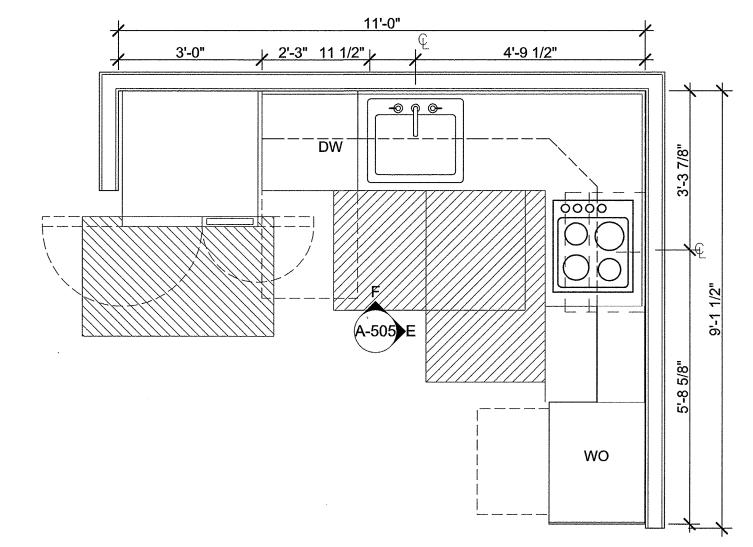



KITCHEN TYPE 3 (TYPE A BARRIER FREE) ( ANSI TYPE A)


SCALE: 1/2" = 1'-0"

KITCHEN 3 ELEVATION

**KITCHEN 3 ELEVATION** 

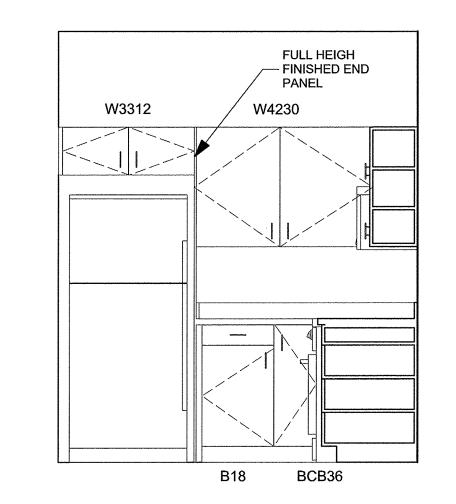

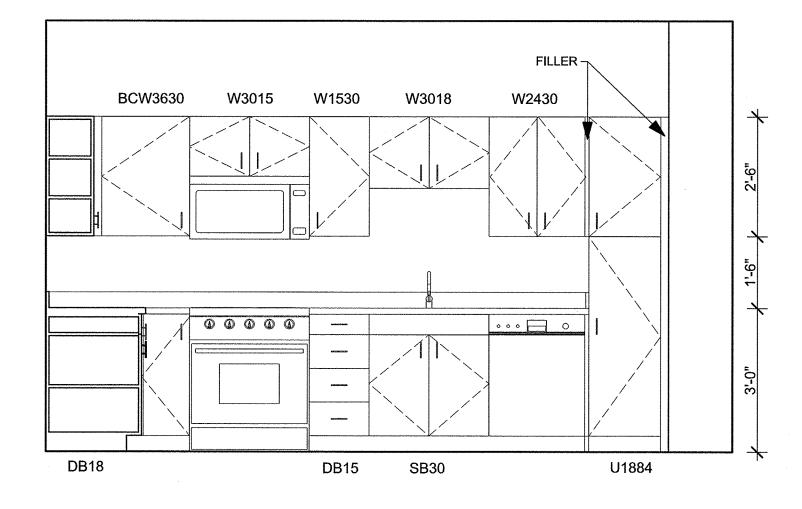


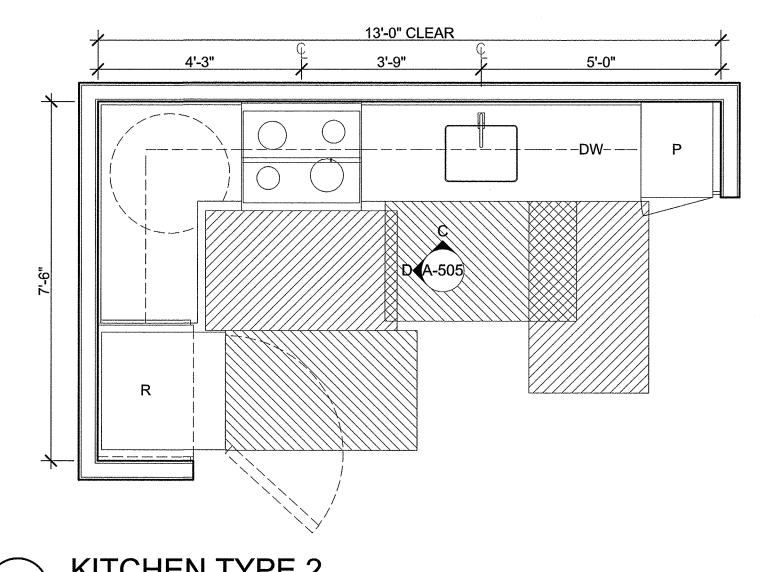


C KITCHEN 2 ELEVATION

SCALE: 1/2" = 1'-0"


SCALE: 1/2" = 1'-0"

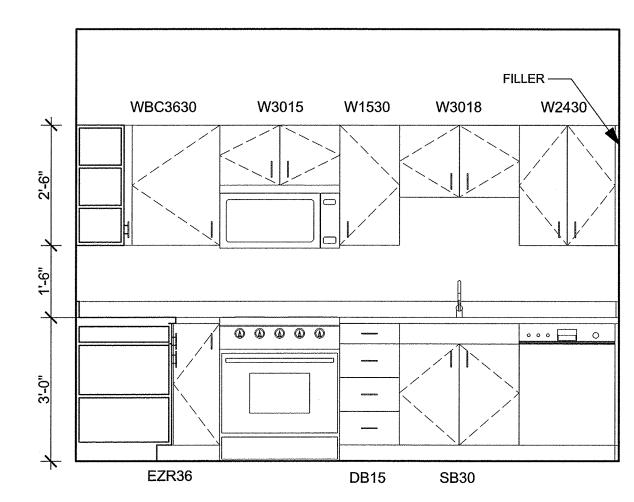



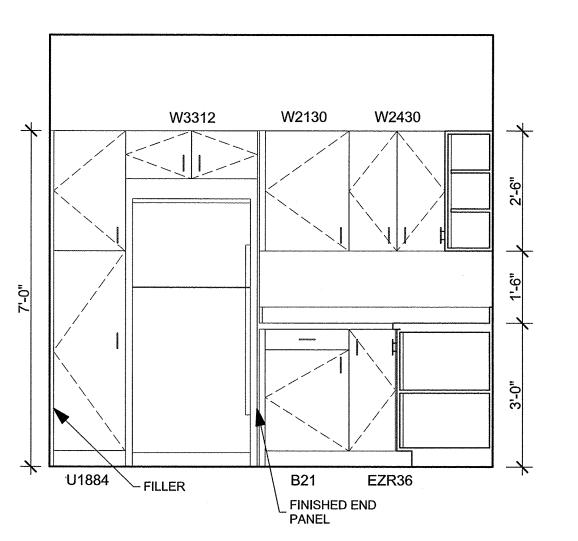

$\bigcap$	KITCHEN 1 ELEVATION	
A	SCALE: 1/2" = 1'-0"	

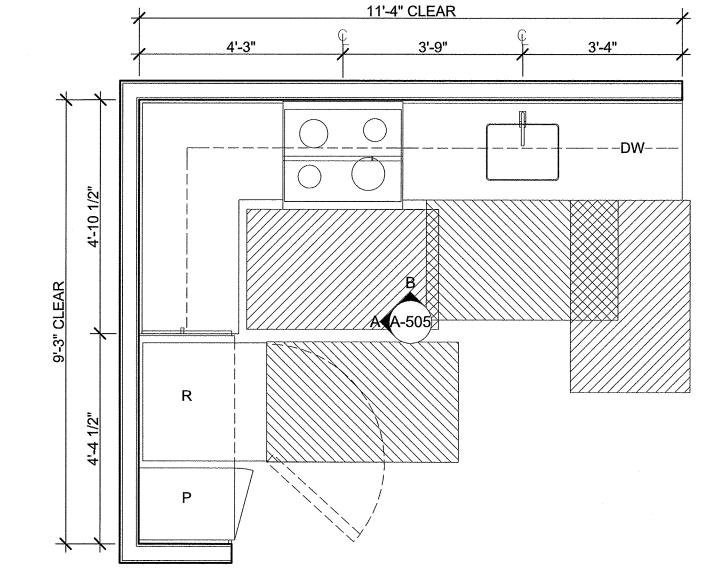

KITCHEN TYPE 1

Washington Village Phase 1

> 13 Day Street Building A

> > Norwalk, CT


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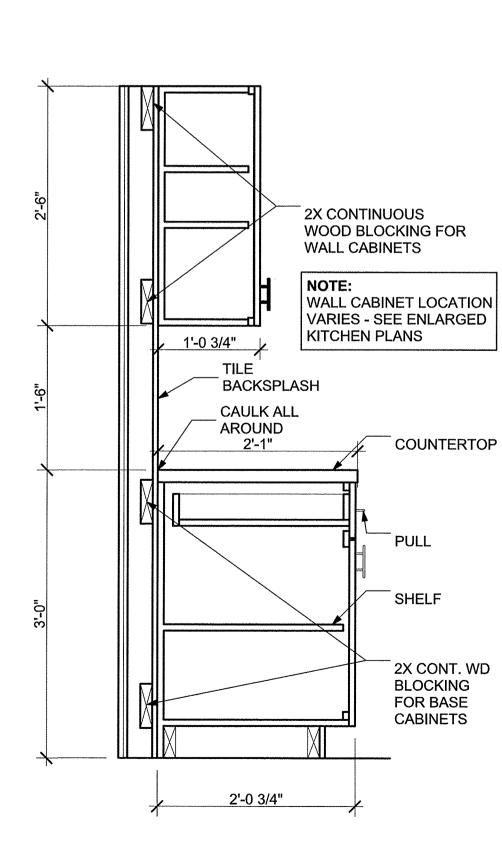
PROJECT NO.: 21222 DRAWN BY: JR/RA CHECKED BY: KH/ DW


SHEET TITLE

KITCHEN ENLARGED PLANS & ELEVATIONS

### KITCHEN GENERAL NOTES:

- 1. BLOCKING REQUIRED AT ALL UPPER WALL CABINET LOCATIONS.
- 2. ALL EXPOSED CABINETS SHALL HAVE FINISHED END PANELS.
- 3. COUNTERTOPS OVERHANG 2'-0" DEEP BASE CABINETS BY 1", TYP.
- 4. TYPICAL DIMENSIONS ARE PROVIDED FOR IDENTIFYING CABINET SIZES AND QUANTITIES PRIOR TO CONSTRUCTION. FIELD VERIFY ALL DIMENSIONS PRIOR TO ORDERING CABINETS. FIELD MEASURE ALL COUNTERTOPS PRIOR TO FABRICATION.
- 5. IF COUNTERTOP SPANS EXCEEDS 5'-0", PROVIDE INTERMEDIATE BRACKET SUPPORTS. ALL SUPPORTS SHALL BE SECURED TO 2X4 FRAME.
- 6. PROVIDE REINFORCING INSIDE BASE CABINETS IMMEDIATELY ADJACENT TO ADJUSTABLE COUNTERTOP, TYP.
- 7. EXTEND FINISH FLOORING UNDER CABINETS AND APPLIANCES.
- 8. PROVIDE TILE BASE AT GWB PARTITIONS BEHIND APPLIANCES.
- 9. PROVIDE COUNTERTOPS THROUGHOUT WITH 4" BACKSPLASH AND SIDESPLASH OF LIKE MATERIAL.
- 10. REFER TO SPECIFICATION SECTION 11452 FOR APPLIANCE SCHEDULE.
- 11. REFER TO ELECTRICAL DRAWINGS FOR DEVICE MOUNTING HEIGHTS.

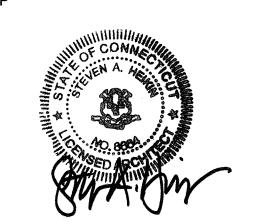

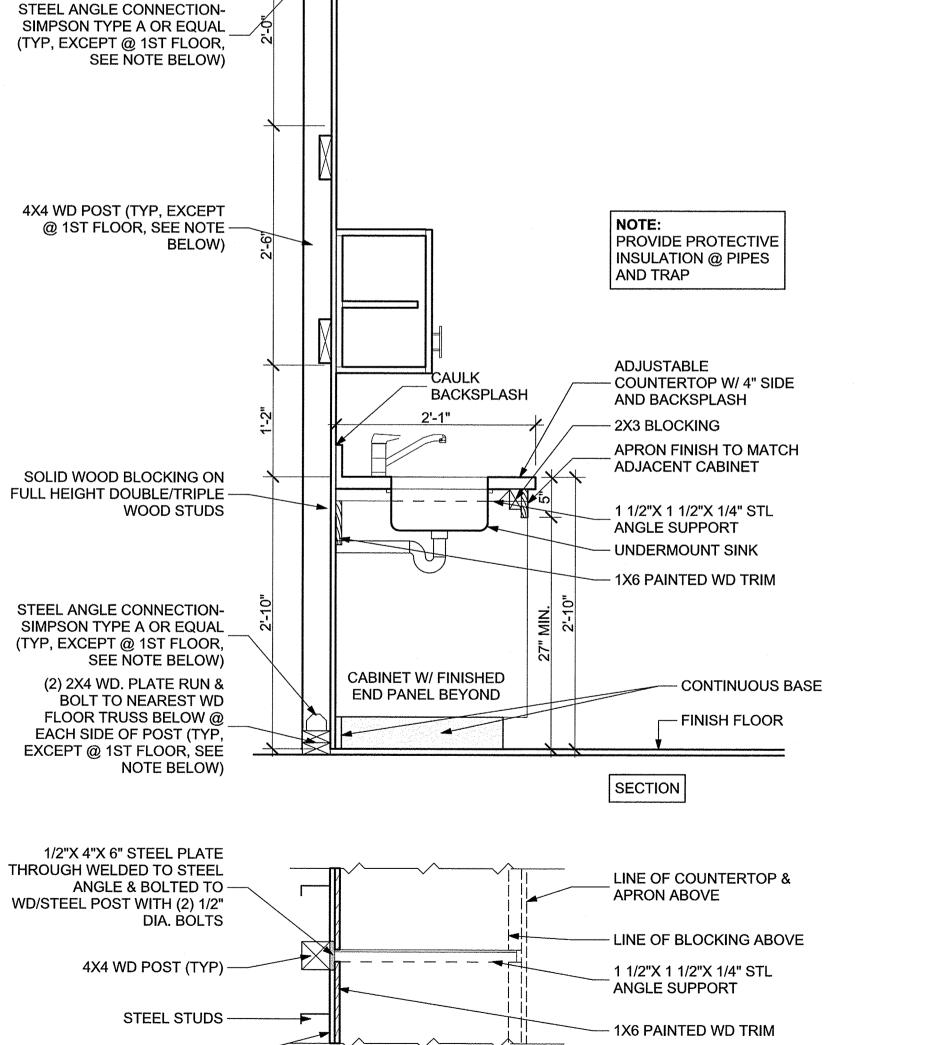

PLAN

TYPICAL DETAIL AT TYPE A KITCHEN

2X4 WD. TOP PLATE RUN &
BOLT TO NEAREST WD
FLOOR TRUSS ABOVE @
EACH SIDE OF POST (TYP,
EXCEPT @ 1ST FLOOR, SEE

NOTE BELOW)

1 TYPICAL DETAIL AT TYPE B KITCHEN

SCALE: 1" = 1'-0"

## Washington Village Phase 1

## 13 Day Street Building A

Norwalk, CT

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PROJECT NO.: 21222

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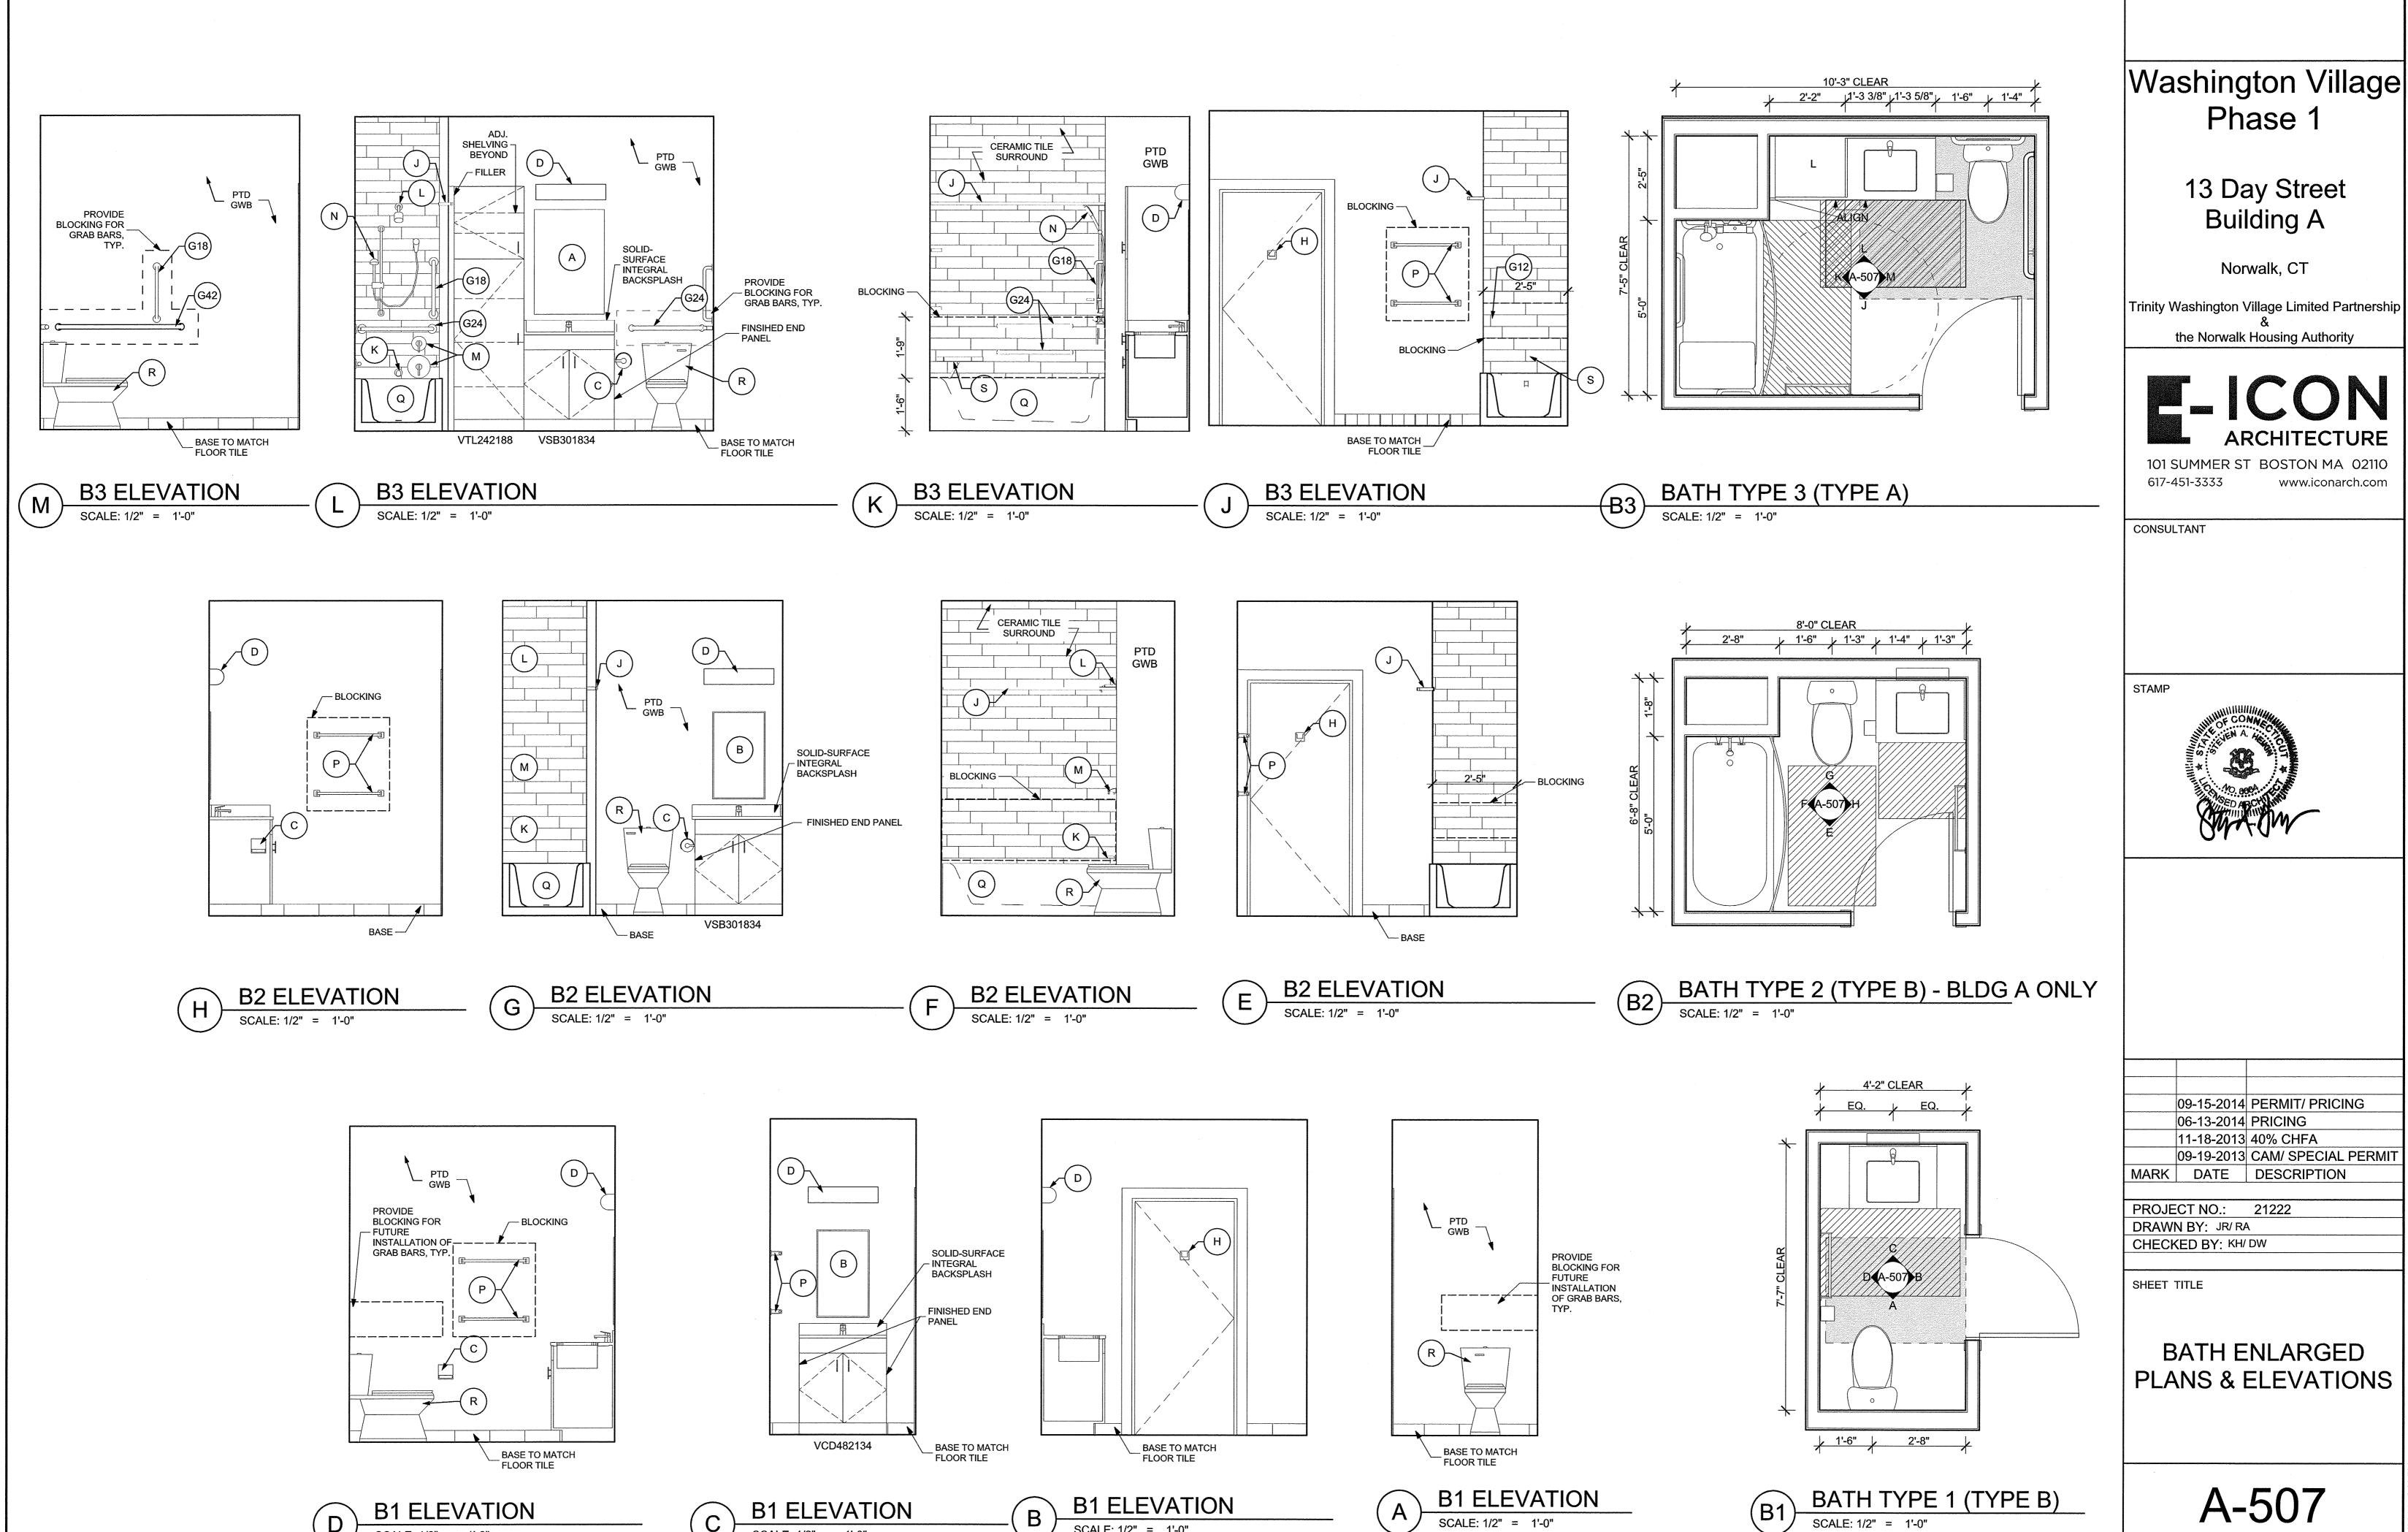
DRAWN BY: JR/RA

SHEET TITLE

KITCHEN DETAILS

A-506

N48/2014 3-26 PM



SCALE: 1/2" = 1'-0"

SCALE: 1/2" = 1'-0"

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PLANS & ELEVATIONS

## Washington Village Phase 1

# 13 Day Street Building A

Norwalk, CT


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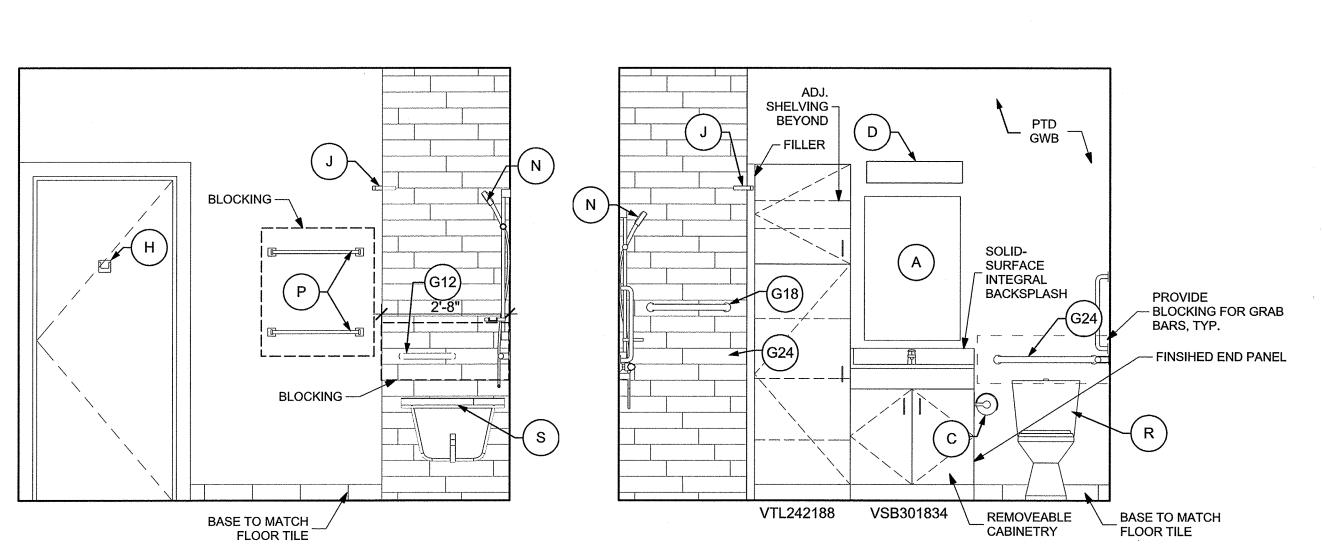



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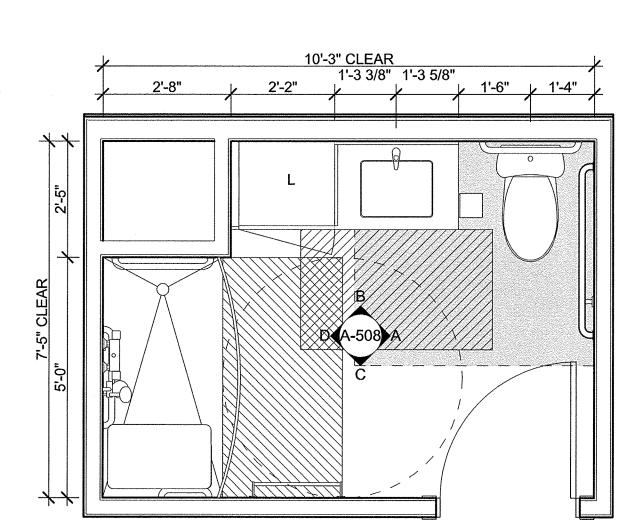
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DRAWN BY: CHECKED BY:

SHEET TITLE

BATH ENLARGED PLANS & ELEVATIONS

A-508

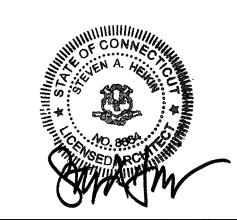**B6 ELEVATION** 

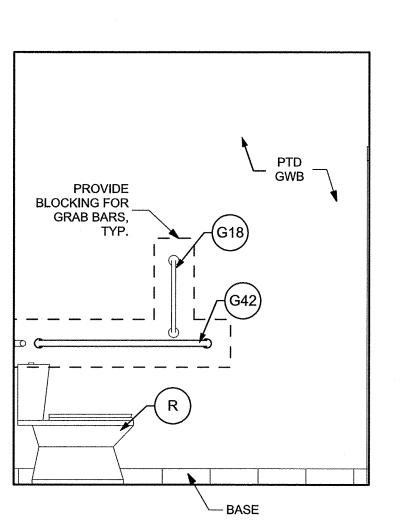**B6 ELEVATION** 

PTD GWB

B6 ELEVATION

SCALE: 1/2" = 1'-0"


B6 ELEVATION


SCALE: 1/2" = 1'-0"

BATH TYPE 6 (TYPE A)

SCALE: 1/2" = 1'-0"

BLOCKING —

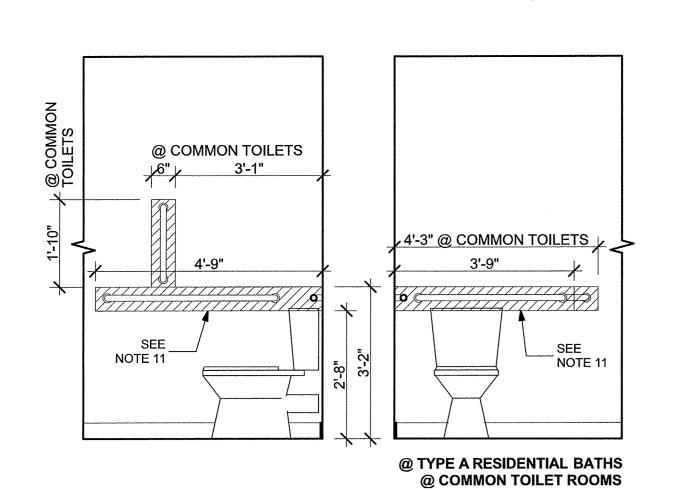

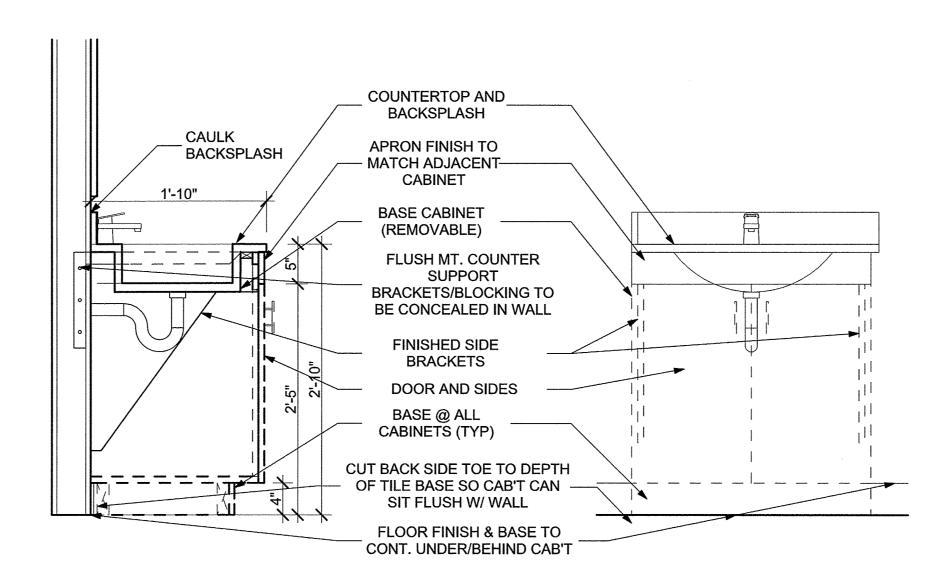

TYPICAL DETAILS AT TYPE B REMOVABLE BASE CABINET

TYPICAL DETAILS AT TYPE B VANITY

WALL REINF. LOCATIONS AT TOILET TYP. FLOOR ASSEMBLY: -3/4" GYPSUM UNDERLAYMENT -PLYWOOD/OSB SUBFLOOR 3 1/2" SOUND ATTENUNATING -3 1/2" F.G. BATTS. BATT INSULATION -RESILIENT CHANNELS @ 12" O.C. -1 LAYER OF 5/8" GWB @ CEILING AND SIDES OF FAN RECESS - 1X2 WOOD STRAPPING ASSEMBLY 1 HR FIRE RATED - FLEXIBLE SEALANT OR TAPE UL# L-558 (2) 4X4 WD POST (TYP) -OPEN WEB COUNTERTOP AND CAULK (1) LAYER 5/8" TYPE WOOD TRUSS /WOOD TRUSS BACKSPLASH **BACKSPLASH** "C" GWB BEYOND APRON FINISH TO - MATCH ADJACENT 1'-10" CABINET 1/2" STEEL PLATE THROUGH VENT DAMPER EXHAUST WELDED TO STEEL SUPPORT FAN & BOLTED TO WD/STEEL POST WITH (2) 1/2" DIA. **BOLTS, EACH POST** 3 1/2" SOUND ATTENUNATING FLUSH MT. COUNTER - 2X4 BLOCKING FIRE DAMPER -SUPPORT BRACKETS BATT INSULATION TO BE CONCEALED IN FLEXIBLE SEALANT OR TAPE --(1) LAYER 5/8" TYPE "X" GWB - WT 2.5X8 SUPPORT WALL - FLEXIBLE SEALANT OR TAPE **1X2 WOOD STRAPPING** RECESSED DOWN LIGHT STEEL ANGLE CONNECTION-WHERE SHOWN SIMPSON TYPE A OR EQUAL -- BASE AS SCHEDULED (TYP) DETAIL AT FAN - TOP OF FINISH FLOOR 2X4 WD STUDS, RUN SECTION FROM FLOOR SLAB BELOW TO FLOOR FRAMING ABOVE 2X2 STL ANGLE SUPPORT BELOW W/ 4" LAG SCREW AT EACH STUD (3 MIN PER ANGLE-PROVIDE BLOCKING AS REQUIRED) 2X4 BLOCKING, TOE 1/2" STEEL PLATE THROUGH NAIL TO 2X4 STUDS WELDED TO STEEL SUPPORT & BOLTED TO WD/STEEL -APRON FINISH TO POST WITH (2) 1/2" DIA. - MATCH ADJACENT **BOLTS, EACH POST** CABINET - WT 2.5X8 SUPPORT (2) 4X4 WD POST (TYP) — 2X4 BLOCKING, TOE 1X10 BLOCKING NAIL TO 1X10 BLOCKING PLAN VIEW

KEY AND MOUNTING HEIGHT SCHEDULE ANSI 117.1 (TYPE B) ANSI 117.1 (TYPE A) MANUFACTURER MODEL# KEY FIXTURE / ACCESSORY BOTTOM OF REFLECTING SURFACE @ 40" AFF A MIRROR (2'-0") TOP @ 48" MAX A.F.F. BOTTOM @ 15" MIN A.F.F. BOTTOM @ 42" MAX. A.F.F. B MEDICINE CABINET CL OF DISPENSER @ 14" - 19" A.F.F. C TOILET PAPER DISPENSER CL OF DISPENSER @ 7" - 9" BEYOND FRONT OF TOILET CL @ 80" AFF REFER TO LIGHT FIXTURE SCHEDULE D LIGHT FIXTURE CL @ 82" AFF HAND-HELD SHOWER SYSTEM w/ BOTTOM OF MOUNTING BAR @ 40" REFER TO PLUMBING FIXTURE SCHEDULE 60" HOSE ATTACHED TO 36" ADJUSTABLE MOUNTING BAR AND MIXING VALVE GRAB BAR (12") HORIZONTAL GRAB BAR (24") HORIZONTAL WHERE TWO GRAB BARS ARE PROVIDED GRAB BAR (36") HORIZONTAL THE SECOND SHALL BE 9" ABOVE RIM OF BATHTUB TO TOP GRAB BAR (42") HORIZONTAL GRAB BAR (48") HORIZONTAL CL @ 4'-0" A.F.F. GRAB BAR (18") VERTICAL TOP @ 36" MAX A.F.F GRAB BAR SWING-UP TOP @ 60" A.F.F TOP @ 48" A.F.F. DOUBLE ROBE HOOK CL @ 78" A.F.F. SHOWER ROD (60") CL @ 23" A.F.F. K TUB SPOUT SHOWER HEAD CL @ 78" A.F.F. | 畳 | CL @ 40" A.F.F. OF TUB M MIXING VALVE CL @ 38-48" A.F.F. OF SHOWER, CENTER CL @ 38-48" A.F.F. OF SHOWER ON LONG WALL HAND-HELD SHOWER ON BOTTOM OF TRACK @ 40" ABOVE BATHTUB/SHOWER FLOOR REFER TO PLUM. DWGS. ADJUSTABLE TRACK (59" LONG HOSE) P TOWEL BAR (24") CL @ 42" & 62" A.F.F. CL @ 36" & 56" A.F.F RIM @ 16"-18" A.F.F. Q BATHTUB R TOILET TOP OF SEAT @ 17" A.F.F. TOP @ 17"-19" A.F.F. S SHOWER SEAT CL OF ROLL @ 24" A.F.F.; SIDE WALL MULTI-ROLL T.P. DISPENSER CLOSEST TO TOILET PAPER TOWEL DISPENSER CL OF TOWEL SLOT @ 42" MAX AFF

## 13 Day Street **Building A**

Washington Village

Phase 1


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## **BATH GENERAL NOTES:**

1) SEE ACCESSORY KEY & MOUNTING HEIGHT SCHEDULE FOR ALL MOUNTING HEIGHTS

2) WALL REINFORCEMENT REQUIRED AT ALL ACCESSORY LOCATIONS.

3) WALL BOARD TO EXTEND TO FLOOR BELOW BATHTUB FOR CONTINUITY OF FIRE/SMOKE RATING

4) DOOR LOCATION(S) MAY VARY, REFER TI UNIT PLANS.

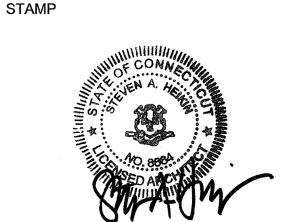5) REFER TO SKETCH FOR TILE TERMINATION.

6) PROVIDE CERAMIC TILE ON CEM.BD. @TUB ENCLOSURE. SEE SPECIFICATIONS FOR TILE TERMINATION.

7) UNLESS OTHERWISE NOTED, PROVIDE PAINTED MOISTURE-RESISTANT GWB @ BATHROOM WALLS, CEILINGS, WET CHASES, TYP.

8) ALL FINISHES (CT, FLOORING, BASE, PAINT) TO CONTINUE UNDER AND BEHIND CABINET.

### BATH ACCESSORY NOTES:

9) REFER TO PLUMBING DRAWINGS AND SPECIFICATIONS FOR FIXTURE MANUFACTURERS AND MODEL NUMBERS, VERIFY ROUGH-IN REQUIREMENTS FOR TUB AND PLUMBING SYSTEMS FROM APPROVED MANUFACTURER OF FIXTURES PRIOR TO PARTITON FRAMING INSTALLATION.

10) GRAB BARS TO BE INSTALLED AT TYPE 'A' UNITS IN BUILDINGS

11) 42.5.3:

BLOCKING TO BE PROVIDED WHERE SPECIFIED IN FLOOR PLANS/ROOM ELEVATIONS: "WALLS ADJACENT TO AND BEHIND THE WATER CLOSET SHALL BE CAPABLE OF STRUCTURALLY SUPPORTING THE FUTURE INSTALLATION OF GRAB BARS FROM 32" TO 38" ABOVE THE FLOOR. THE BACK WALL SHALL HAVE REINFORCEMENT FROM THE INTERIOR CORNER TO A DISTANCE OF 6" BEYOND THE WIDEST PART OF THE WATER CLOSET. THE SIDE WALL SHALL HAVE REINFORCEMENT FROM THE INTERIOR CORNER TO A DISTANCE OF 6" BEYOND THE FRONT EDGE OF THE WATER CLOSET, UNLESS INTERRUPTED BY A DOOR OR OTHER FIXTURE, THEN THE REINFORCEMENT SHALL BE INSTALLED AS FAR AS POSSIBLE."

"ALL TUB WALLS SHALL BE CAPABLE OF STRUCTURALLY SUPPORTING THE FUTURE INSTALLATION OF GRAB BARS FROM 6" ABOVE THE TUB RIM TO A HEIGHT OF 48" ABOVE THE TUB BOTTOM AND SHALL EXTEND THE LENGTH AND WIDTH OF THE TUB."

"ALL SHOWER WALLS SHALL BE CAPABLE OF STRUCTURALLY SUPPORTING THE FUTURE INSTALLATION OF GRAB BARS, SEATS, ETC., FROM A HEIGHT OF 6" TO 48" ABOVE THE FLOOR AND SHALL EXTEND THE FULL WIDTH AND LENGTH OF THE SHOWER STALL, GRAB BARS SHALL NOT BE LOCATED BEHIND THE SEAT."

14) 44.6.1.c

"ALL WALLS OF THE TUB SHALL HAVE STRUCTURAL REINFORCEMENT TO ALLOW THE FUTURE INSTALLATION OF GRAB BARS AT ANY LOCATION FROM THE RIM OF THE TUB TO A HEIGHT OF 60" ABOVE THE TUB BOTTOM."

15) 44.6.2.b

"ALL WALLS OF THE SHOWER SHALL HAVE STRUCTURAL REINFORCEMENT TO ALLOW THE FUTURE INSTALLATION OF A SEAT AND GRAB BARS, AT ANY LOCATION FROM THE FLOOR TO A HEIGHT OF 60" ABOVE THE FLOOR."

"FAUCETS AND MIXING VALVES SHALL BE CENTERED HORIZONTALLY ON THE LONG WALL OF THE SHOWER, 28 INCHES ABOVE THE FLOOR." TUB FAUCETS AND MIXING VALVES SEE A510. DETAIL. 5.


09-15-2014 PERMIT/ PRICING 06-13-2014 PRICING 11-18-2013 40% CHFA


09-19-2013 CAM/ SPECIAL PERMIT MARK DATE DESCRIPTION

PROJECT NO.: 21222 DRAWN BY: JR/ RA/ PG CHECKED BY: KH/ DW

SHEET TITLE

**BATH DETAILS** 

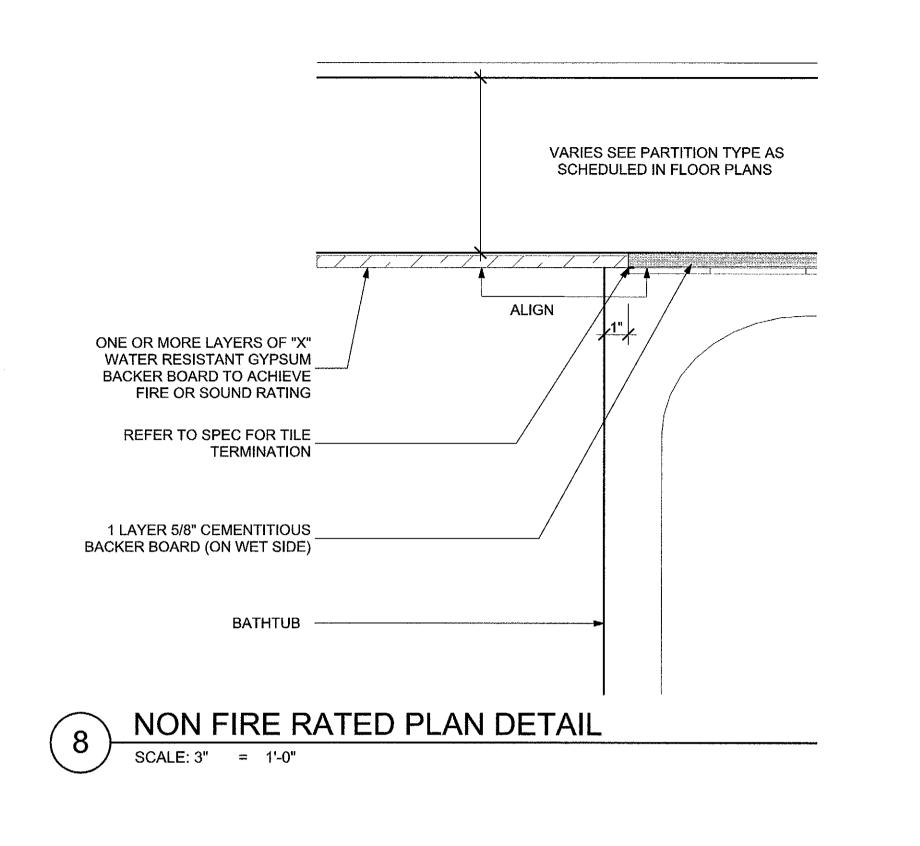

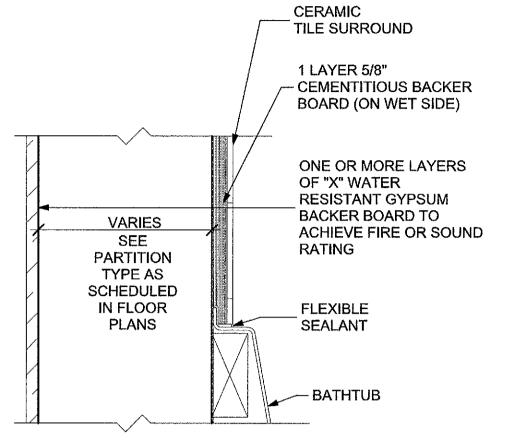




**FULL WIDTH** 


OF SHOWER

FULL WIDTH OF SHOWER

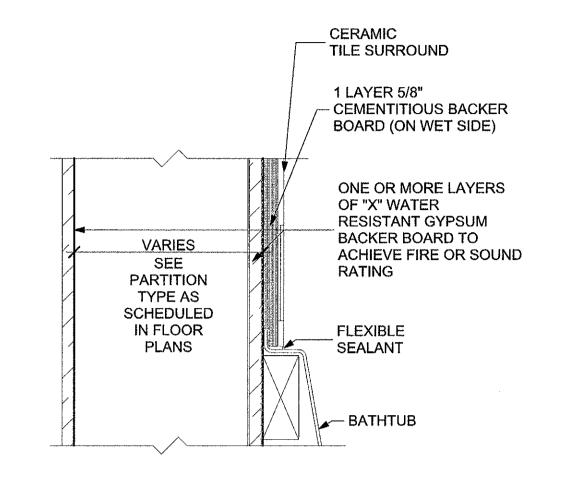

FIRE RATED BATH DETAIL

FULL WIDTH OF TUB

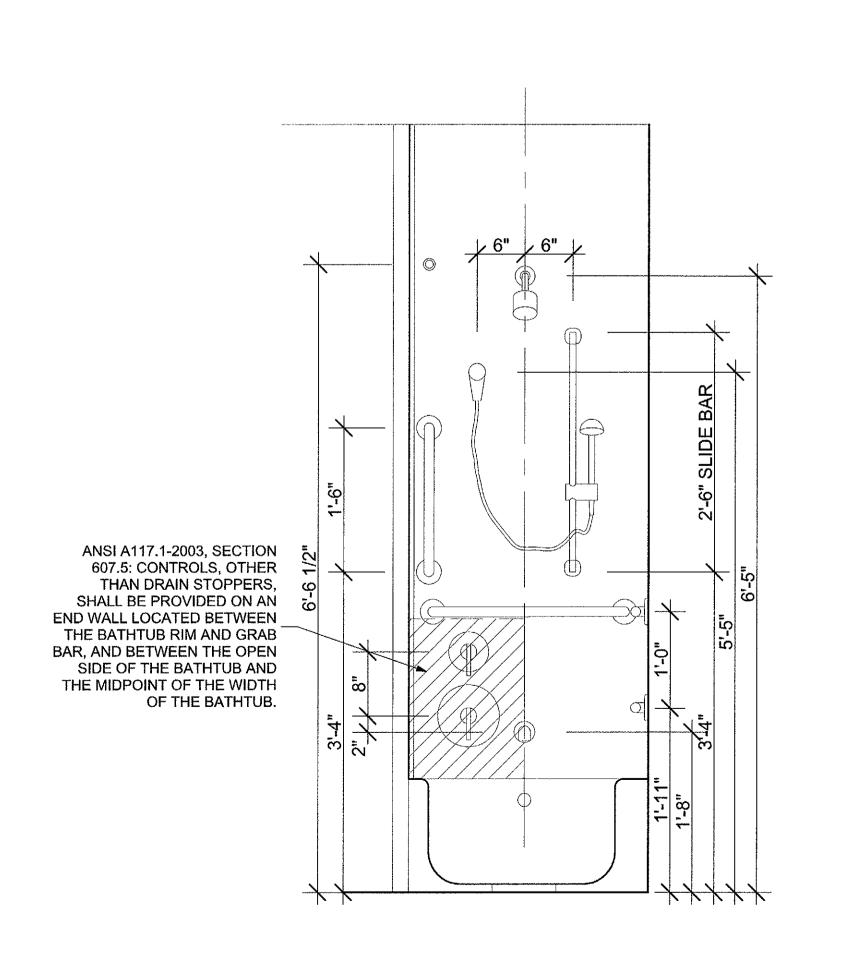

TUB MOUNTING HEIGHTS

SCALE: 1" = 1'-0"

FULL WIDTH OF SHR FULL WIDTH OF SHR \_ SEE NOTE 8 \_ SEE NOTE 8

4 WALL REINF. AT SHOWER (TYPE A)


SCALE: 1/2" = 1'-0"


WALL REINF. AT SHOWER (TYPE B)

SCALE: 1/2" = 1'-0"

**FULL WIDTH** 


OF SHOWER

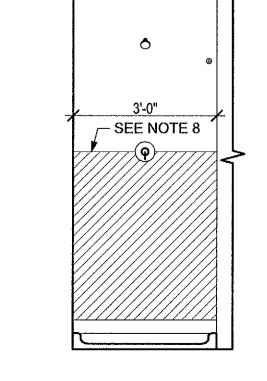

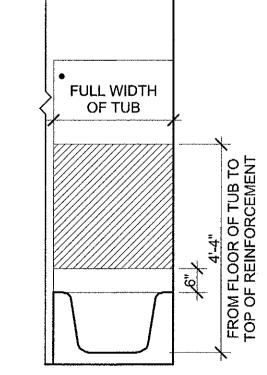

FULL WIDTH

OF TUB

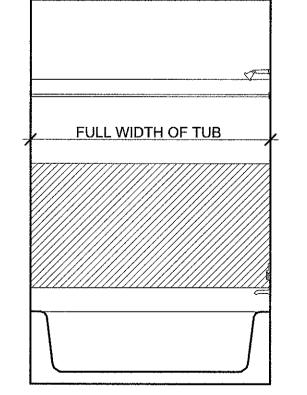

WALL REINF. AT TUB (TYPE B)

SCALE: 1/2" = 1'-0"

WALL REINF. AT TUB (TYPE A)

SCALE: 1/2" = 1'-0"

## Washington Village Phase 1

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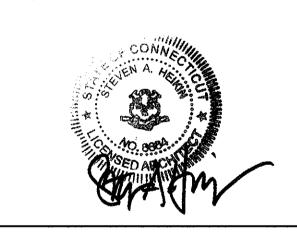
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STAMP

FULL WIDTH OF TUB

FULL WIDTH

OF TUB




	09-15-2014	PERMIT/ PRICING
	06-13-2014	PRICING
	11-18-2013	40% CHFA
	09-19-2013	CAM/ SPECIAL PERMI
MARK	DATE	DESCRIPTION


PROJECT NO.: 21222 DRAWN BY: PG CHECKED BY:

SHEET TITLE

BATH DETAILS

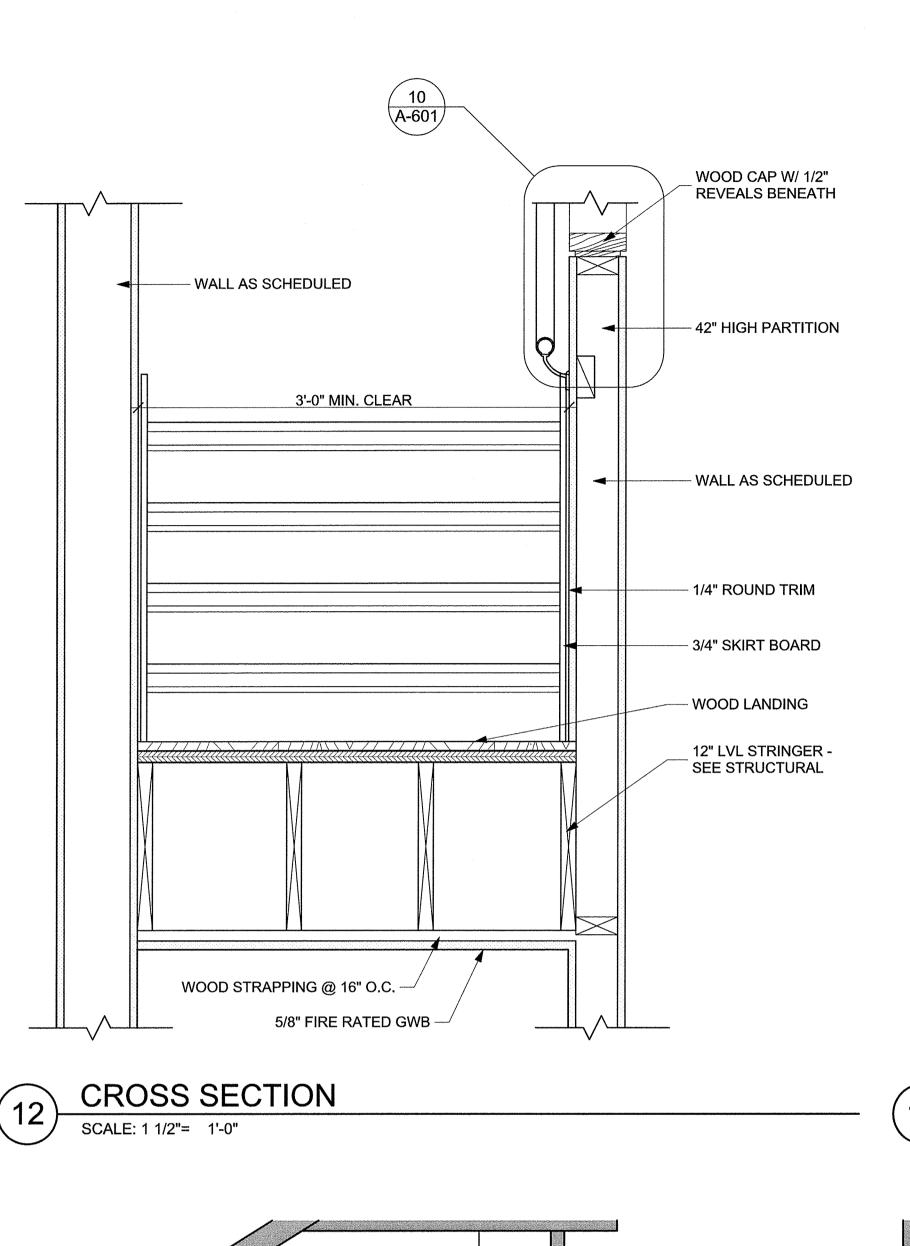

BLOCK AS REQ'D WALL RAIL BRACKET 1/4" ROUND TRIM FRAMING ANCHOR, (2) PER STRINGER (TYP) - 3/4" SKIRT BOARD - WOOD TREAD 5/8" TYPE "X" G.W.B. 12" LVL STRINGERS PROVIDE 4 PER FLIGHT

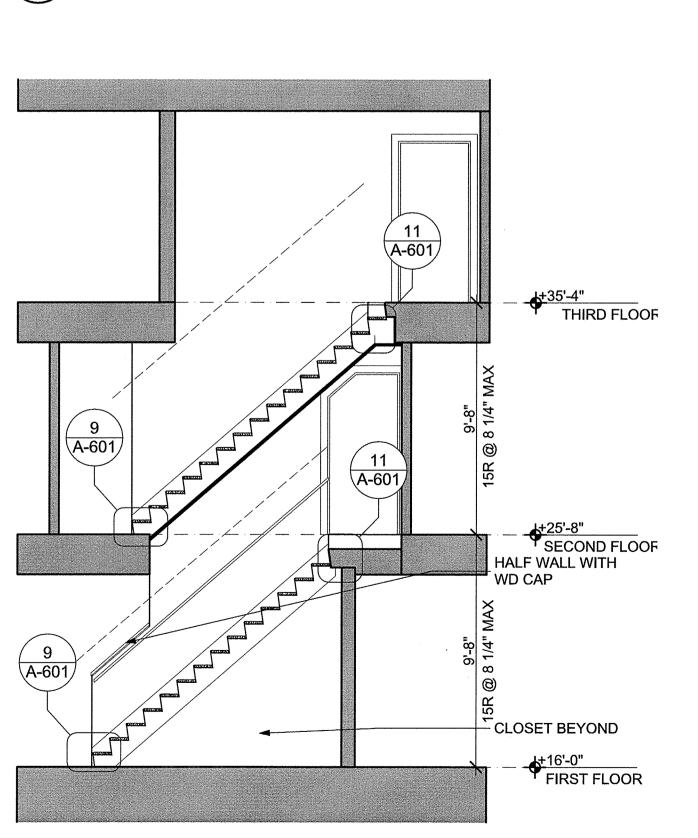

REFER TO STRUCT

--- DRW'S FOR LANDING
FRAMING DETAIL @ LANDING

SCALE: 1 1/2"= 1'-0"

WOOD CAP W/ URETHANE FINISH

- 2X4 TOP PLATE

10 DETAIL @ HALF WALL CAP

SCALE: 3" = 1'-0"

REFER TO STAIR
- SECTIONS FOR

TREAD WIDTH

- 2X4 WOOD STUDS

5/8 GWB BOTH SIDES

REFER TO STAIR – SECTIONS FOR RISER HEIGHT

- BROSCO #8090

- 3/4" SKIRT BOARD

- 1/4" ROUND TRIM


- WOOD RISER

REFER TO FINISH - SCHEDULE FOR LANDING

MATERIAL FINISHES

- WOOD TREAD

- PAINT BLACK - BOTH SIDES

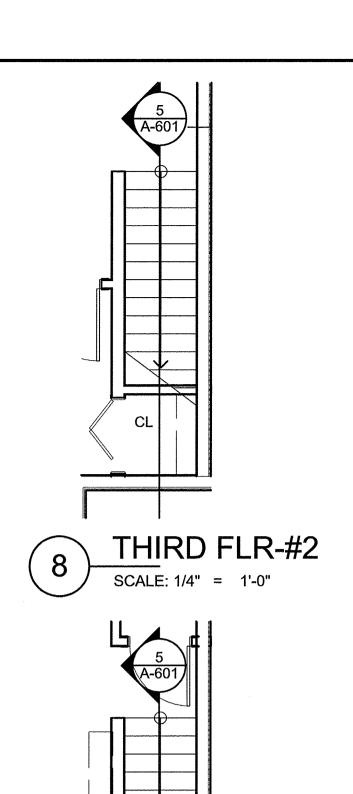

6 FIRST FLR-#2

SCALE: 1/4" = 1'-0"

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SECOND FLR-#2

SCALE: 1/4" = 1'-0"




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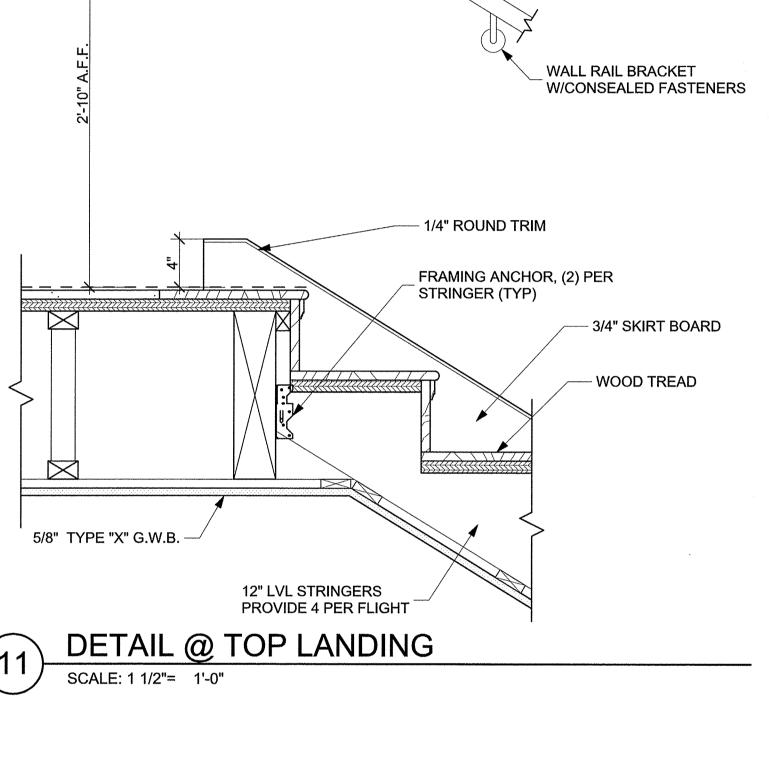
SHEET TITLE

TOWNHOUSE INT. UNIT STAIRS PLANS, **SECTIONS & DETAILS** 

A-601





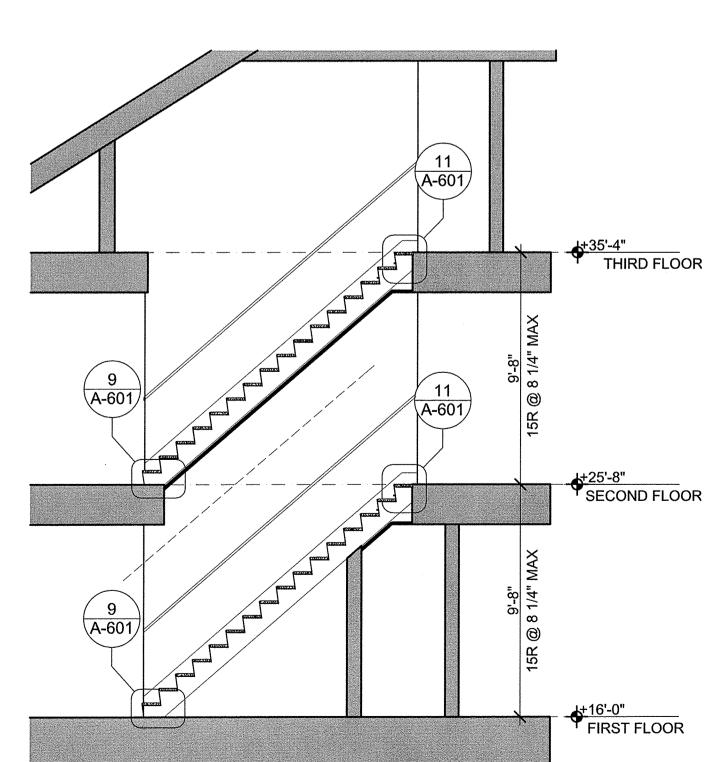


WOOD WALL RAIL BROSCO # WM231 - SEE PLAN FOR CONFIGURATION -

BLDG A INT UNIT STAIR #3 - 3BR/4BR


SCALE: 1/4" = 1'-0"

FIRST FLR-#3


SCALE: 1/4" = 1'-0"

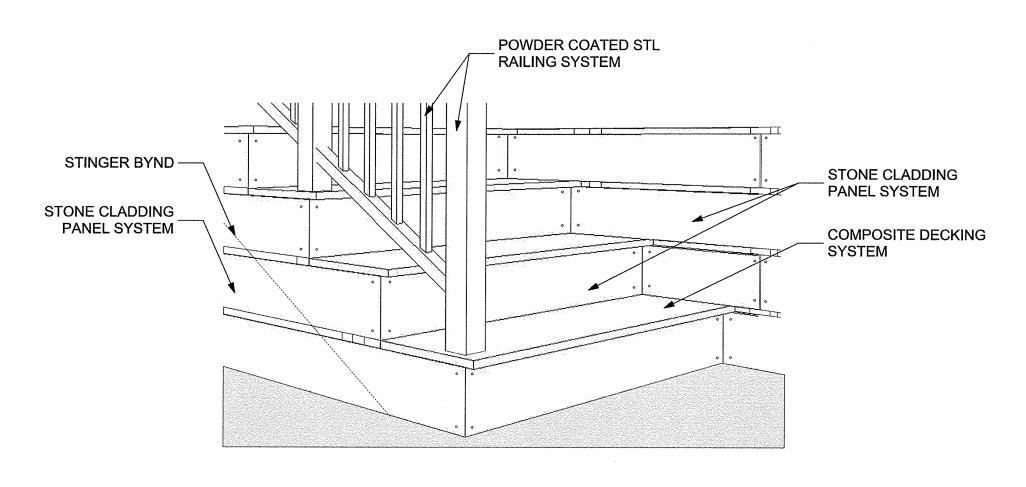


## 5 DETAIL @ EXTERIOR STAIR SCALE: 1" = 1'-0"

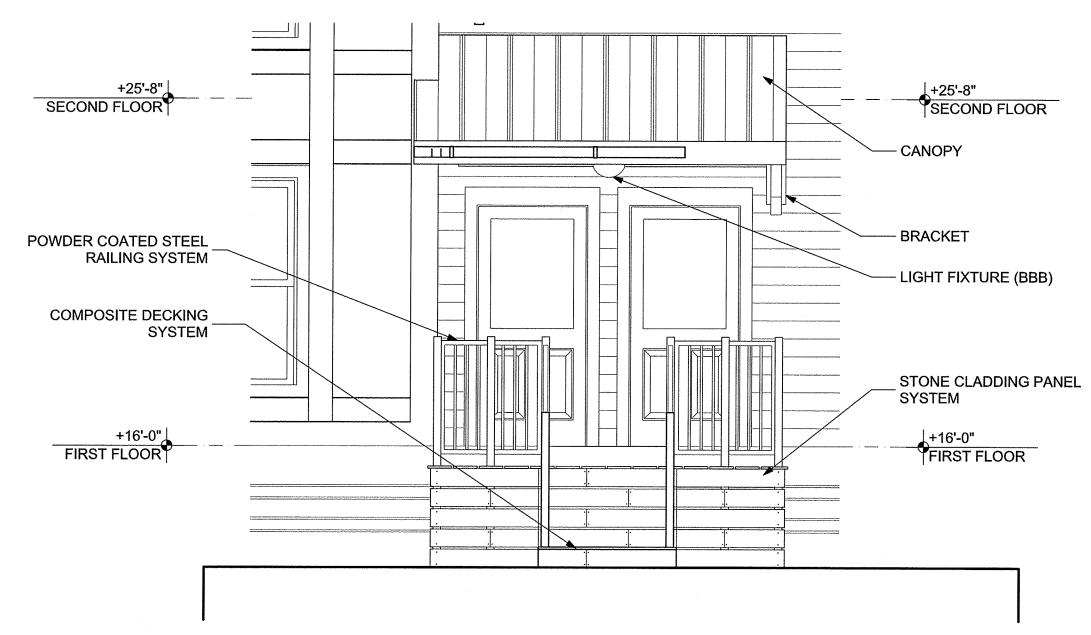


**ENTRY STAIR ELEVATION** 

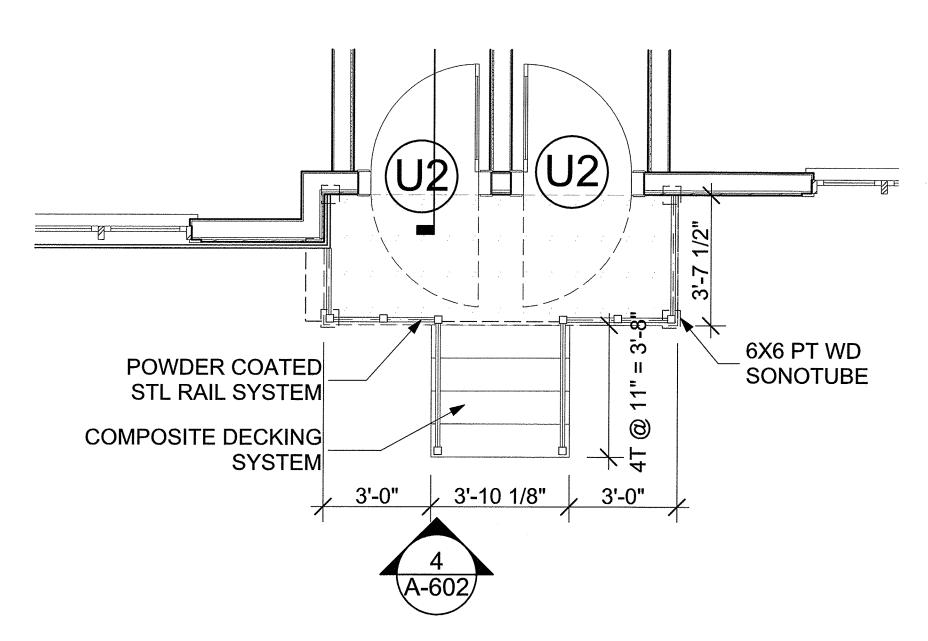

**ENTRY STAIRS** 

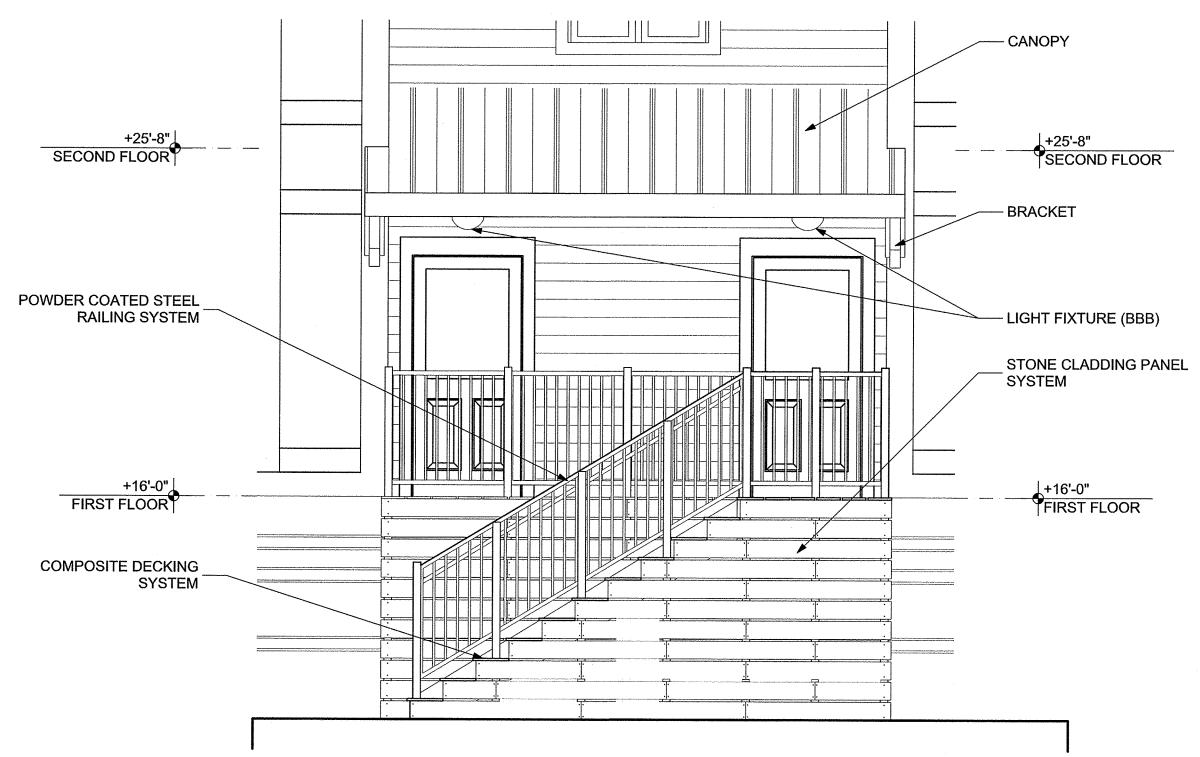

**ENTRY STAIR ELEVATION** 

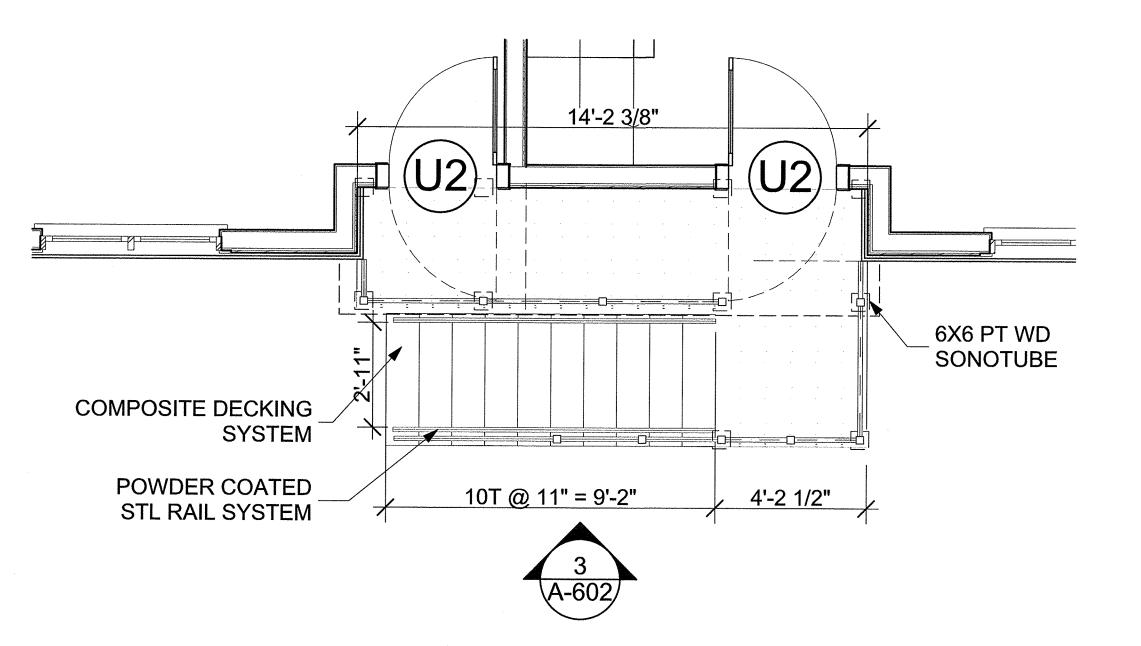

**ENTRY STAIRS** SCALE: 3/8" = 1'-0"

## Washington Village Phase 1

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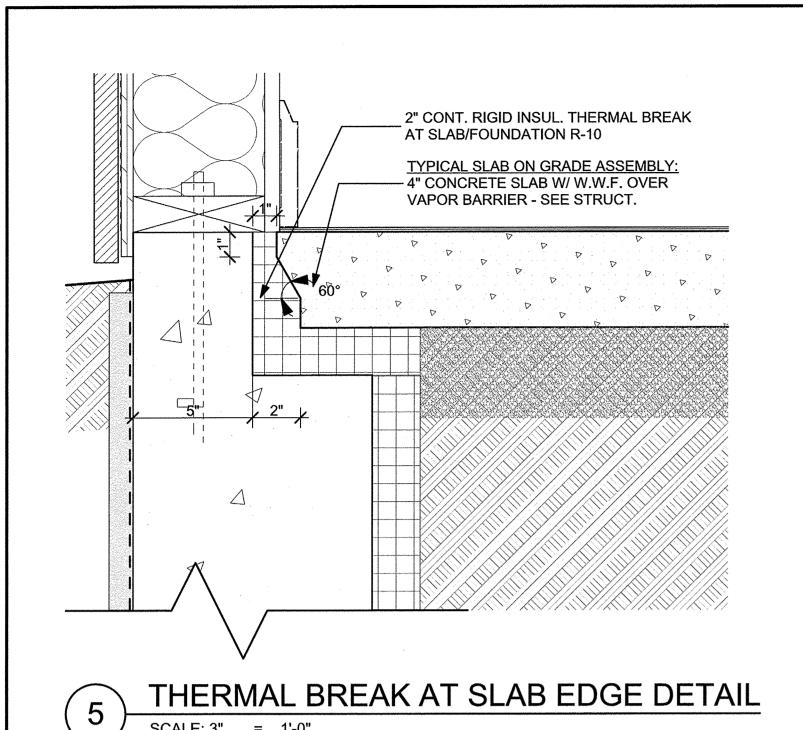
MARK DATE DESCRIPTION PROJECT NO.: 21222


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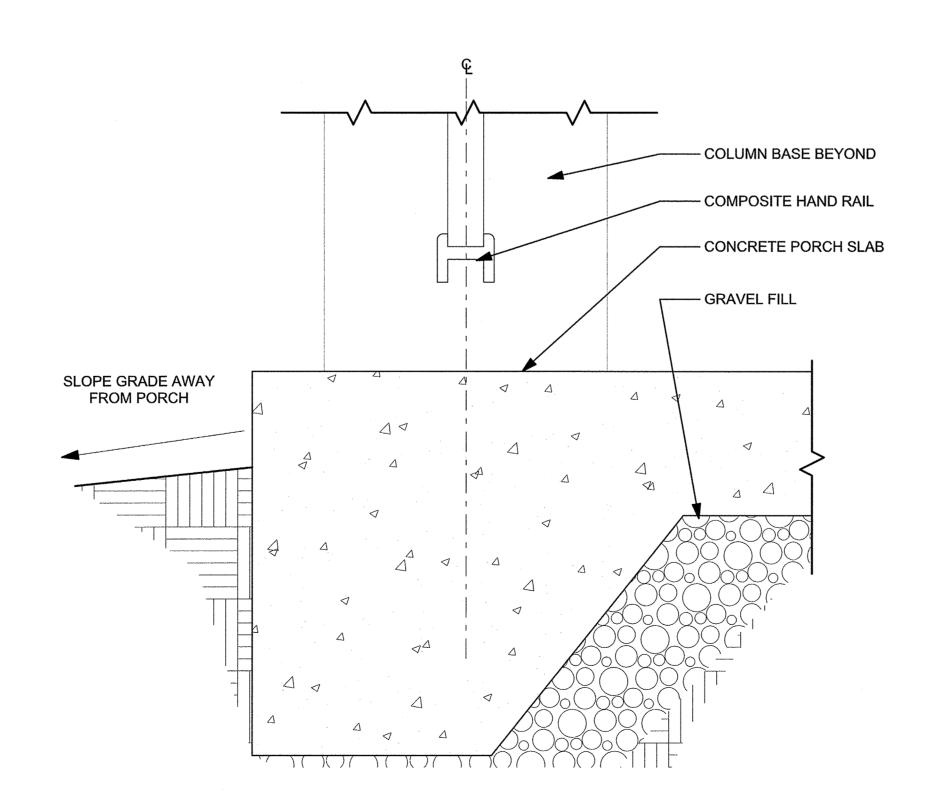
DRAWN BY:

CHECKED BY:

**EXTERIOR STAIRS** 







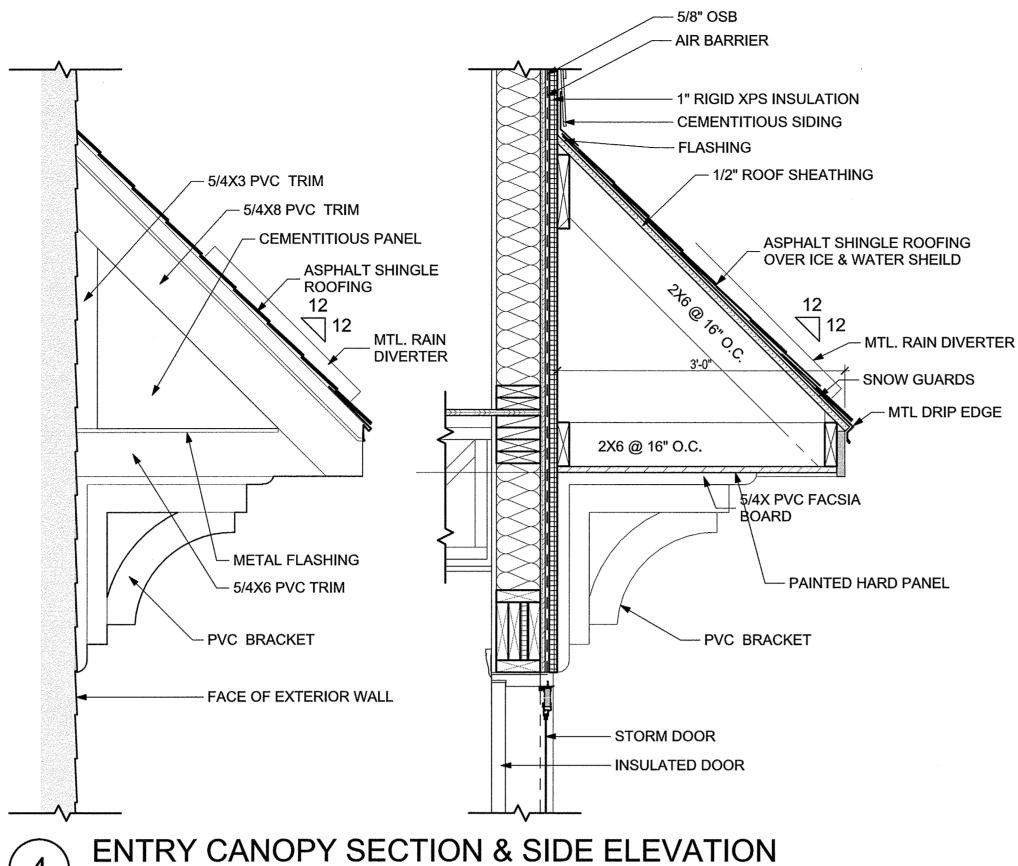

PORCH EDGE DETAIL

SCALE: 3" = 1'-0"

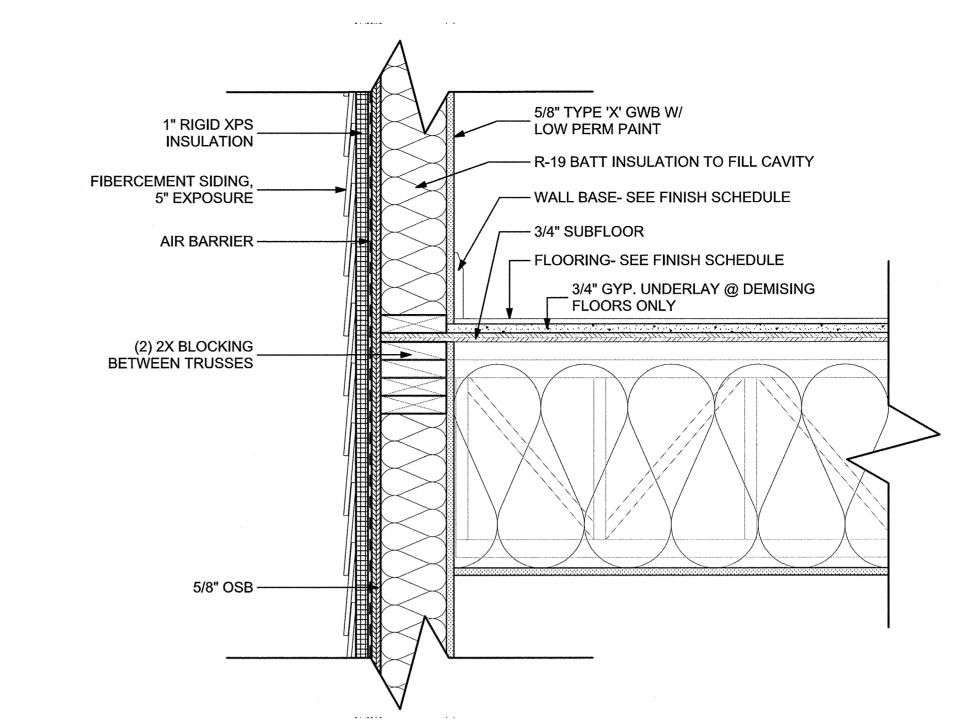

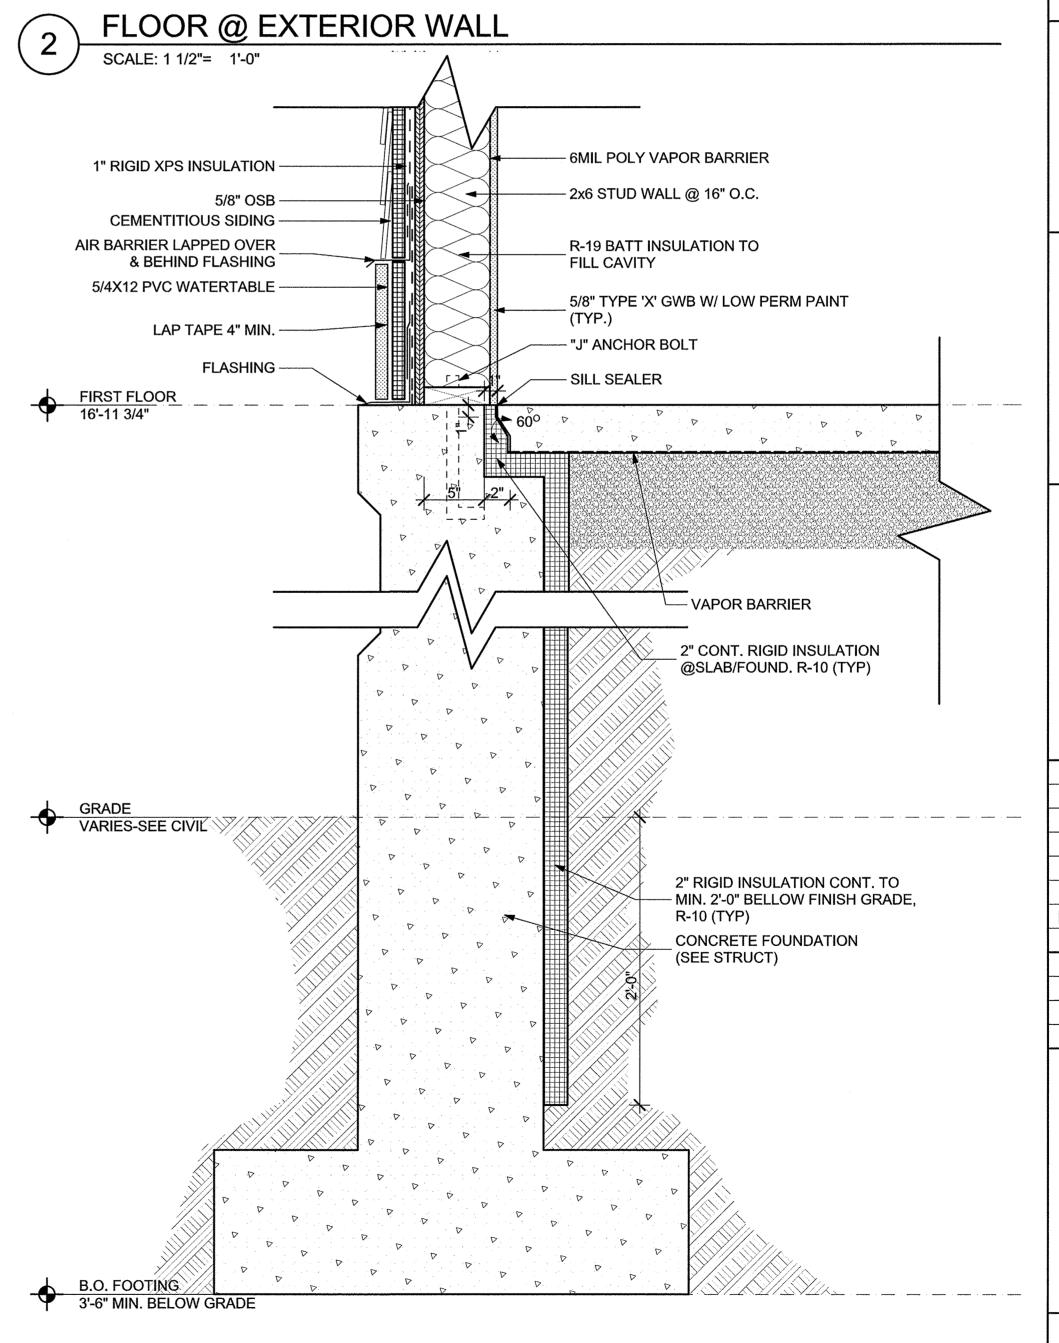

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## E-ICON ARCHITECTURE

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PROJECT NO.: 21222
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CHECKED BY:


SHEET TITLE


**EXTERIOR DETAILS** 

A-701


1 EXTERIOR WALL @ FOUNDATION

SCALE: 1 1/2"= 1'-0"

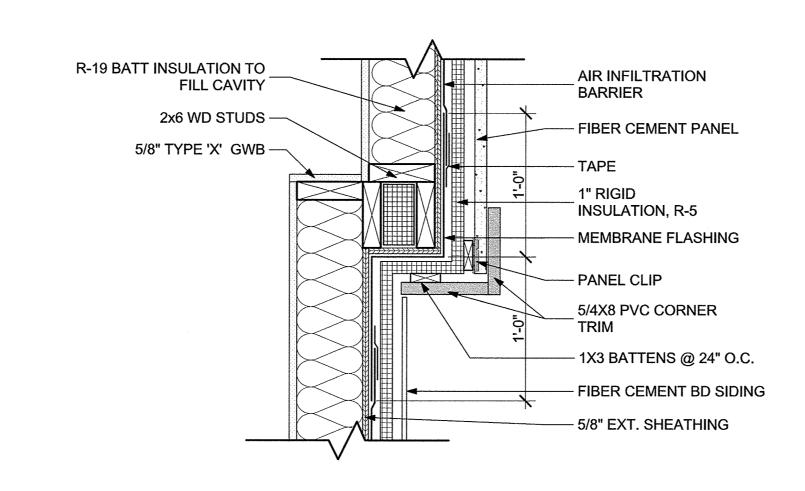

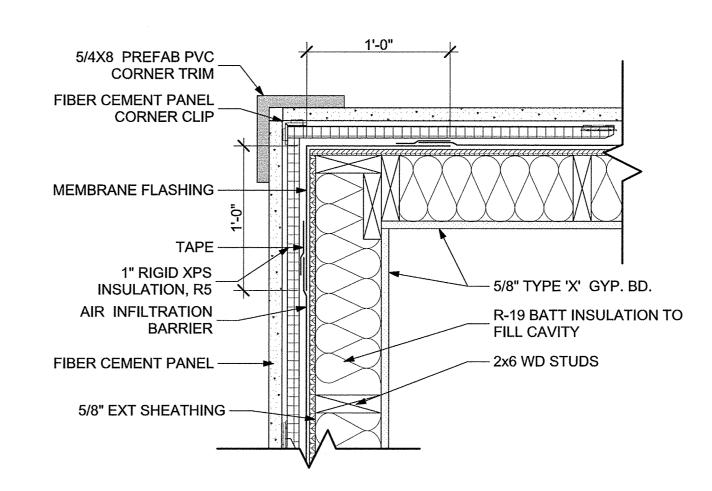


FIBER CEMENT PANEL @ OUTSIDE CORNER

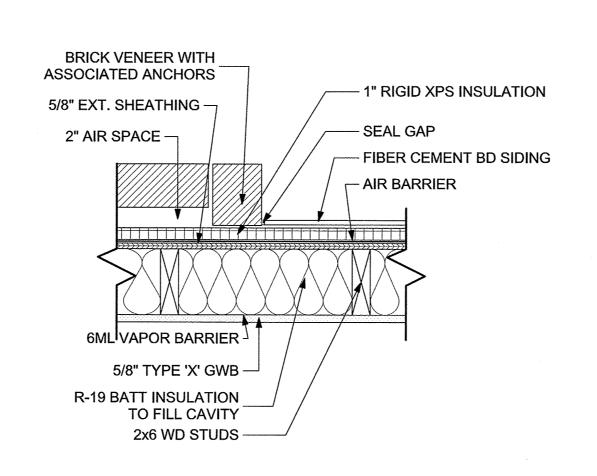


MATERIAL TRANSITION

**BAY CORNER** 

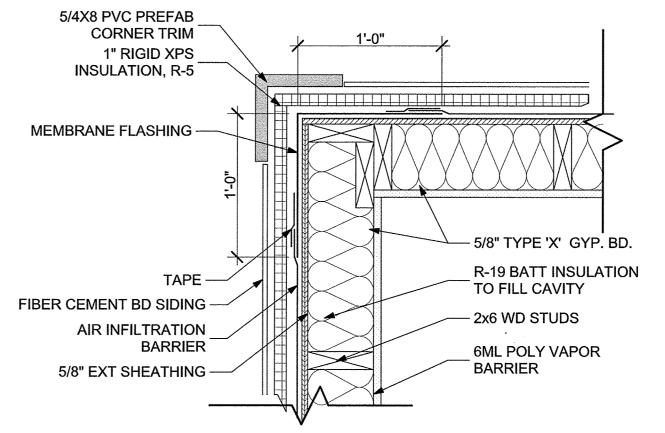

FIBER CEMENT SIDING @ OUTSIDE CORNER

SCALE: 1 1/2"= 1'-0"

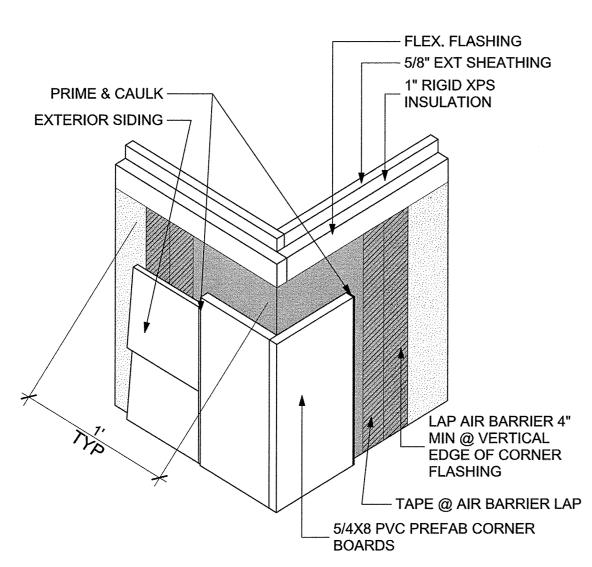

5/8" TYPE 'X' GWB R-19 BATT **INSULATION TO-**FILL CAVITY FIBER CEMENT PANEL 5/8" EXT. W/ ASSOCIATED CLIPS **SHEATHING** - 5/4 X 5/4 PVC TRIM - 1" RIGID XPS INSULATION 6ML POLY VAPOR - MEMBRANE FLASHING 2x6 WD STUDS -- FIBER CEMENT BD SIDING - AIR BARRIER

FIBER CEMENT SIDING INSIDE CORNER SCALE: 1 1/2"= 1'-0"

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Washington Village

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SHEET TITLE

PLAN DETAILS

A-702

CORNER SIDING DETAIL SCALE: 3" = 1'-0"

LAP AIR BARRIER 4" MIN @ VERTICAL EDGE OF CORNER

FLEX. FLASHING -

**EXTERIOR SIDING** -

1" RIGID XPS INSULATION

5/8" EXT SHEATHING -

INSIDE CORNER BOARDS -

TAPE @ AIR BARRIER LAP


FLASHING

FIBER CEMENT TRANSITION @ INSIDE CORNER

SCALE: 1 1/2"= 1'-0"


5/8" TYPE 'X' GYP. BD.

R-19 BATT INSULATION TO FILL CAVITY 5/8" EXT. SHEATHING - 5/4 X 5/4 PVC TRIM **6ML POLY VAPOR BARRIER** - FLEX. FLASHING - 1" RIGID XPS INSULATION 2x6 WD STUDS - FIBER CEMENT BD SIDING

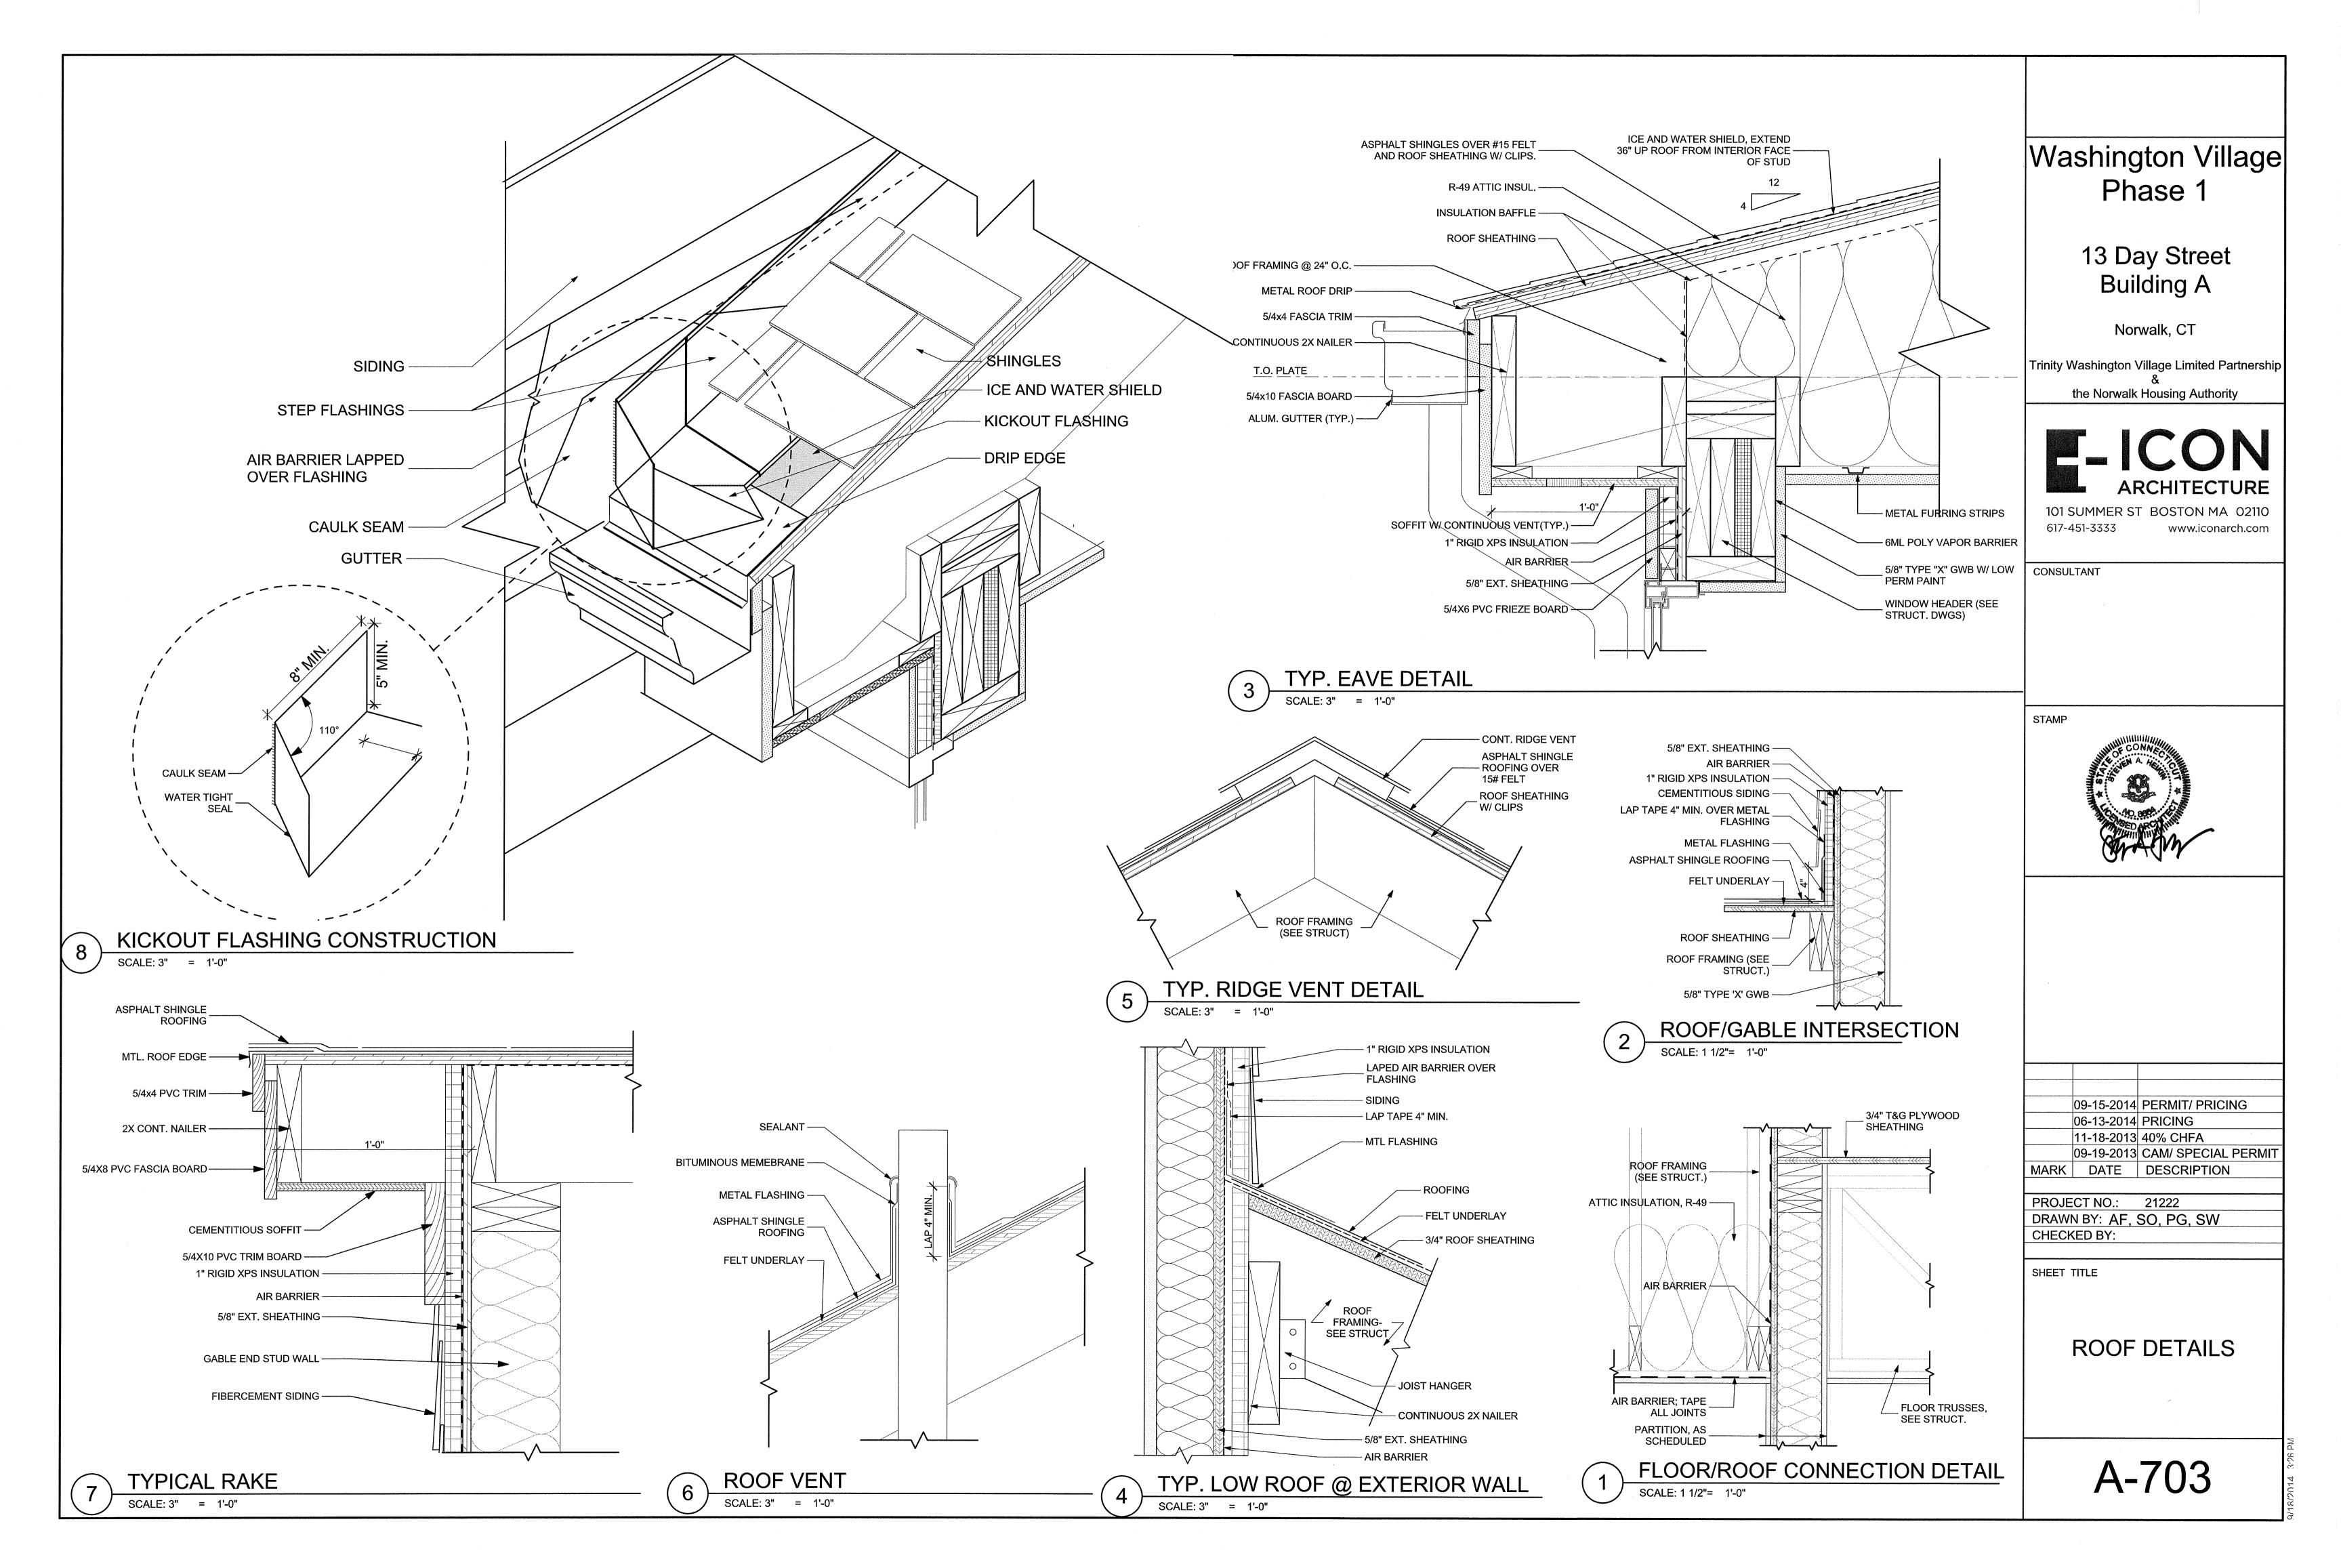

			BUIL	DING A WI	NDOW S	CHEDULE	
TYPE	. SI	ZE	MATL.		DETAIL		NOTES/REMARKS
	WIDTH	HEIGHT	IVIA I L.	HEAD	JAMB	SILL	NOTES/KEIVIAKKS
Α	2'-6"	3'-0"	FIBERGLASS	3/A-802	2/A-802	1/A-802	
В	2'-6"	5'-0"	FIBERGLASS	3/A-802	2/A-802	1/A-802	
С	2'-6"	6'-0"	FIBERGLASS	3/A-802	2/A-802	1/A-802	
D	4'-0"	5'-0"	FIBERGLASS	3/A-802	2/A-802	1/A-802	
E	5'-0"	6'-0"	FIBERGLASS	3/A-802	2/A-802	1/A-802	

WINDOW ELEVATIONS

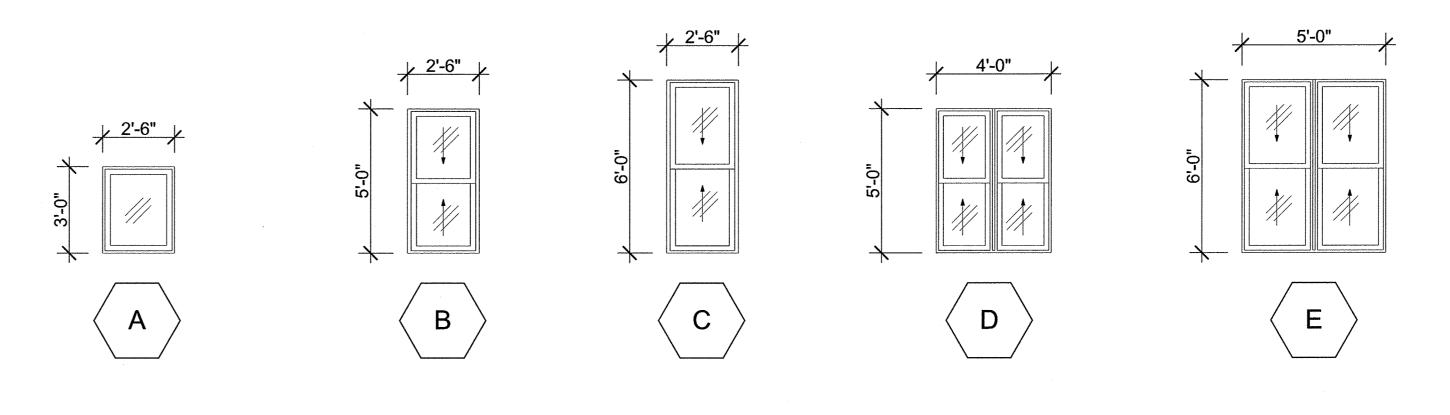

NOTE: ALL OPERABLE WINDOWS ONLY OPEN 4" FOR CHILDGUARD REQUIREMENTS

## Washington Village Phase 1

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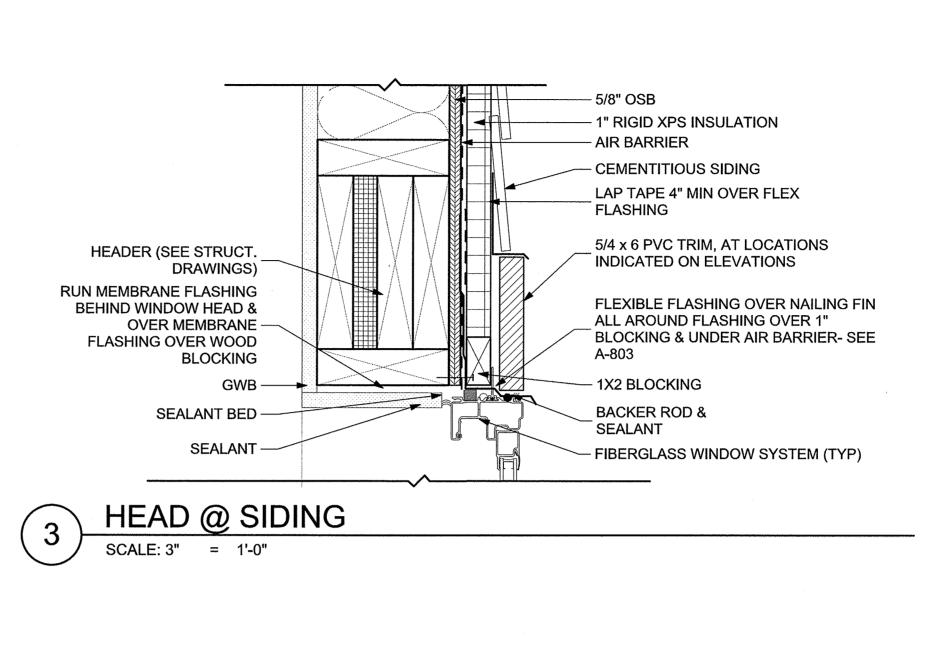
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MARK DATE DESCRIPTION
PROJECT NO.: 21222

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SHEET TITLE

WINDOW SCHEDULE



## **HEAD**

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JAMB STAMP



FLEXIBLE FLASHING LAPPED OVER SILL -FLASHING (TYP) BACKER ROD & SEALANT -LAP FLASHING OVER NAIL FIN (SEE A-801) - BACKER ROD & SEALANT **RUN AIR BARRIER** BEHIND WINDOW JAMB & - 5/4X6 PVC TRIM OVER AIR BARRIER LAP FLEXIBLE FLASHING OVER AIR OVER WOOD STUDS BARRIER 8" MIN. SEALANT BED -\_ LAP AIR BARRIER 4" MIN. - SEALANT - AIR BARRIER - 1" RIGID XPS INSULATION --- EXT. SIDING

2 JAMB @ SIDING

SCALE: 3" = 1'-0"

\_ FLEXIBLE FLASHING, EXTEND UP JAMB MIN. 6" BACKER ROD & SEALANT (TYP). SEAL BACK OF PAN \_ TO BACK OF WINDOW FOR **FIBERGLASS** AIR SEAL - WINDOW SYSTEM (TYP) 3/4X6 MEDEX STOOL BACKER ROD & RUN FLEX FLASHING SEALANT (TYP) OVER PLATE 2 1/2" APRON -- 1X2 BLOCKING SEALANT BED -LAP FLEX FLASHING 4" 6ML POLY VAPOR BARRIER — - 5/4X6 PVC TRIM PREFORMED 1 5/8" SILL ROUT BOTTOM EDGE OF PAN UNDER NAILING FIN& TRIM TO RECEIVE SIDING OVER AIR BARRIER- RUN - CEMENTITIOUS SIDING BACK LEG OF PAN UP TIGHT AGAINST BACK LEG -— AIR BARRIER OF WINDOW SILL- SET PAN INTO 2 BEADS OF SEALANT — 5/8" OSB OVER FLASHING OVER — 1" RIGID XPS INSULATION WOOD FRAMING

SILL @ SIDING
SCALE: 3" = 1'-0"

SILL

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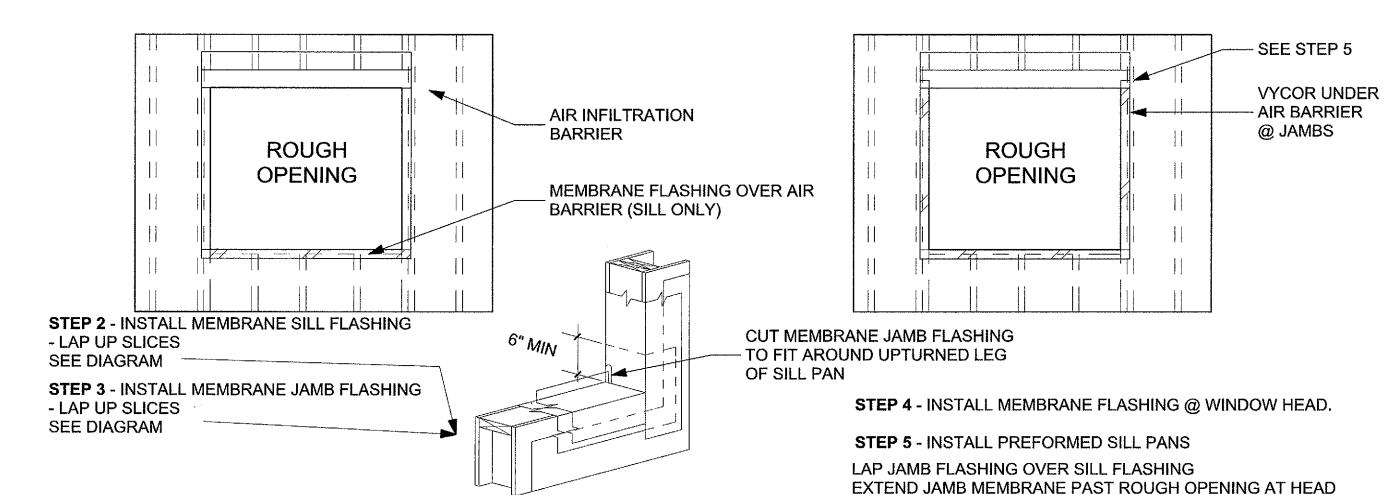
WINDOW DETAILS


A-802

N478/2014 3:26 PM


### **CURL BACK AIR INFILTRATION BARRIER AT** WINDOW HEAD ROUGH **OPENING CUT BACK 3"** - AT JAMB TO **EXPOSE SHEATHING** CUT BACK 3" - AT SILL TO **EXPOSE SHEATHING** STEP 1 - FOLD BACK AIR INFILTRATION BARRIER

**HEAD ONLY** 




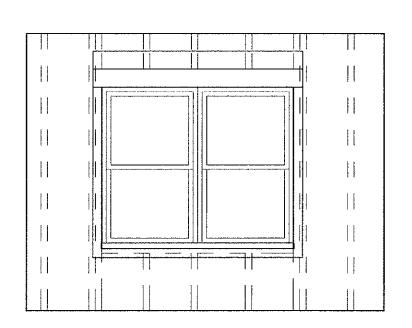


**STEP 6 - INSTALL WINDOW PER MANUFACTURER'S** INSTRUCTIONS, SEAL THE WINDOW, SET WINDOW IN A BED OF SEALANT. DO NOT CAULK OVER SILL PAN WEEPS IN THE CORNERS!

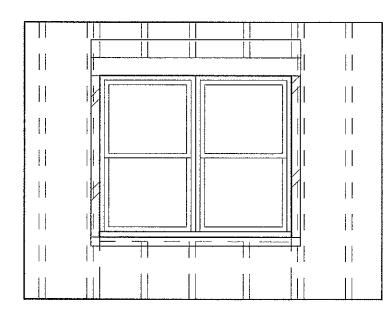

**STEP 7 - LAP SECOND LAYER OF FLASHING** OVER WINDOW NAILING FIN AT JAMBS ONLY **BUT UNDER AIR BARRIER** 

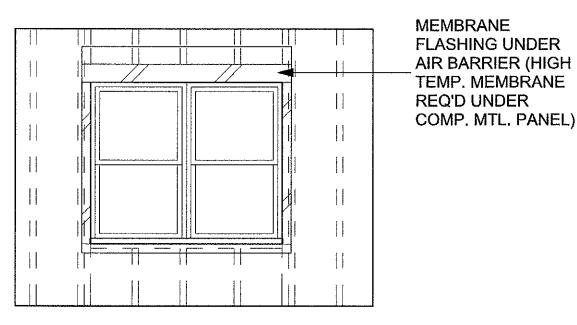

STEP 8 - AT WINDOW HEAD, INSTALL MEMBRANE FLASHING OVER WINDOW NAILING FIN.

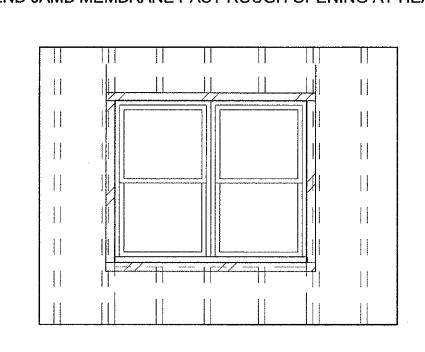

**STEP 9 - LAP AIR INFILTRATION BARRIER OVER** HEAD FLASHING. TAPE AIR BARRIER TO MEMBRANE FLASHING TIGHT TO WINDOW AT JAMB & HEAD USING AIR BARRIER TAPE.

### WINDOW FLASHING AND INSTALLATION SEQUENCE

PROVIDE SEALANT @ INSIDE & OUTSIDE FACE OF NAILING FIN

INSTALL AIR INFILTRATION AND WEATHER BARRIER (AB) IN AN OVERLAPPING PATTERN, WITH EACH STRIP OVERLAPPING THE LOWER STRIP BY 4 INCHES. OVERLAP VERTICAL JOINTS BY 6", OR TAPE VERTICAL JOINTS.

- STEP 1. CUT AIR BARRIER AT WINDOW OPENING 3" BIGGER THAN THE R.O. EXPOSING THE SHEATHING AT THE HEAD AND JAMBS. (FOR EXAMPLE, IF THE RO IS 3'X 5' THE AIR BARRIER WILL BE 3'-6" X 5'-3") CUT THE AB FLUSH WITH THE BOTTOM OF THE R.O. AND CURL THE AB UP AND TAPE UNTIL THE FINAL STEP.
- STEP 2. AT THE SILL; CUT A PIECE OF MEMBRANE FLASHING 12" LONGER THAN THE SILL R.O. LENGTH, AND WIDE ENOUGH TO COVER THE SILL FRAMING AND LAP DOWN 3" ONTO THE AB. INSTALL THE FLASHING ON THE SILL WITH 6" LAPPED UP BOTH SIDES.
- STEP 3. AT THE JAMBS; CUT 2 PIECES OF MEMBRANE FLASHING 12" LONGER THAN THE VERTICAL R.O. LENGTH, AND WIDE ENOUGH TO COVER THE JAMB FRAMING BY 5" AND LAP 3" ONTO THE SHEATHING. INSTALL THE FLASHING AT THE JAMBS 6" PAST THE TOP AND BOTTOM OF THE R.O. AND LAP OVER THE SILL FLASHING.
- STEP 4. AT THE HEAD; CUT A PIECE OF MEMBRANE FLASHING 12" LONGER THAN THE HEAD R.O. LENGTH, AND WIDE ENOUGH TO COVER 5" AT THE BOTTOM OF THE FRAMING MEMBERS AND LAP 3" UP ONTO THE SHEATHING.

- STEP 5. INSTALL PREFORMED PVC SILL PAN IN A BED OF SEALANT, CUT TWO 6"X 6" PIECES OF FLASHING AND INSTALL OVER THE ENDS OF THE PVC PAN TO THE EXISTING JAMB FLASHING.
- STEP 6. (INSTALL WINDOW PER MANUFACTURES INSTRUCTIONS.) CAULK PERIMETER OF WINDOW R.O. DO NOT CAULK OVER PVC PAN WEEPS!!! INSTALL WINDOW PLUMB AND LEVEL. TACK CORNERS. VERIFY WINDOW SASHES OPERATE SMOOTHLY. NAIL IN THE MIDDLE OF THE NAILING SLOT TO ALLOW FOR EXPANSION AND CONTRACTIONS. NAIL EVERY NAIL SLOT. SHIM WINDOW AT MEETING RAIL SO THE WINDOW WIDTH IS THE SAME AS THE BOTTOM AND TOP. CAULK UP THE JAMBS 2".
- STEP 7. CUT 2 PIECES OF 6" WIDE FLASHING 12" LONGER THAN THE HEIGHT OF THE WINDOW. INSTALL 6" ABOVE THE WINDOW AND OVER THE NAILING FLANGE AT THE SIDES OF THE WINDOW.
- STEP 8. CUT 6" WIDE FLASHING 12" LONGER THAN WINDOW WIDTH. INSTALL AT TOP OF WINDOW OVER THE NAILING FLANGE TO THE SHEATHING WITH 6" EXTENDING PAST THE WINDOW (BELOW THE AB) ON BOTH SIDES.
- STEP 9. FOLD BACK THE AB OVER THE FLASHING AND TAPE ALL EDGES TO THE FLASHING. THIS IS IMPORTANT AS THIS CONNECTS THE FLASHING TO
- STEP 10. (NOT SHOWN) PROVIDE INTERIOR SEAL AROUND WINDOW PERIMETER TO MAINTAIN CONTINUITY OF BUILDING THERMAL AND AIR BARRIER USING INSULATING-FOAM SEALANT.
- STEP 11. (NOT SHOWN) SEAL WINDOW TO EXTERIOR WALL CLADDING WITH SEALANT AND RELATED BACKING MATERIALS AT PERIMETER OF ASSEMBLY.

## Washington Village Phase 1

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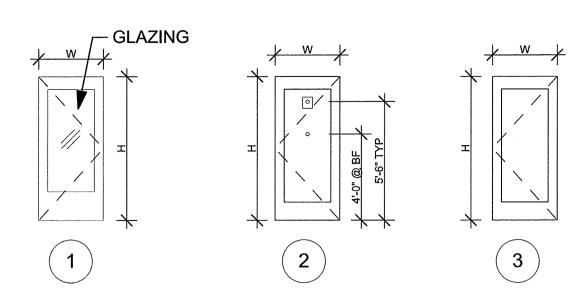
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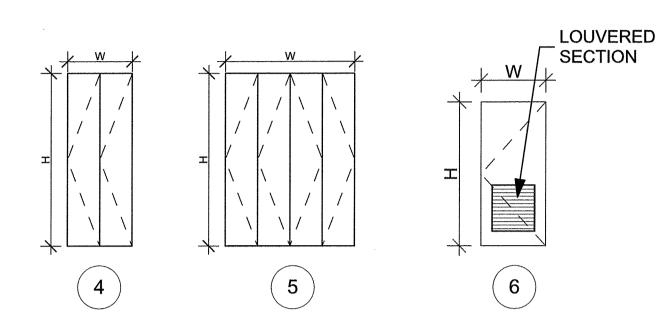
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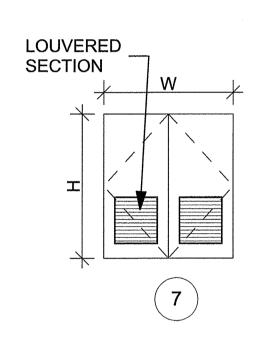
SHEET TITLE

WINDOW FLASHING PROCEDURE


## **DOOR TYPES**







### FRAME TYPES

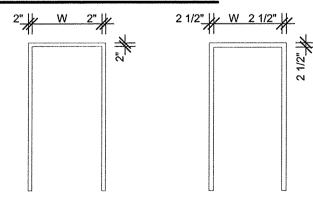



B

DOOR & FRAME SCHEDULE

	DOOR		5	SIZE	DESCRIPTION	OPERATION		DOOR			FRAME		DETAIL			HARDWARE	FIRE	NOTES
	NO.	W	Н	THICKNESS	DEGGRIFTION	OFLICATION	ELEV.	MATL.	FINISH	TYPE	MATL.	FINISH	HEAD	JAMB	SILL	SET	RATING	NOTES
	Α	3'-0"	6-'8"	1 3/4"	BEDROOM	SWING, SINGLE	3	WD	PTD	В	WD	PTD	4/A-805	4/A-805	2/A-805	25		
	В	3'-0"	6-'8"	1 3/4"	BATHROOM	SWING, SINGLE	3	WD	PTD	В	WD	PTD	4/A-805	4/A-805	3/A-805	25		
	С	3'-0"	6-'8"	1 3/4"	CLOSET	SWING, SINGLE	3	WD	PTD	В	WD	PTD	4/A-805	4/A-805	2/A-805	26		
	C1	1'-6"	6-'8"	1 3/4"	CLOSET	SWING, SINGLE	3	WD	PTD	В	WD	PTD	4/A-805	4/A-805	2/A-805	26		
	C2	2'-6"	6-'8"	1 3/4"	CLOSET	SWING, SINGLE	3	WD	PTD	В	WD	PTD	4/A-805	4/A-805	2/A-805	26		
	C3	3'-0"	8'-9"	0 3/4"	CLOSET	BIFOLD, SINGLE	4	WD	PTD	В	WD	PTD	6/A-805		5/A-805	28		
ارا	C4	4'-0"	8'-9"	0 3/4"	CLOSET	BIFOLD, DOUBLE	5	WD	PTD	В	WD	PTD	6/A-805		5/A-805	29		
ORS	C5	5'-0"	8'-9"	0 3/4"	CLOSET	BIFOLD, DOUBLE	5	WD	PTD	В	WD	PTD	6/A-805		5/A-805	29		
8	C6	6'-0"	8'-9"	0 3/4"	CLOSET	BIFOLD, DOUBLE	5	WD	PTD	В	WD	PTD	6/A-805		5/A-805	29		
	C7	6'-0"	6-'8"	1 3/4"	CLOSET	SWING, DOUBLE	7	, WD	PTD	В	WD	PTD	4/A-805	4/A-805	2/A-805	27		
17[	C8	3'-0"	6-'8"	1 3/4"	CLOSET	SWING, SINGLE	6	WD	PTD	В	WD	PTD	4/A-805	4/A-805	2/A-805	26		
	C9	2'-6"	6-'8"	1 3/4"	CLOSET	SWING, SINGLE	6	WD	PTD	В	WD	PTD	4/A-805	4/A-805	2/A-805	26		
	M	3'-0"	6-'8"	1 3/4"	UNIT MECHANICAL	SWING, SINGLE	3	VINYL	PTD	В	MTL	PTD	4/A-805	4/A-805	2/A-805	30		BUILDING A ONLY
	M1	1'-6"	6-'8"	1 3/4"	UNIT MECHANICAL	SWING, SINGLE	3	VINYL	PTD	В	MTL	PTD	4/A-805	4/A-805	2/A-805	30		BUILDING A ONLY
	U	3'-0"	6'-8"	1 3/4"	INTERIOR UNIT ENTRY	SWING, SINGLE	2	VINYL	PTD	А	MTL	PTD	8/A-805	8/A-805	7/A-805	23	20 MIN	
	U2	3'-0"	6'-8"	1 3/4"	EXTERIOR UNIT ENTRY	SWING, SINGLE	1	VINYL	PTD	А	MTL	PTD	3/A-806	2/A-806	3/A-807	24		BF UNITS, USE HARDWARE SET #1A
	001A	3'-0"	6-'8"	1 3/4"	EXTERIOR MECHANICAL	SWING, SINGLE	3	MTL	PTD	А	MTL	PTD	3/A-806	1/A-806	4/A-806	7	_	BUILDING A ONLY

## Washington Village Phase 1

## 13 Day Street Building A


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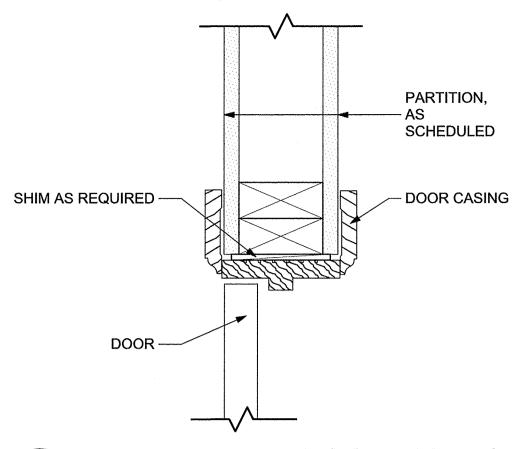
06-13-2014 PRICING 11-18-2013 40% CHFA

09-19-2013 CAM/ SPECIAL PERMIT MARK DATE DESCRIPTION

PROJECT NO.: 21222 DRAWN BY: GA, AJ, SO CHECKED BY:

SHEET TITLE

DOOR SCHEDULE

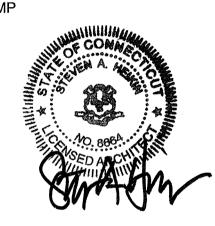

TYPICAL INT. DOOR HEAD/JAMB

DOOR, AS SCHEDULED

CERAMIC TILE

THICKEN MORTAR TO SET
THRESHOLD SO IT CAN CAP TILE

1/2" CEMENTITIOUS UNDERLAYMENT


FLOORING, AS SCHEDULED

WATERPROOFING MEMBRANE


3/4" PLYWOOD SUBFLOOR

BATHROOM THRESHOLD

) SCALE: 3" = 1'-0"

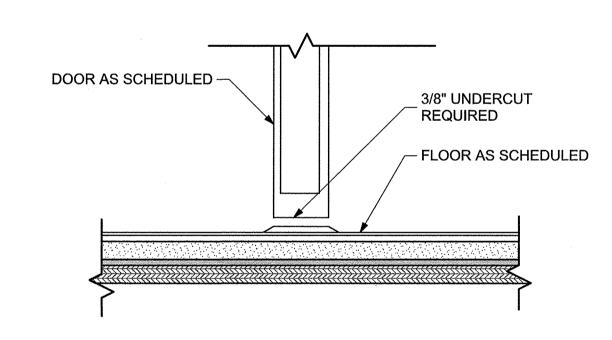

2 TYP. INTERIOR TRANSITION DETAIL

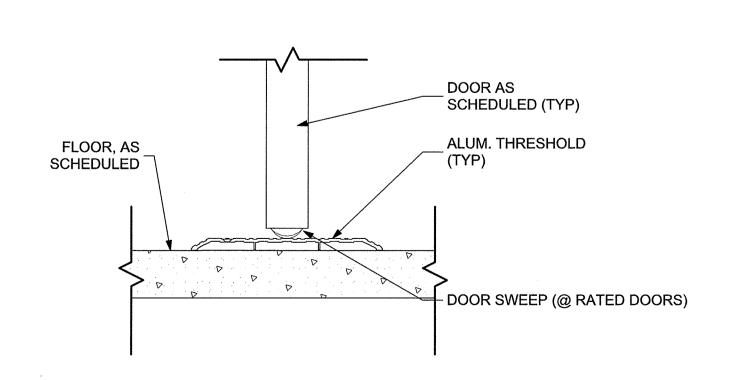

1 TYP. MECH SILL DETAIL

SCALE: 3" = 1'-0"

Washington Village Phase 1

> 13 Day Street Building A

> > Norwalk, CT

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STAMP



09-15-2014 PERMIT/ PRICING
06-13-2014 PRICING
11-18-2013 40% CHFA
09-19-2013 CAM/ SPECIAL PERMIT
MARK DATE DESCRIPTION


PROJECT NO.: 21222

DRAWN BY: AF, SO CHECKED BY:

SHEET TITLE


INTERIOR DOOR DETAILS

A-805

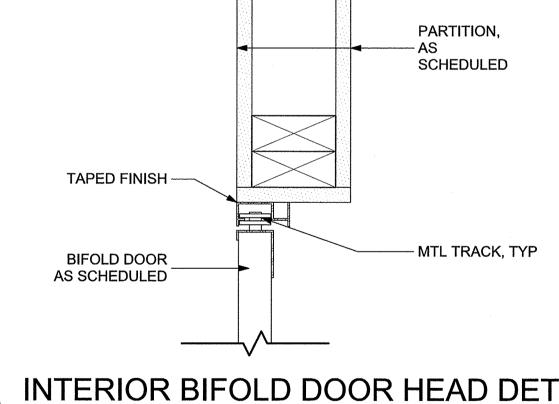


6 INTERIOR BIFOLD DOOR HEAD DETAIL

SCALE: 3" = 1'-0"

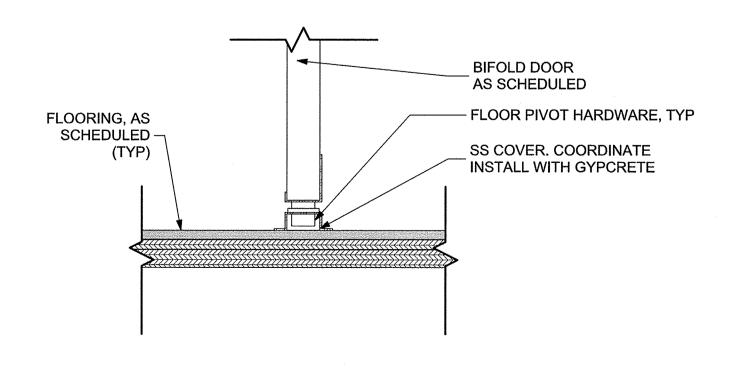


5 INTERIOR BIFOLD DOOR SILL DETAIL


SCALE: 3" = 1'-0"

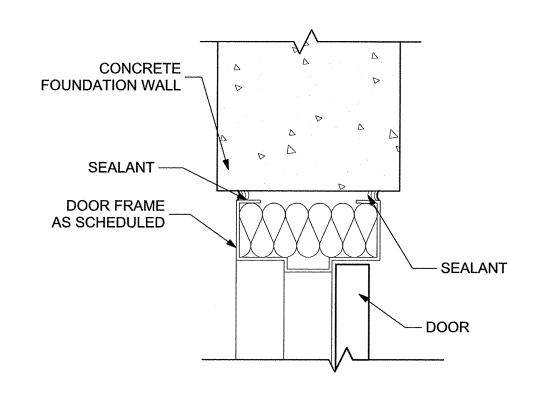

## TYP. EXT. DOOR HEAD/JAMB @ CONCRETE WALL SCALE: 3" = 1'-0" 9"

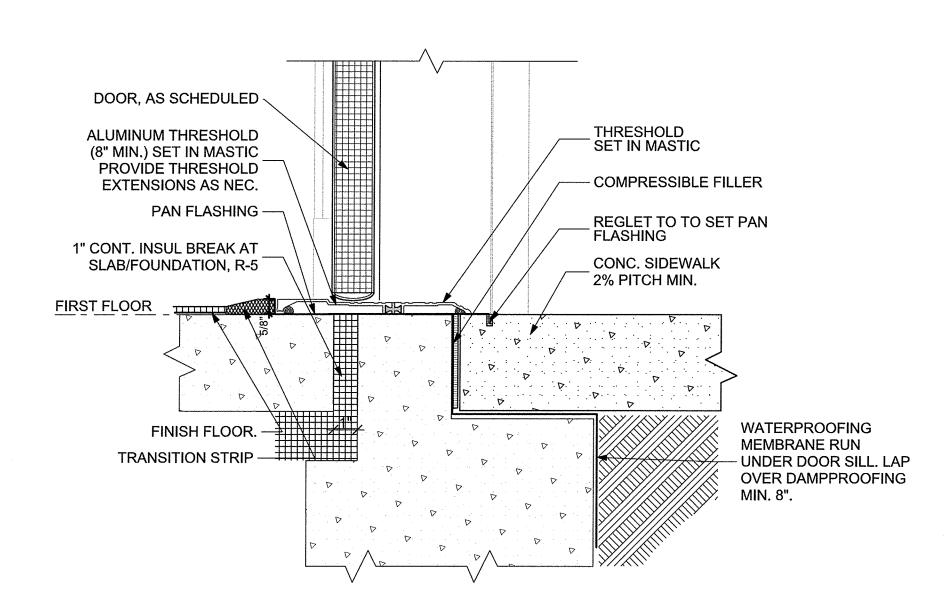


TYP. EXT. DOOR SILL @ CONCRETE SLAB

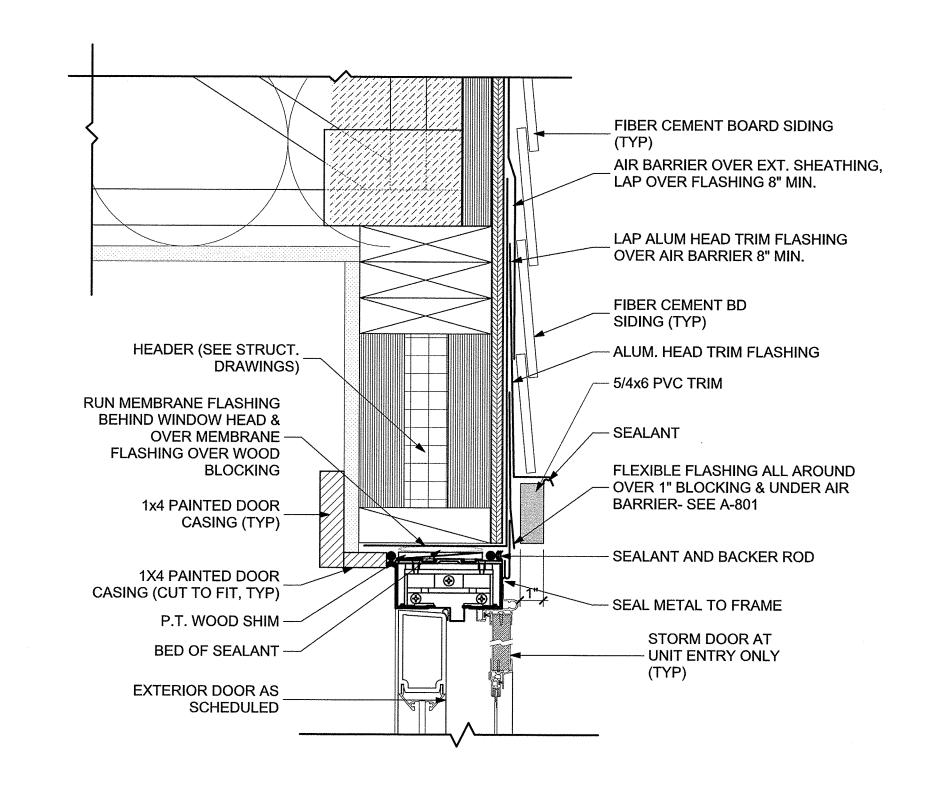


TYP. EXT. DOOR HEAD @ SIDING

SCALE: 3" = 1'-0"

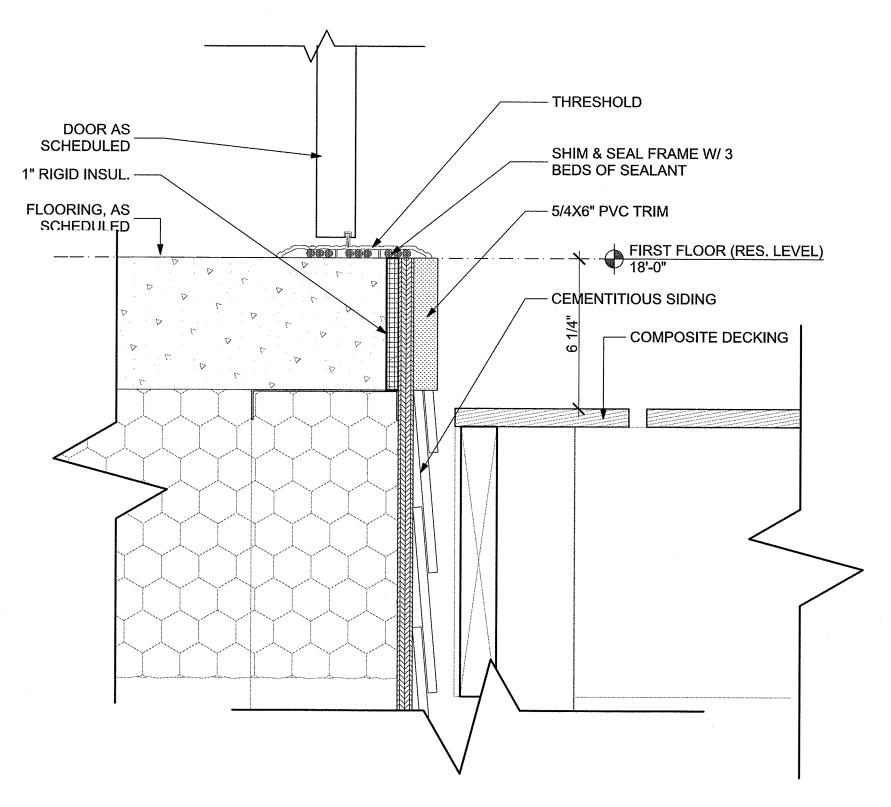

TYP. EXT. DOOR SILL @ SIDING & COMPOSITE DECKING


SCALE: 3" = 1'-0"

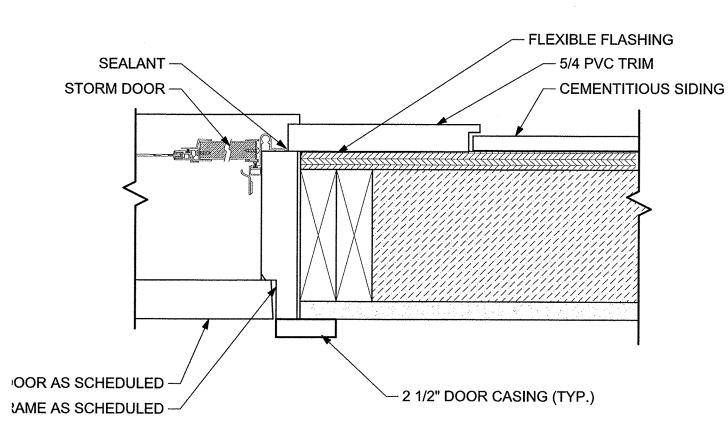

TYP. EXT. DOOR W/ STORM DOOR JAMB @ SIDING

SCALE: 3" = 1'-0" 

8" 8" 8" 9"

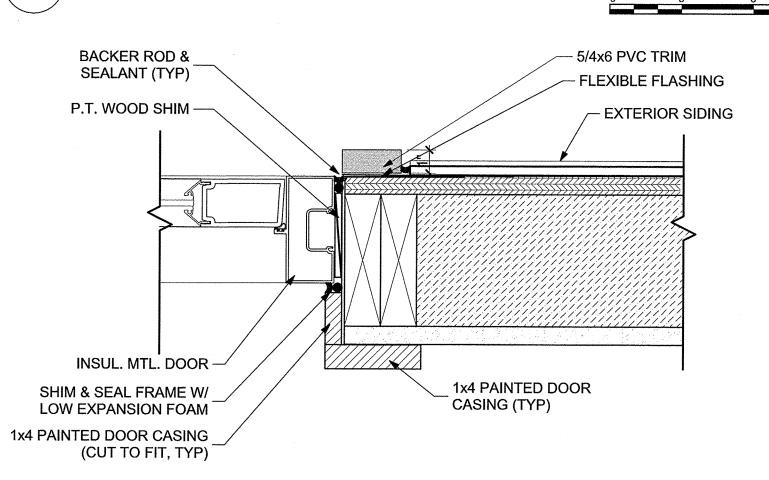

TYP. EXT. DOOR JAMB @ SIDING

SCALE: 3" = 1'-0"

## Washington Village Phase 1

13 Day Street Building A

Norwalk, CT

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PROJECT NO.: 21222
DRAWN BY: AF, SO
CHECKED BY:

SHEET TITLE

EXTERIOR DOOR DETAILS

								OMI	INIS	SH S	CHE	JUL	.E								
RM#	ROOM NAME				FLOO	RING							BAS	SE			WAL	LS	CEI	LING	NOTES
		QOD	EPOXY MAI K OFF MAT	RETE	CARPET	<u> </u>	SHEET VINYL	TREADS ANI	AIN TILE - BATHS	PORCELAIN TILE - COMMON AREAS		E DASE.	BASE - FII	SE		ORCELAIN TILE BASE - COMMON AREA	AINTED GWB	PAINTED CMU	SOUSTIC CEILING TILE	AINTED GWB	
	LIVING DOOM		H N	Ö	S		S		<u>  ŏ</u>	ď			r r			<u>a</u>	Δ	<u> </u>	AC	<u> </u>	
	LIVING ROOM DINING				+	•				-	┠──├			<b>-</b>		-	•			•	
	KITCHEN				+	•			-	-		_	_	+:		+	•	-		•	
	COAT CLOSET			_	1	•			<u> </u>			_		+						•	
	STORAGE CLOSET											_		+-			•	<del>                                     </del>			
	LINEN CLOSET					•								+:		+-+		<del> </del>		-	
<del></del>	LAUNDRY CLOSET						•				l			1.	_		•			•	
	MECHANICAL CLOSET						•							<b>—</b>			•			•	
	HALL				1	•			1	<b>†</b>		_		1.			•			•	
	BEDROOM					•			<del>                                     </del>					<b>—</b>			•			•	
	BEDROOM CLOSET					•		_	1				$\neg$	-	,	<b>† †</b>	•			•	
	BATH							1	•			•		_		<del>                                     </del>	•	+			CT SURROUND
	TOWNHOUSE UNIT STAIRS	•										_		1	•		•				CLR STAIN ON WD TREADS/ PTD PLYWD RISERS

## Washington Village Phase 1

## 13 Day Street Building A

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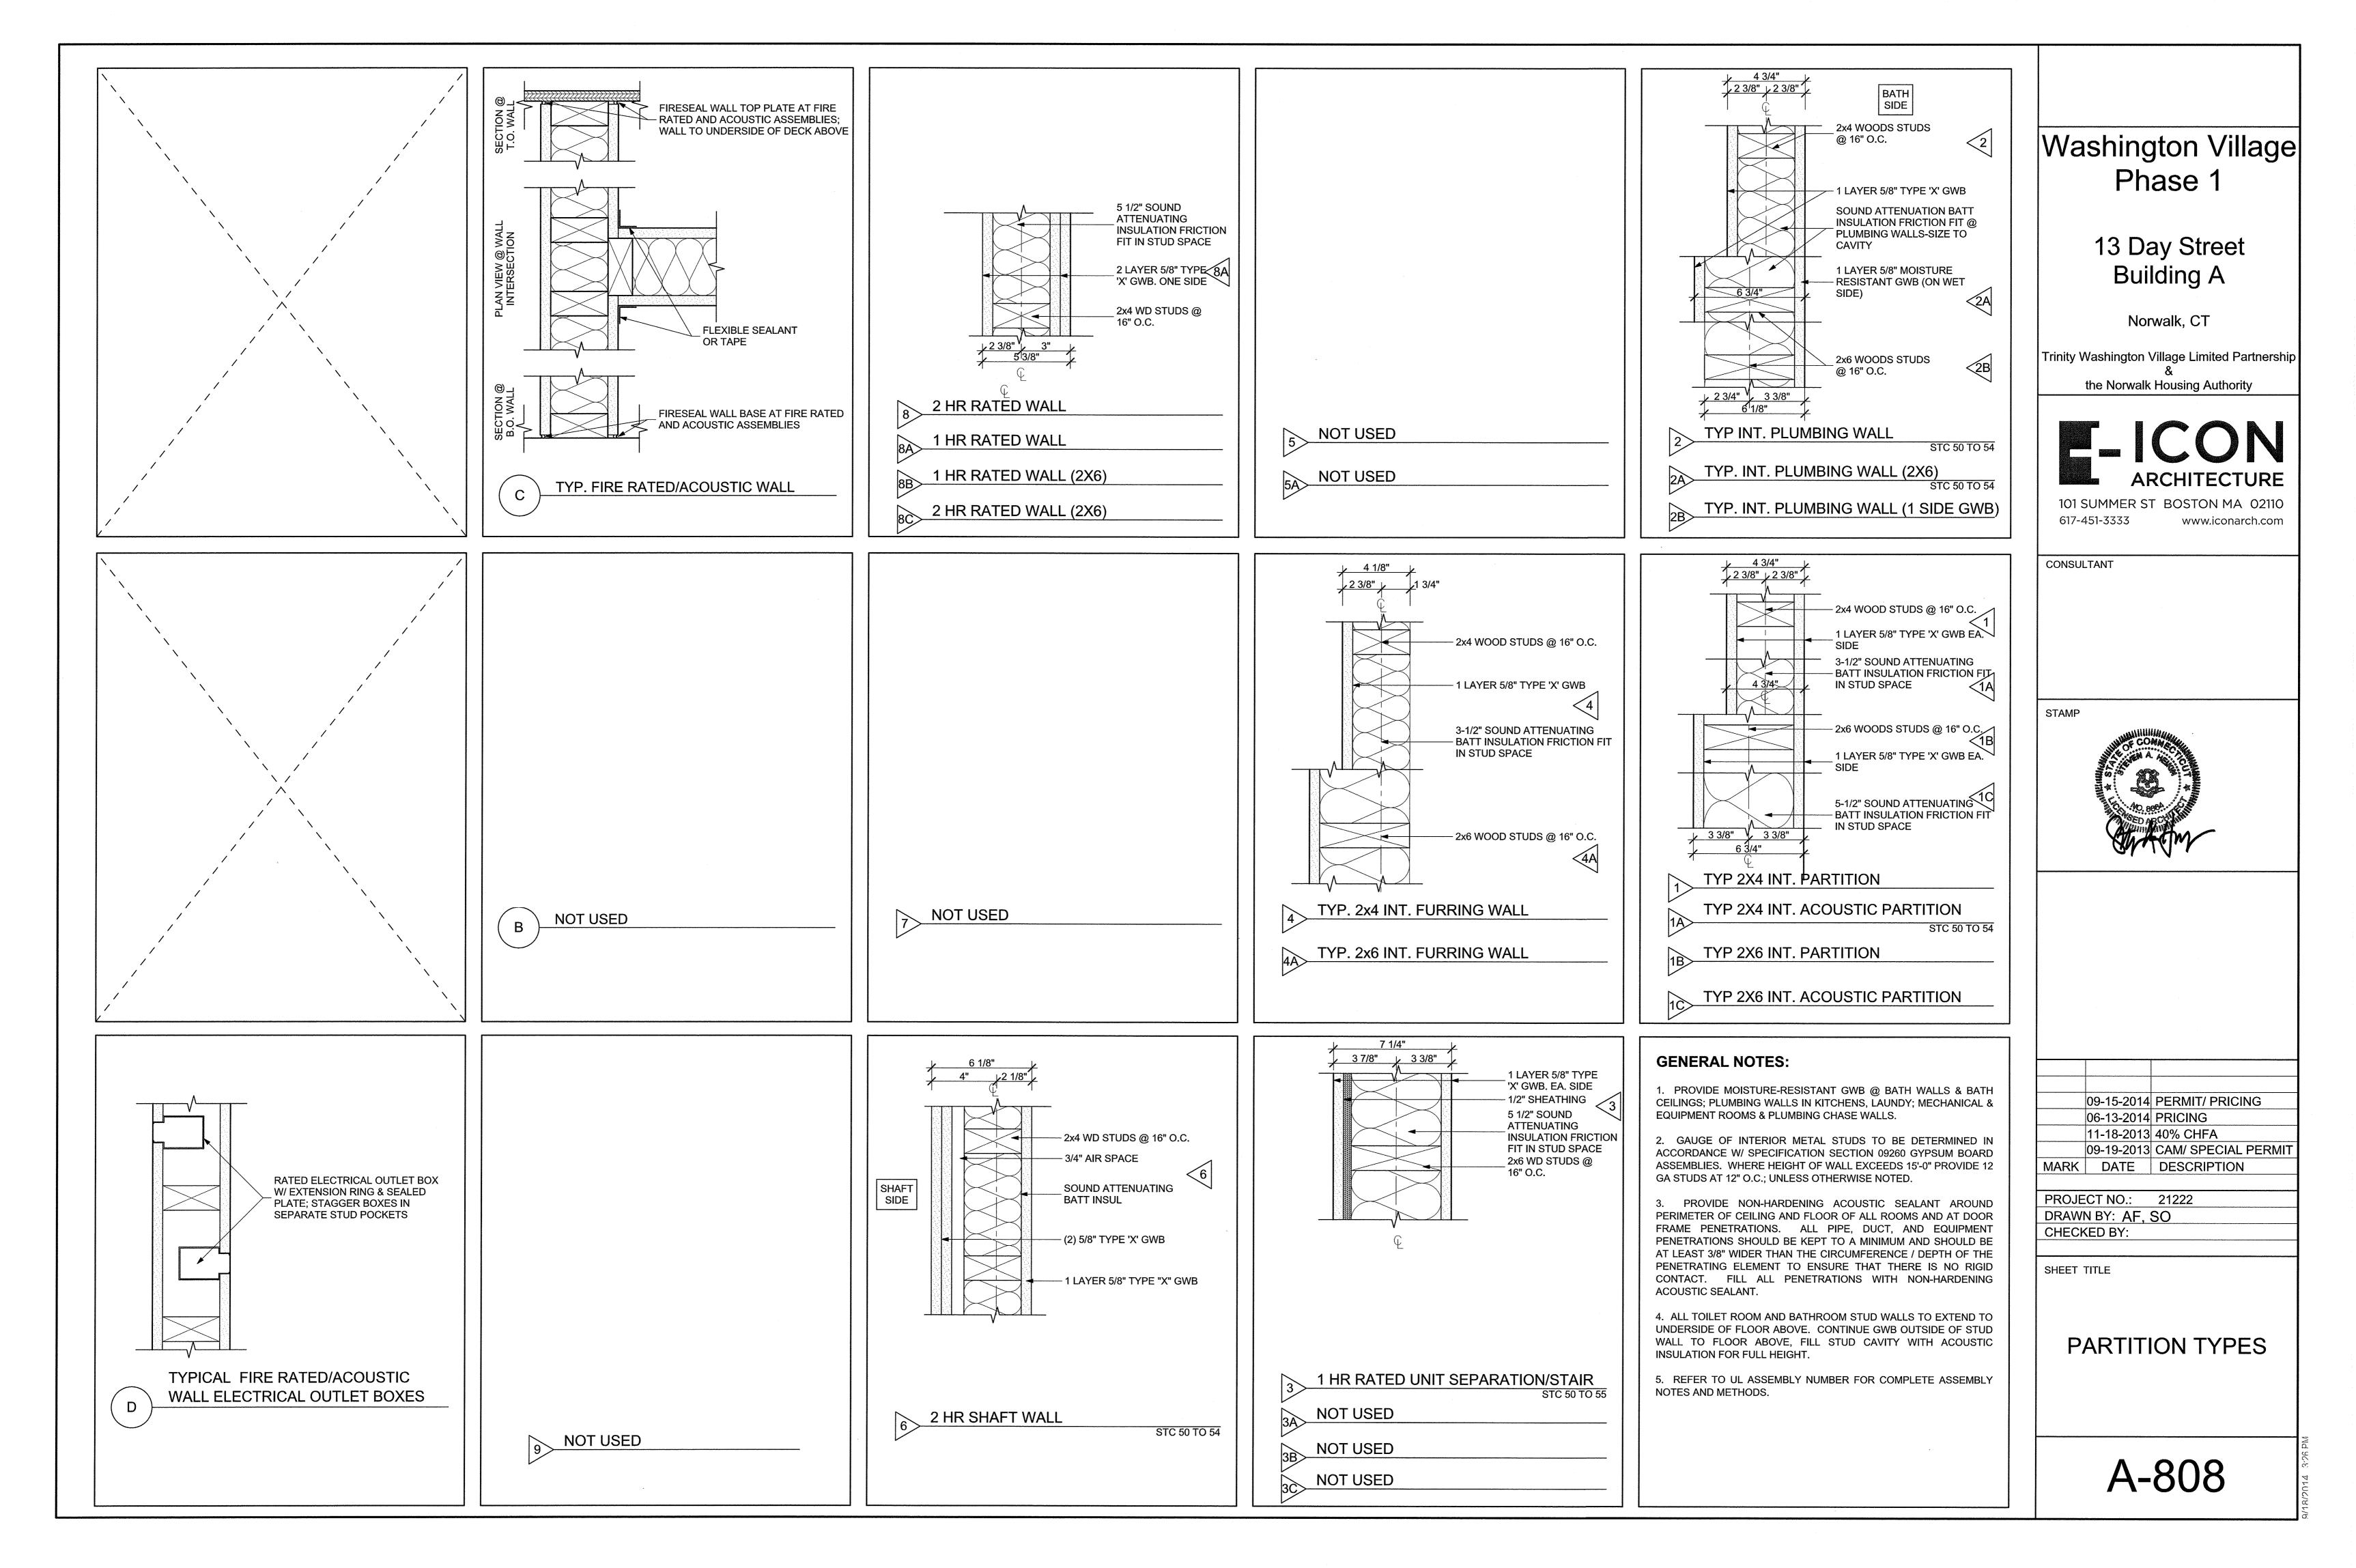
09-15-2014 PERMIT/ PRICING 06-13-2014 PRICING 11-18-2013 40% CHFA

09-19-2013 CAM/ SPECIAL PERMIT
MARK DATE DESCRIPTION

PROJECT NO.: 21222
DRAWN BY: RA
CHECKED BY: KH

SHEET TITLE

FINISH SCHEDULE



### GENERAL

- 2005 STATE OF CONNECTICUT STATE BUILDING CODE AND SUPPLEMENT. 2. THE CONTRACTOR SHALL PROVIDE ALL NECESSARY SHORING AND BRACING TO MAINTAIN THE STABILITY, SAFETY, AND LATERAL LOAD RESISTANCE OF THE BUILDING AND ITS INDIVIDUAL COMPONENTS THROUGHOUT CONSTRUCTION.
- DIMENSIONS AND DETAILS SHALL BE CHECKED AGAINST ARCHITECTURAL 4. THE CONTRACTOR SHALL VERIFY AND COORDINATE THE SIZE AND LOCATION OF ALL OPENINGS, SLEEVES AND ANCHOR BOLTS AS REQUIRED BY ALL TRADES. OPENINGS NOT SPECIFICALLY SHOWN SHALL BE APPROVED BY THE ARCHITECT
- 5. FOR RENOVATIONS AND ADDITIONS, THE CONTRACTOR SHALL VERIFY ALL DIMENSIONS AND EXISTING CONDITIONS AND NOTIFY THE STRUCTURAL
- ENGINEER OF ANY DISCREPANCIES PRIOR TO PERFORMING WORK. 6. DIMENSIONS SHOWN ON THE STRUCTURAL DRAWINGS ARE GENERALLY OBTAINED FROM THE ARCHITECT AND ARE INCLUDED AS INFORMATION COMPLEMENTARY TO THE ARCHITECTURAL DRAWINGS. LAYOUT OF BUILDING FOUNDATIONS OR OTHER ITEMS MAY BY MADE USING THE DIMENSIONS SHOWN ON THE STRUCTURAL DRAWINGS ONLY IF THE CONTRACTOR HAS COMPARED THESE DRAWINGS WITH THE ARCHITECTURAL DRAWING AND HAS RECEIVED CLARIFICATION, FROM THE ARCHITECT, REGARDING ANY ERRORS, INCONSISTENCIES, OR OMISSIONS.
- DO NOT SCALE DRAWINGS TO OBTAIN INFORMATION. SEE ARCHITECTURAL DRAWINGS AND SPECIFICATIONS FOR WATER/DAMP-

### **BUILDING DESIGN LOADS**

DESIGN LIVE LOADS	
ONE & TWO FAMILY DWELLING:	40PSF
ONE & TWO FAMILY DWELLING-STAIRS:	40PSF
ONE & TWO FAMILY DWELLING-SLEEPING AREAS:	30PSF

PROOFING AND FIREPROOFING REQUIREMENTS.

### SNOW LOADS **GROUND SNOW LOAD:** IMPORTANCE FACTOR: ls = 1.0FLAT ROOF SNOW LOAD: Pf = 30PSF SNOW EXPOSURE FACTOR: Ce = 0.9

THERMAL FACTOR:	Ct = 1.1
WIND LOADS	
BASIC WIND SPEED (3 SEC GUST):	110 MPH
WIND EXPOSURE CATEGORY:	С
WIND IMPORTANCE FACTOR:	lw= 1.0
INTERNAL PRESSURE COEFFICIENT:	Gcpi = +/-0.18
C&C WIND PRESSURE	ASCE 7 CH 6

SEISMIC LOADS SPECTRAL RESPONSE ACCELERATION	
AT SHORT PERIODS:	Ss=0.3
SPECTRAL RESPONSE ACCELERATION	
AT ONE-SECOND PERIODS:	S1=0.066
SPECTRAL RESPONSE COEFFICIENT	
AT SHORT PERIODS:	Sds=0.312
SPECTRAL RESPONSE COEFFICIENT	014 0400
AT ONE-SECOND PERIODS:	Sd1=0.106
SEISMIC DESIGN CATEGORY:	В
SITE CLASS:	D
ANALYSIS PROCEDURE:	

### LATERAL LOAD RESISTING SYSTEMS:

**EQUIVALENT LATERAL FORCE METHOD** 

BEARING WALL SYSTEM - LIGHT FRAME STRUCTURAL PANELS.	WALLS WITH SHEAR PANELS - WOOD
RESPONSE MODIFICATION FACTOR:	R=6.5

SEISMIC RESPONSE COEFFICIENT:	Cs=0.048
DESIGN BASE SHEAR:	V=0.048V

FOUNDATIONS HAVE BEEN DESIGNED IN ACCORDANCE WITH THE RECOMMENDATIONS SET FORTH IN THE "GEOTECHNICAL ENGINEERING INVESTIGATION - PROJECT ......" DATED ..../....... PREPARED BY GIBBLE NORDEN CHAMPION BROWN CONSULTING ENGINEERS, INC., OLD SAYBROOK, CT. 1. ALL FOOTINGS SHALL BEAR ON UNDISTURBED NATURAL MATERIAL OR CONTROLLED STRUCTURAL FILL HAVING AN ALLOWABLE BEARING VALUE OF 2 TONS PER SQUARE FOOT TOTAL LOAD PRESSURE AND SHALL BEAR LEAST 3'-6"

BELOW FINISH GRADE WHERE EXPOSED TO FREEZING. ELEVATIONS OF THE BOTTOM OF FOOTING SHOWN ON PLANS ARE FOR BIDDING PURPOSES AND SHALL BE LOWERED IF NECESSARY TO THE REQUIRED BEARING MATERIAL AS FOUND UPON EXCAVATION. IF THE REQUIRED BEARING MATERIAL IS NOT ENCOUNTERED AT ELEVATIONS SHOWN, NOTIFY ENGINEER IMMEDIATELY.

FOR SLAB ON GRADE AREAS WITHIN BUILDING PERIMETER, REMOVE ALL SURFACE TOPSOIL, PAVEMENT, AND OTHER UNSUITABLE MATERIALS, EXISTING GRANULAR MATERIAL MAY BE LEFT IN PLACE PROVIDED IT IS RECOMPACTED WITH A MINIMUM OF SIX PASSES OF 10 TON VIBRATORY ROLLER. ANY REMAINING FILL REQUIRED TO UNDERSIDE OF SLAB SHALL BE COMPACTED STRUCTURAL FILL. 4. FOUNDATION WALLS SHALL BE TEMPORARILY BRACED UNTIL FRAMED SLABS AND

SLAB ON GRADE BRACING THESE WALLS LATERALLY AGAINST EARTH PRESSURE, WIND AND OTHER LATERAL FORCES ARE IN PLACE. 5. STEP FOOTINGS AS REQUIRED TO PASS UNDER MECHANICAL PIPING. PROVIDE

SLEEVES FOR ALL PENETRATIONS IN FOUNDATION WALL. SEE GEOTECHNICAL DRAWINGS FOR ADDITIONAL REQUIREMENTS.

### REINFORCED CONCRETE

1. ALL CONCRETE IS DESIGNED BY ULTIMATE STRENGTH METHODS PER ACI 318 AND SHALL BE NORMAL WEIGHT (UNLESS INDICATED AS LIGHT WEIGHT ON PLANS) AIR ENTRAINED WITH A 28 DAY COMPRESSIVE STRENGTH AS FOLLOWS:

WALLS AND FOUNDATIONS	3000 PSI
INTERIOR SLABS ON GRADE	3500 PSI
EXTERIOR SLABS ON GRADE	4500 F
BEAMS, COLUMNS, STRUCTURAL SLABS	4000 F
COMPOSITE CONCRETE SLABS	3000 PSI

- 2. ALL REINFORCING BARS SHALL BE HIGH STRENGTH DEFORMED BARS ASTM A 615 -
- 3. REINFORCING BARS FOR WELDING TO STRUCTURAL STEEL SHALL BE ASTM A706 WELDABLE REINFORCING.
- 4. DETAIL ALL BARS IN ACCORDANCE WITH "ACI DETAILING MANUAL 1988." SHOW ON THE PLACING DRAWINGS THE NUMBER AND LOCATION OF ALL BAR SUPPORTS AND ACCESSORIES NECESSARY TO SUPPORT REINFORCEMENT IN POSITIONS
- 5. MINIMUM CONCRETE PROTECTION FOR REINFORCEMENT WHEN NOT OTHERWISE INDICATED SHALL BE:

CONCRETE POURED AGAINST EARTH:	3"
CONCRETE POURED IN FORMS BUT EXPOSED TO EARTH OF WEATHER: BARS #5 AND SMALLER BARS LARGER THAN #5	1 - 1/2" 2"
COLUMNS BEAMS AND GIRDERS:	1 - 1/2"
SLABS, WALLS NOT EXPOSED TO	3/4"

6. NO SPLICES OF REINFORCEMENT SHALL BE MADE EXCEPT AS DETAILED OR APPROVED BY THE STRUCTURAL ENGINEER. REBAR DEVELOPMENT / SPLICE LENGTH SHALL BE AS SHOWN BELOW UNLESS OTHERWISE NOTED. VALUES SHOWN ARE IN INCHES. MAKE ALL BARS CONTINUOUS AROUND CORNERS.

	BEAMS			SLABS	MATS	
BAR SIZE	BOTTOM BARS	OTHER BARS		THICKNESS 12" OR	THICK GREATE	R THAN
#3	20	25	BAR SIZE	LESS	12	2"
#4	25	33	SIZE	ALL	воттом	OTHER
#5	32	41		BARS	BARS	BARS
#6	38	49	#3	20	20	25
#7	55	71	#4	25	25	33
#8	63	81	#5	32	32	41
#9	71	91	#6	38	38	49
#10	80	103	#7	82	82	106
#11	88	114	#8	94	94	121
			#9	109	109	137
			#10	119	119	154
			#11	132	132	171

		COLUMNS				
BAR	VERTIC	AL BARS	HORIZON'	TAL BARS	BAR	VERTICAL
SIZE	CASE 1	CASE 2	CASE 1	CASE 2	SIZE	BARS
#3	20	29	25	36	#3	20
#4	25	38	33	50	#4	25
#5	32	47	41	61	#5	32
#6	38	57	49	73	#6	38
#7	55	82	71	106	#7	55
#8	63	94	81	121	#8	63
#9	71	106	91	137	#9	71
#10	80	119	103	154	#10	80
#11	88	132	114	171	#11	88

### TABLES ARE BASED ON THE FOLLOWING:

- 1 f'c = 4 KSI2. MINIMUM CLEAR COVER AS SHOWN ABOVE.
- 3. MINIMUM CLEAR SPACING OF 3" BETWEEN ANY BARS.
- 4. fy = 60 KSI5. NORMAL WEIGHT CONCRETE.
- 6. TABULATED VALUES REPRESENT CLASS B CONDITIONS. ALL SPLICES TO BE CLASS B U.N.O.
- 7. FOR WALLS: CASE 1 = CLEAR SPACING≥ 2db AND CLEAR COVER ≥ db
- CASE 2 = OTHER THAN CASE 1
- FOR f'c = 3 KSI DEVELOPMENT LENGTH = 1.15 x TABLE VALUE f'c = 5 KSI DEVELOPMENT LENGTH = 0.89 x TABLE VALUE
- 7. FOR LIGHTWEIGHT AGGREGATE CONCRETE, MULTIPLY THE TABULATED VALUES
- 8. FOR EPOXY-COATED BARS, MULTIPLY THE TABULATED VALUES BY 1.5.
- 9. COMBINED EFFECTS DUE TO CONCRETE STRENGTH, CONCRETE WEIGHT, AND EPOXY BARS ARE CUMULATIVE. DEVELOPMENT LENGTH VALUES SHOVSHALL

BE MULTIPLIED BY EACH FACTOR TO FIND THE CORRECT VALUE. 10. SLABS, BEAMS AND WALLS SHALL HAVE NO JOINTS IN A HORIZONTAL PLANANY STOP IN CONCRETE WORK MUST BE MADE AT CENTER OF SPAN OR AT CENTER OF SUPPORT WITH VERTICAL BULKHEADS, HORIZONTAL KEYS ANDREINFORCING CONTINUING THROUGH. ALL CONSTRUCTION JOINTS SHALL BE AS DETAILED OR AS APPROVED BY THE STRUCTURAL ENGINEER.

11. WIRE MESH REINFORCEMENT MUST LAP ONE FULL MESH AT SIDE AND END LAPS, AND SHALL BE WIRED TOGETHER. PROVIDE ADEQUATE SUPPORTS FOR MESH TO INSURE ITS LOCATION AS SHOWN ON DRAWINGS.

12. CONDUITS AND PIPES SHALL BE PLACED ABOVE BOTTOM BARS AND BETOPV BARS AND SHALL NOT EXCEED 1/3 THE CONCRETE THICKNESS AT ANY CROSS SECTION. PARALLEL RUNS SHALL BE SPACED A MINIMUM OF 3 DIAMETERSON CENTER. NO ALUMINUM OR COATED CONDUIT PIPE SHALL BE USED.

### POST-INSTALLED FASTENERS AND ANCHORS

- 1. ALL HOLES INTO MASONRY OR CONCRETE WALLS FOR PROPRIETARY ANCHORING SYSTEMS SHALL BE DRILLED AND CLEANED IN STRICT ACCORDANCE WITH THE MANUFACTURER'S RECOMMENDATIONS.
- 2. ALL PROPRIETARY ANCHORING SYSTEMS SHALL BE INSTALLED IN STRICT ACCORDANCE WITH THE MANUFACTURER'S REQUIREMENTS AND USING ALL RECOMMENDED ACCESSORIES AND SUPPLEMENTAL COMPONENTS SUCH AS SCREEN TUBES, WASHERS, ETC.
- 3. ALL HOLES IN HOLLOW MASONRY SHALL BE DRILLED WITH ROTARY DRILLS. HAMMER DRILLS ARE NOT PERMITTED.
- ALL EPOXY ADHESIVE SHALL BE HILTI RE-500. SIMPSON ET OR APPROVED EQUAL. U.N.O. 5. ALL ACRYLIC ADHESIVE SHALL BE HILTI HIT (ICE, HY150 OR HY20), SIMPSON AT OR
- APPROVED EQUAL. U.N.O. 6. ALL THREADED CONCRETE/MASONRY ANCHORS SHALL BE HILTI HUS-H, SIMPSON
- TITEN, ITW TAP-CON OR APPROVED EQUAL. U.N.O. 7. ALL EXPANSION ANCHORS SHALL BE HILTI KWIK-BOLT 3, SIMPSON WEDGE-ALL OR
- APPROVED EQUAL, U.N.O.

1. ALL FRAMING LUMBER SHALL BE DRY (19% MAXIMUM MOISTURE CONTENT) SPF U.N.O. PRESSURE TREATED SOUTHERN PINE SHALL BE USED FOR GROUND CONTACT, SILL PLATES, OR EXTERIOR USE.

STUDS SHALL BE STUD GRADE OR BETTER

ALL OTHER MEMBERS SHALL BE NO. 2 OR BETTER.

FOR EXPOSED FRAMING SEE ARCHITECTURAL DRAWINGS FOR ADDITIONAL REQUIREMENTS.

- 2. PROVIDE 1" x 4" CROSS-BRIDGING FOR ALL WOOD JOISTS AT 8'-0" O.C. MAXIMUM SPACING AND 2x SOLID BLOCKING BETWEEN JOISTS AT ALL SUPPORTS AND
- 3. WHERE FRAMING CLIPS OR JOISTS HANGERS ARE USED, NAILING SHALL BE AS
- PER MANUFACTURER'S RECOMMENDATIONS. 4. ALL OPENINGS SHALL BE FRAMED WITH DOUBLE MEMBERS UNLESS
- OTHERWISE NOTED ON PLANS.
- 5. TRUSSES SHALL BE DESIGNED AND CONSTRUCTED ACCORDING TO TRUSS PLATE INSTITUTE, TPI, SPECIFICATIONS AND SHALL BE INSTALLED AS PER MANUFACTURER'S RECOMMENDATIONS, IF FIRE RETARDANT LUMBER IS USED FOR TRUSS MEMBERS, CHEMICALS USED SHALL BE COMPATIBLE AND NON-
- CORROSIVE TO GALVANIZED CONNECTOR PLATES. 6. TRUSS MANUFACTURER SHALL RETAIN A LICENSED SPECIALTY ENGINEER OF RECORD TO PROVIDE SIGNED AND SEALED CALCULATIONS OF TRUSS DESIGNS. CALCULATIONS SHALL INCLUDE LOADS AND LOCATIONS OF ANY TEMPORARY AND OR PERMANENT BRACING REQUIRED.
- METAL CONNECTOR HARDWARE SHOWN ON PLANS AND DETAILS ARE SIMPSON. STRONG-TIE CONNECTORS AND ARE SELECTED FOR LOAD REQUIREMENTS. SUBSTITUTION IS PERMITTED IF LOAD CAPACITIES OF ALTERNATE ARE OF EQUAL OR GREATER CAPACITY THAN COMPARABLE SIMPSON CONNECTOR. FASTENING SHALL BE PER MANUFACTURER'S REQUIREMENTS.

### **ENGINEERED WOOD**

1. ALL ENGINEERED LUMBER SHALL HAVE THE FOLLOWING MINIMUM DESIGN PROPERTIES:

ENGINEERED WOOD PROPERTIES								
	Fb (psi)	Fc PARR (psi)	Fc PERP (psi)	Fv (psi)	E (psi)			
LVL	2600	2510	750	285	1.9e6			
PSL	2400	2500	_	-	1.8e6			

NAILING SCHEDULE								
CONNECTION	NAILING							
JOIST TO SILL OR GIRDER, TOE NAIL	3-8d							
WOOD I-JOIST TO WALL PLATE	2-10d							
BRIDGING TO JOIST, TOE NAIL EACH END	2-8d							
SOLE PLATE TO JOIST OR BLOCKING, FACE NAIL	16d @ 16" o.c.							
TOP OR SOLE PLATE TO STUD, END NAIL								
2x4	2-16d							
2x6	3-16d							
2x8	4-16d							
STUD TO SOLE PLATE, TOE NAIL								
2x4	4-8d							
2x6, 2x8	5-10d							
DOUBLED STUDS, FACE NAIL	16d @ 24" o.c.							
DOUBLED TOP PLATES, FACE NAILED	16d @ 16" o.c.							
TOP PLATES, LAPS AND INTERSECTIONS, FACE NAIL	2-16d							
CONTINUOUS HEADER, TWO PIECES	16d @ 16" o.c. ALONG EACH EDGE							
CONTINUOUS HEADER TO STUD, TOE NAIL	4-8d							
CEILING JOIST TO PLATE, TOE NAIL	3-8d							
CEILING JOIST, LAPS OVER PARTITIONS, FACE NAIL	3-16d							
CEILING JOIST TO PARALLEL RAFTERS, FACE NAIL	3-16d							
RAFTER TO PLATE, TOE NAIL	3-8d							
BUILT-UP CORNER STUDS	16d @ 24" o.c.							
BUILT-UP GIRDERS AND BEAMS	20d @ 32" o.c. AT TOP AND BOTTOM AND STAGGERED 2-20d AT ENDS AND AT EACH SPLICE							
PLYWOOD SUBFLOOR, ROOF, AND WALL SHEATHING TO FRAMING								
1/2"	8d							

NAILING SCHEDULE IS BASED ON COMMON WIRE NAILS. LARGER NAIL SIZES ARE REQUIRED FOR BOX OR PNEUMATIC DRIVEN SUBSTITUTING PNEUMATIC NAILS OF EQUAL DIAMETER IS ACCEPTABLE.

**COMMON WIRE NAIL DIAMETERS:** 6d = 0.113" 12d = 0.148" 8d = 0.131" 16d = 0.162" 20d = 0.192"10d = 0.148"

5/8" - 3/4"

# Washington Village Phase 1

## 13 Day Street Building A

Norwalk, CT

Trinity Washington Village Limited Partnership

the Norwalk Housing Authority



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10d



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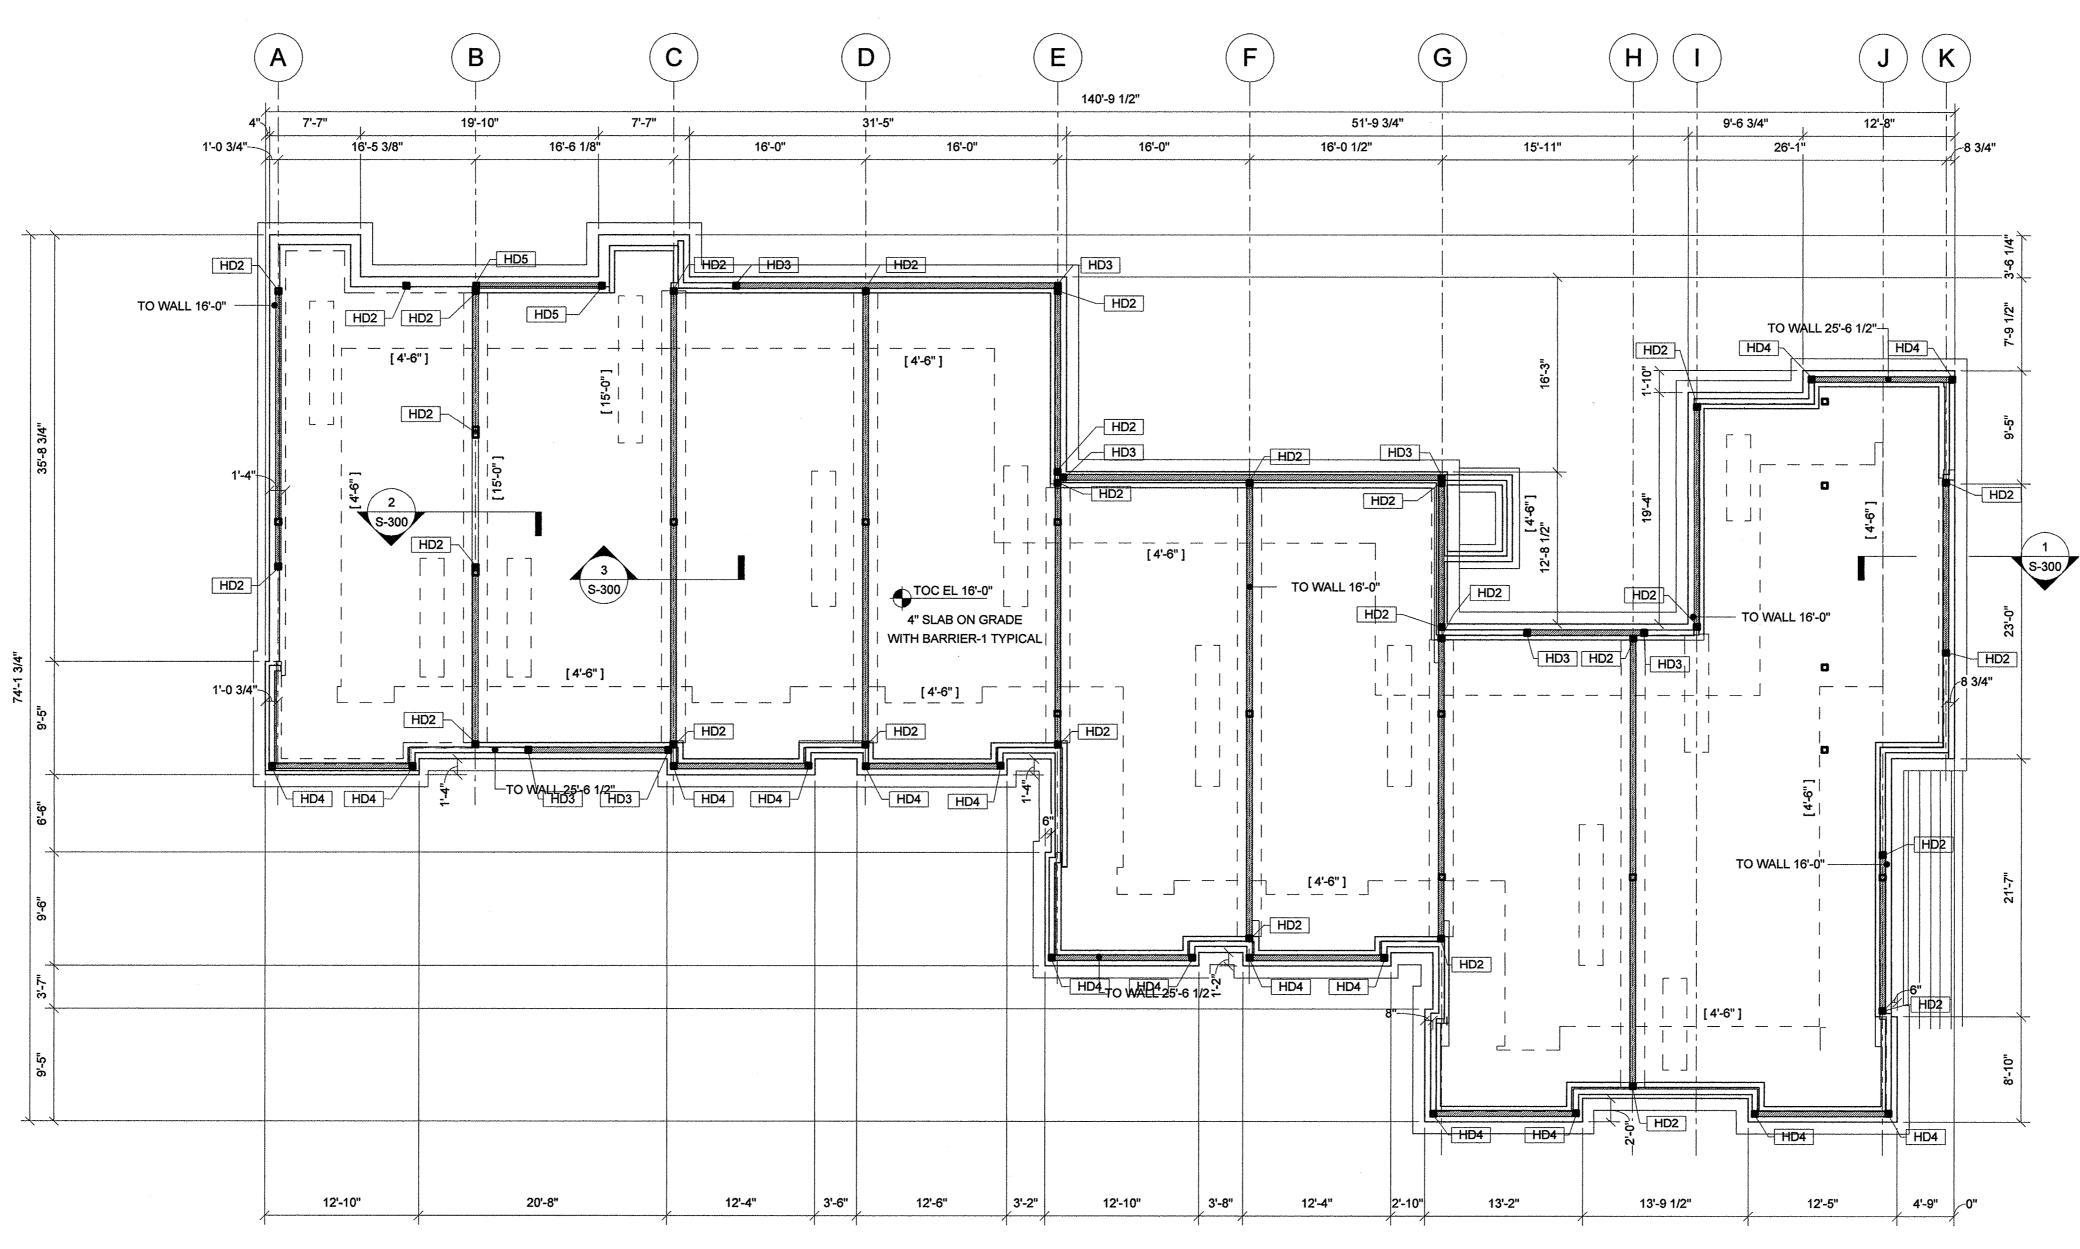
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**GENERAL NOTES** 



1/8" = 1'-0"

### SHEAR WALL NOTES:

 DENOTES SHEAR WALL.
 ALL EXTERIOR SHEAR WALLS TO BE SHEATHED WITH 5/8" PLYWOOD ON ONE SIDE WITH 10d NAILS AT 4"oc AT EDGES AND 12"oc IN FIELD U.N.O. 3. ALL INTERIOR SHEAR WALLS (DEMISING WALLS BETWEEN UNITS) TO BE SHEATHED WITH MIN 1/2" PLYWOOD ON ONE SIDE WITH 10d NAILS AT 4"oc AT EDGES AND 12"oc IN FIELD U.N.O.

4. ALL NAILS ARE ASSUMED TO BE COMMON WIRE NAILS. 5. PROVIDE 1'-0" MIN LAP ONTO WALL STUDS ABOVE FLOOR FRAMING TYPICAL. NO HORIZONTAL PANEL JOINTS AT FLOOR FRAMING. 6. PROVIDE SOLID BLOCKING AT ALL SHEATHING PANEL EDGES TYPICAL. DIMENSIONS SIZE TO MATCH WALL FRAMING.

7. WHERE SHEATHING IS INSTALLED ON BOTH FACES OF WALL, OFFSET VERTICAL PANEL EDGES TO FALL ON DIFFERENT FRAMING MEMBERS. 8. SHEATHING MAY BE INSTALLED HORIZONTAL OR VERTICAL U.N.O. 9. HDx DENOTES HOLD-DOWN LOCATION. SEE SHEET S-001 FOR HOLD-DOWN

### HOLD-DOWN SCHEDULE COMPRESSION LABEL MODEL **MEMBER ANCHOR** HD1 MTSA24 N/A 2-2X6 HDU2-SDS2.5 5/8" DIA 2-2X6 HD3 5/8" DIA 2-2X6 HDS5-SDS2.5 3-2X6 HDS8-SDS2.5 7/8" DIA HDS11-SDS2.5 1" DIA 6X8

HOLD-DOWN NOTES:

1. SIMPSON HARDWARE REFERENCED.

2. SEE S-100 SERIES DWGS FOR HOLD-DOWN LOCATIONS. 3. FASTEN PER MANUFACTURER'S REQUIREMENTS.

FOUNDATION NOTES:

1. SEE S-001 FOR GENERAL NOTES.

2. SEE S-200 SERIES DRAWINGS FOR TYPICAL DETAILS. 3. [xx.xx] DENOTES BOTTOM OF FOOTING ELEVATION.

# Washington Village Phase 1

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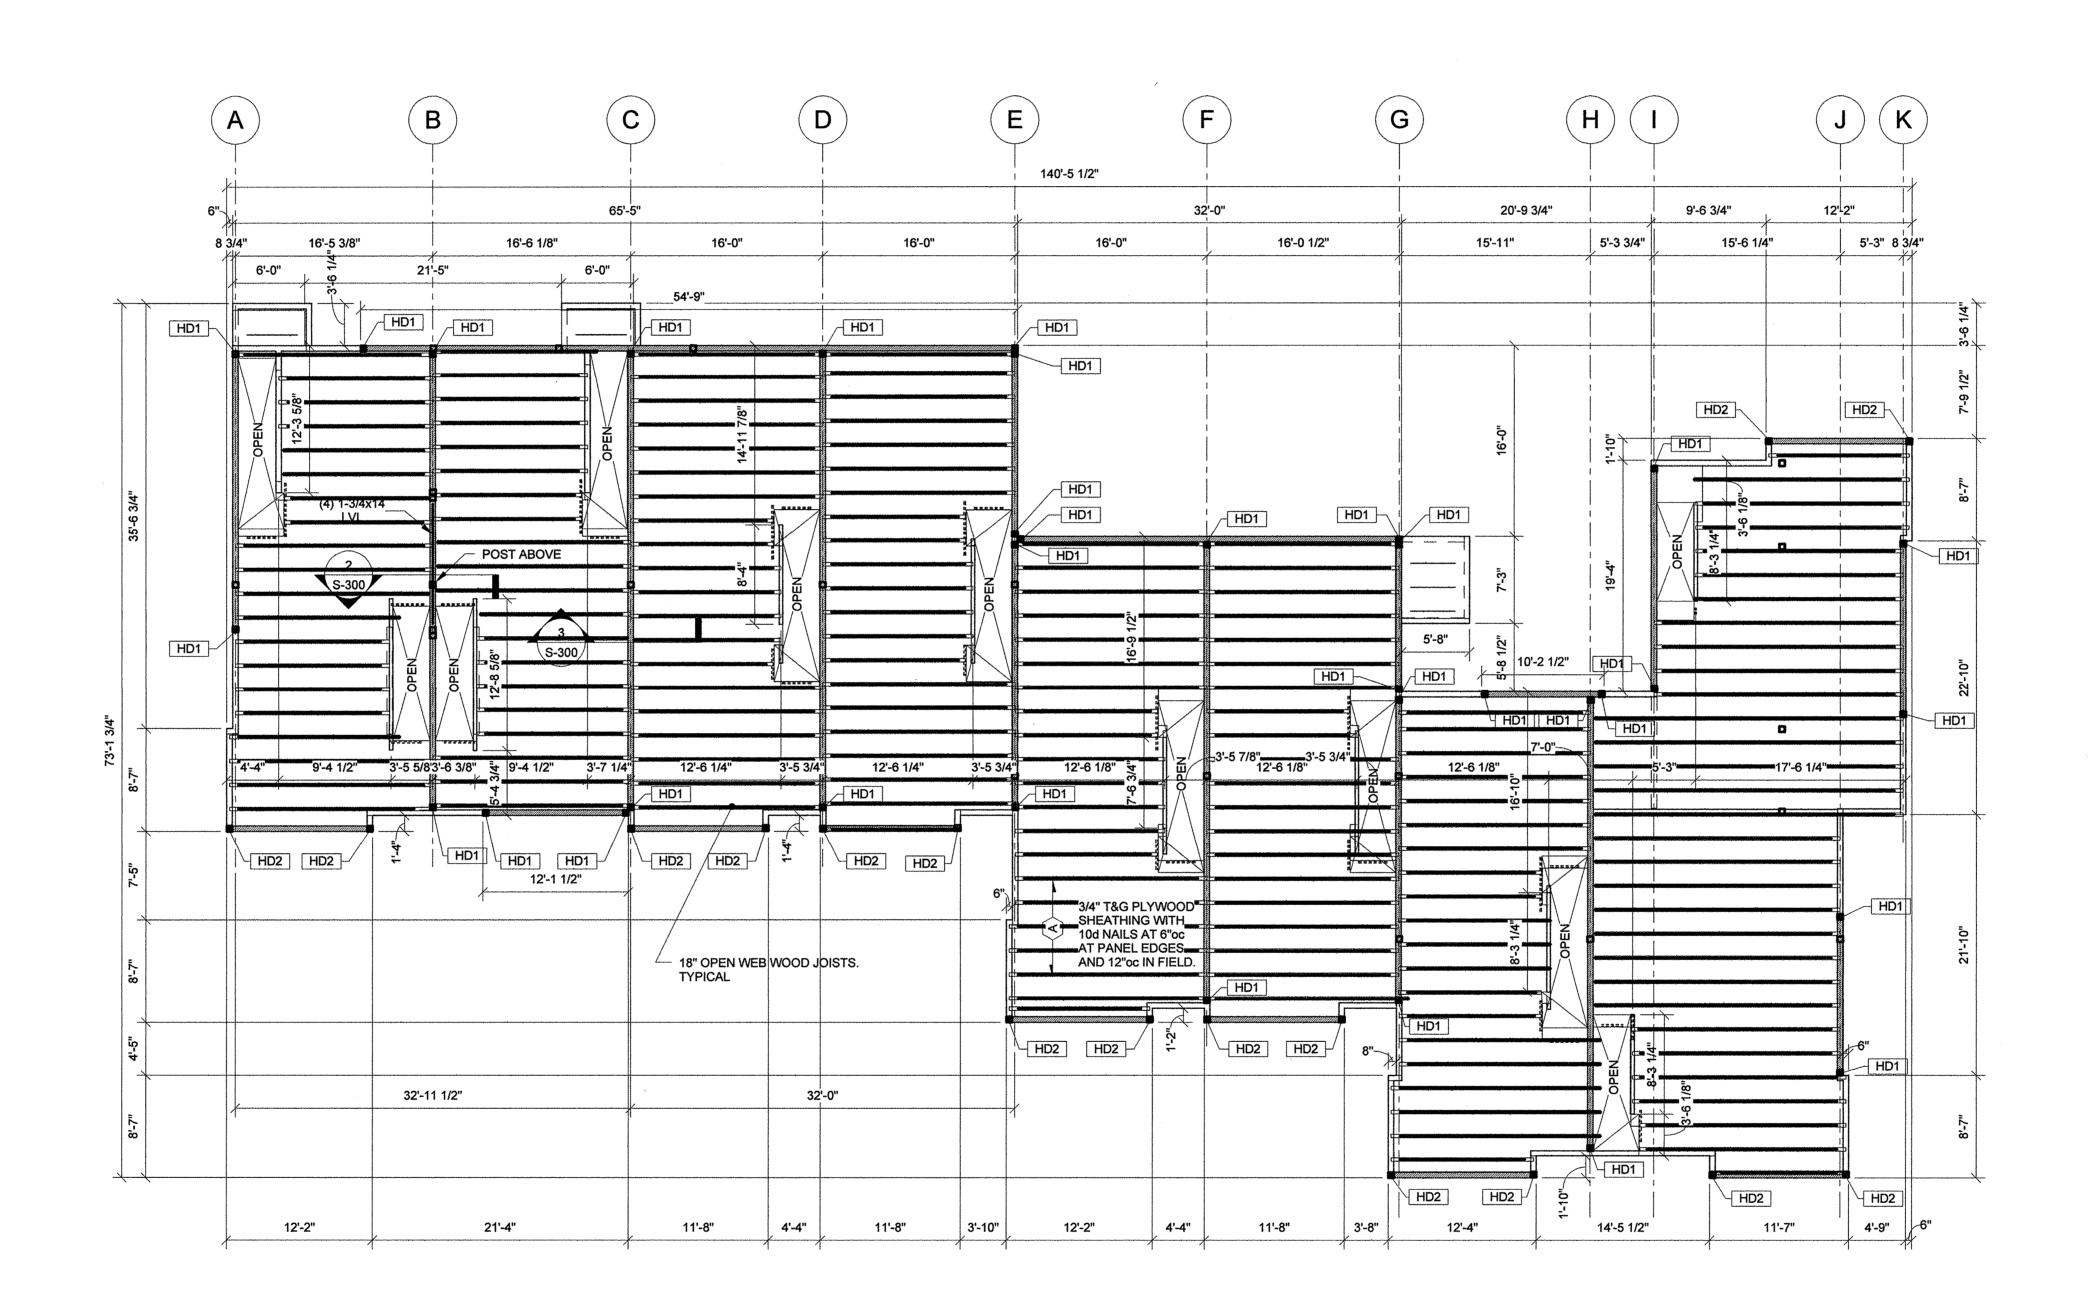
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FOUNDATION / FIRST **FLOOR PLAN** 



SECOND FLOOR

SHEAR WALL NOTES:

1. DENOTES SHEAR WALL. 2. ALL EXTERIOR SHEAR WALLS TO BE SHEATHED WITH 5/8" PLYWOOD ON ONE SIDE WITH 10d NAILS AT 4"oc AT EDGES AND 12"oc IN FIELD U.N.O. 3. ALL INTERIOR SHEAR WALLS (DEMISING WALLS BETWEEN UNITS) TO BE SHEATHED WITH MIN 1/2" PLYWOOD ON ONE SIDE WITH 10d NAILS AT 4"oc AT EDGES AND 12"oc IN FIELD U.N.O. 4. ALL NAILS ARE ASSUMED TO BE COMMON WIRE NAILS.
5. PROVIDE 1'-0" MIN LAP ONTO WALL STUDS ABOVE FLOOR FRAMING TYPICAL. NO HORIZONTAL PANEL JOINTS AT FLOOR FRAMING. 6. PROVIDE SOLID BLOCKING AT ALL SHEATHING PANEL EDGES TYPICAL. DIMENSIONS SIZE TO MATCH WALL FRAMING. 7. WHERE SHEATHING IS INSTALLED ON BOTH FACES OF WALL, OFFSET VERTICAL PANEL EDGES TO FALL ON DIFFERENT FRAMING MEMBERS. 8. SHEATHING MAY BE INSTALLED HORIZONTAL OR VERTICAL U.N.O.
9. HDx DENOTES HOLD-DOWN LOCATION. SEE SHEET S-001 FOR HOLD-DOWN

HOLD-DOWN SCHEDULE									
LABEL	MODEL	HD ANCHOR	COMPRESSION MEMBER						
HD1	MTSA24	N/A	2-2X6						
HD2	HDU2-SDS2.5	5/8" DIA	2-2X6						
HD3	HDS5-SDS2.5	5/8" DIA	2-2X6						
HD4	HDS8-SDS2.5	7/8" DIA	3-2X6						
HD5	HDS11-SDS2.5	1" DIA	6X8						

HOLD-DOWN NOTES:

1. SIMPSON HARDWARE REFERENCED. 2. SEE S-100 SERIES DWGS FOR HOLD-DOWN LOCATIONS. 3. FASTEN PER MANUFACTURER'S REQUIREMENTS.

# Washington Village Phase 1

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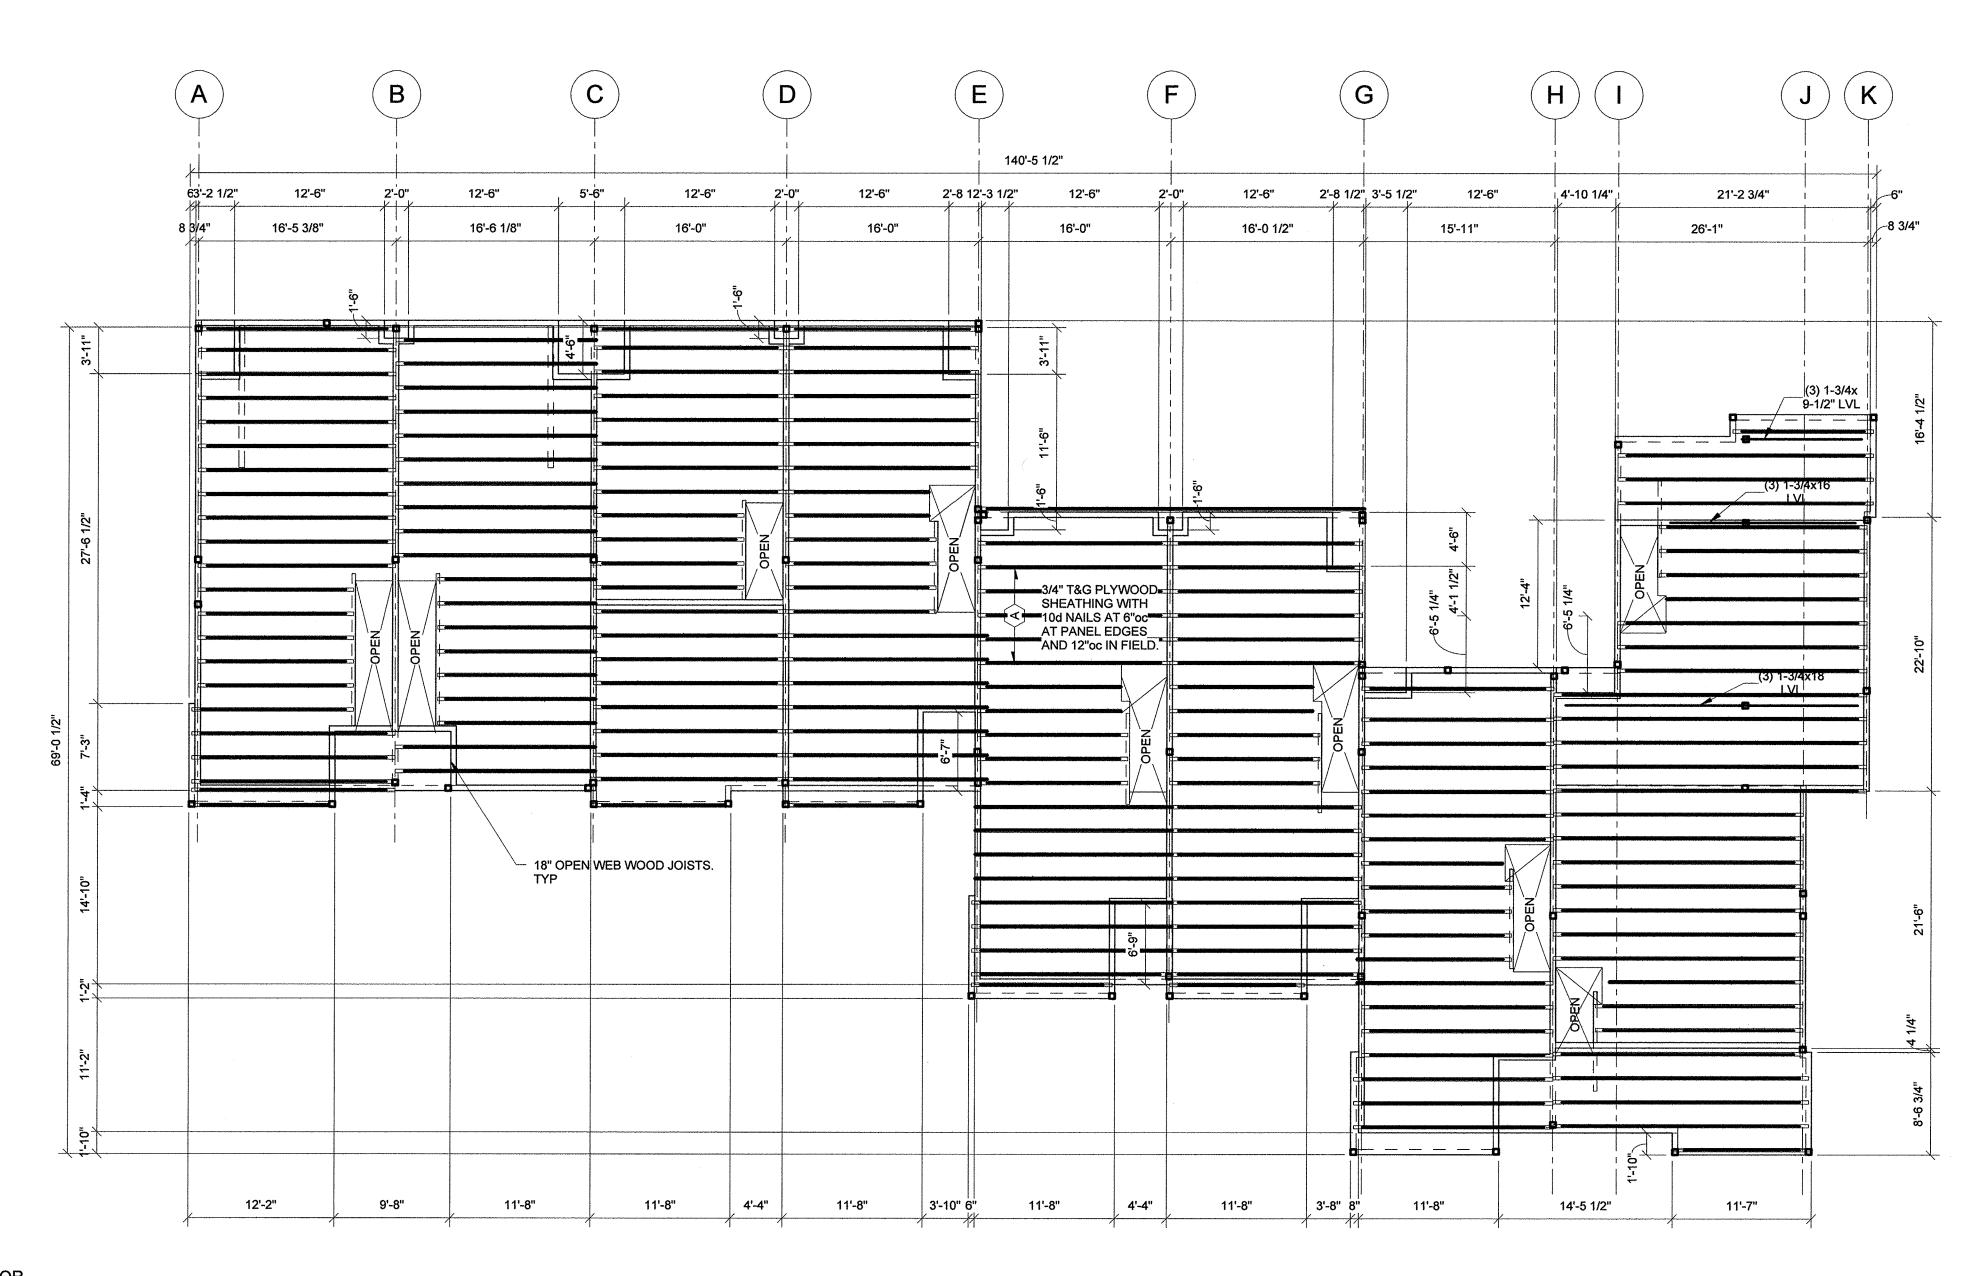
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PLAN NOTES: 1. SEE S-001 FOR GENERAL NOTES.

2. SEE S-200 SERIES DRAWING FOR TYPICAL DETAILS.

SECOND FLOOR FRAMING PLAN



1 THIRD FLOOR
1/8" = 1'-0"

<u>PLAN NOTES</u>: 1. SEE S-001 FOR GENERAL NOTES. 2. SEE S-200 SERIES DRAWING FOR TYPICAL DETAILS.

# Washington Village Phase 1

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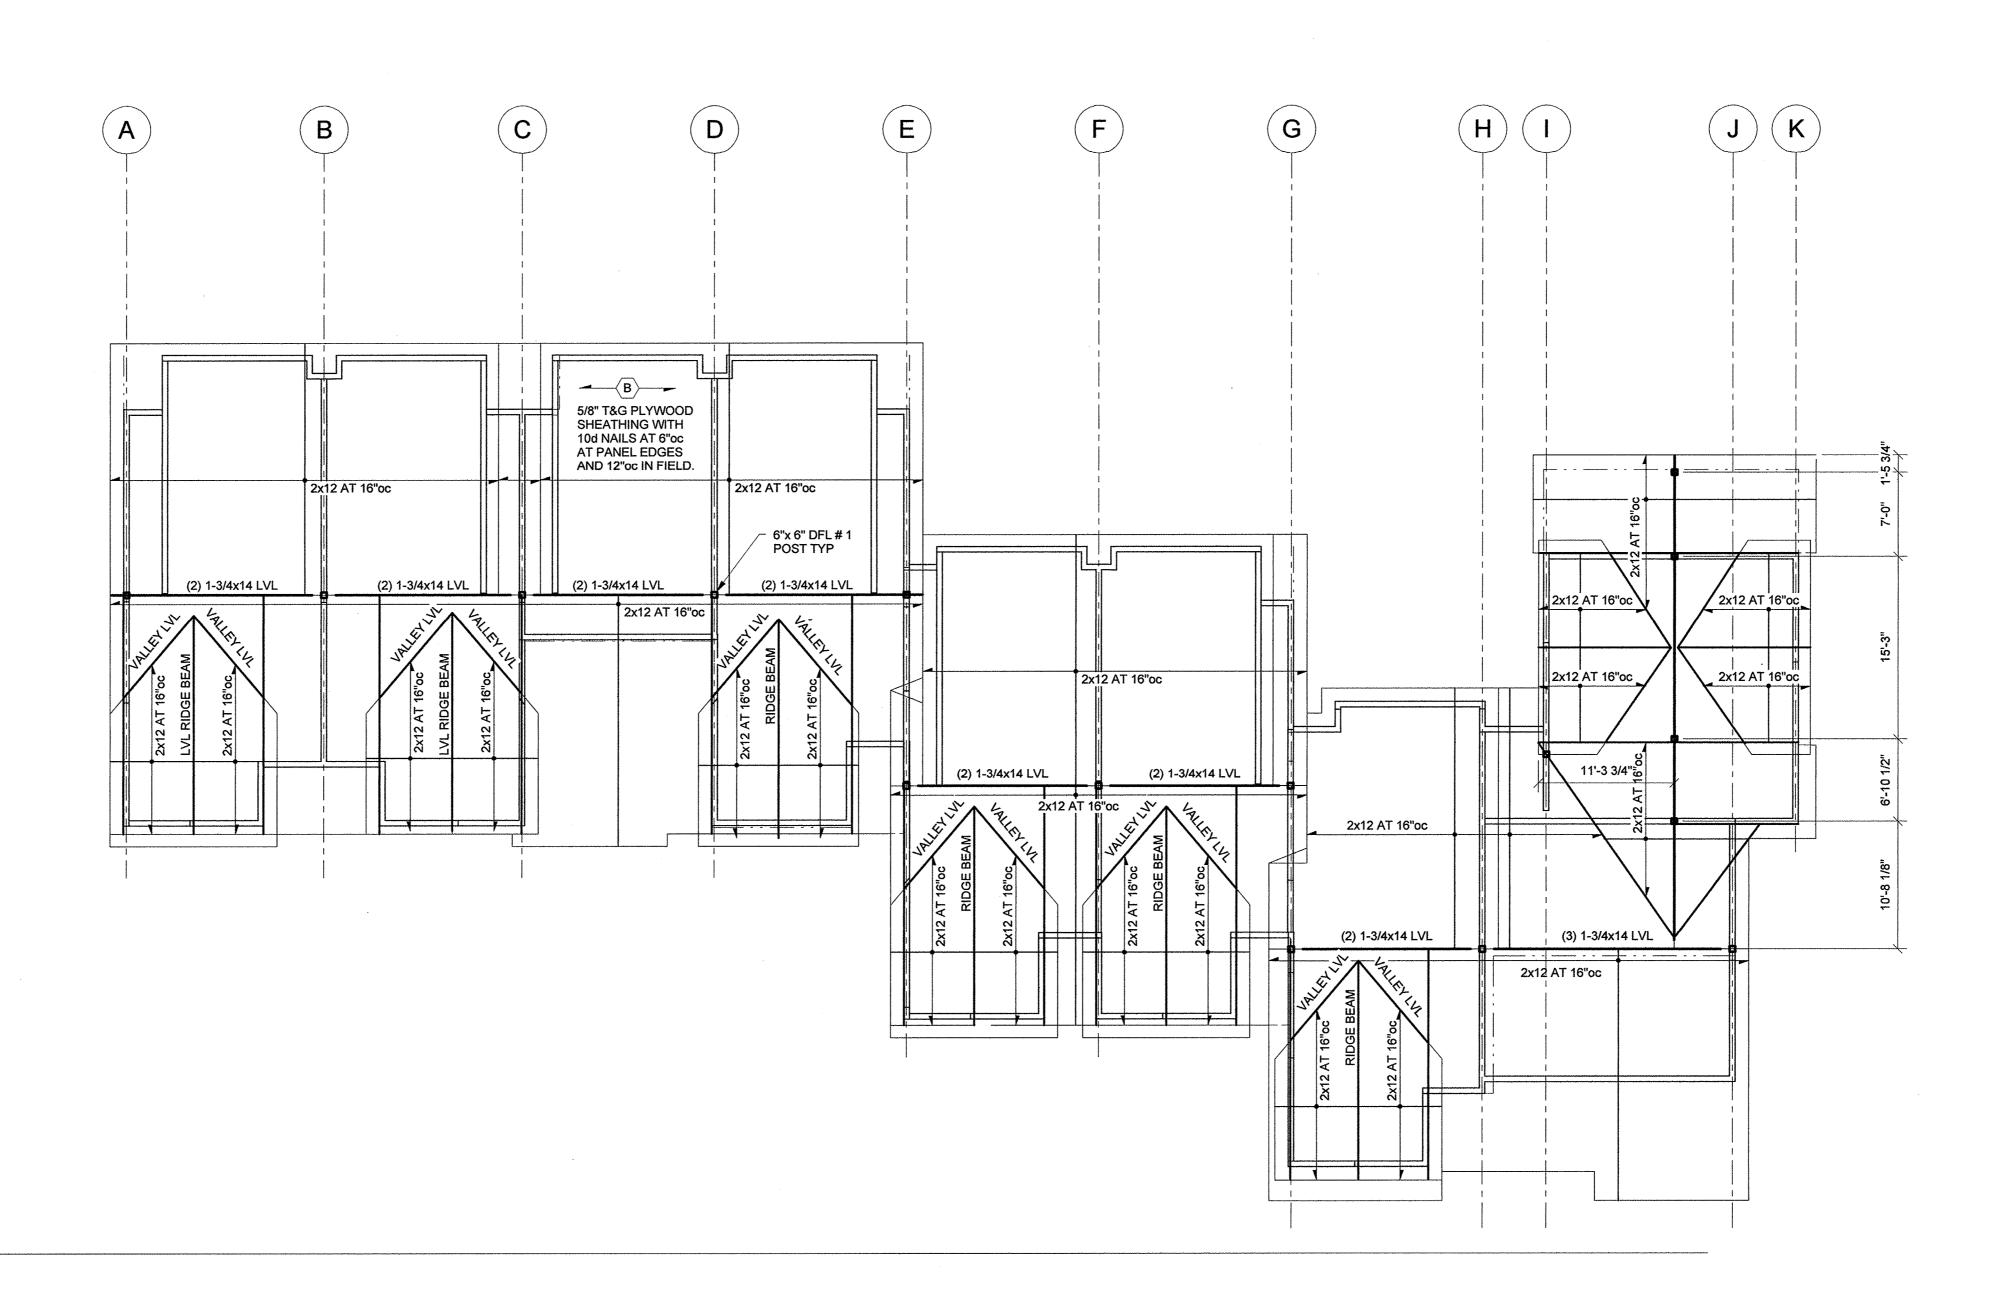
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		11-18-2013	40% CHFA
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THIRD FLOOR FRAMING PLAN



1 ATTIC / ROOF 1/8" = 1'-0"

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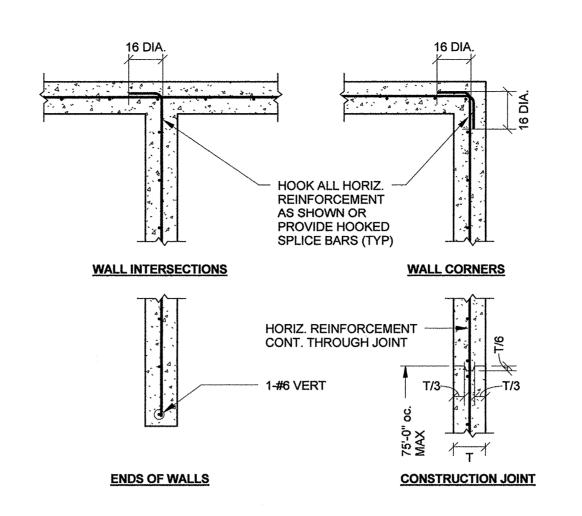


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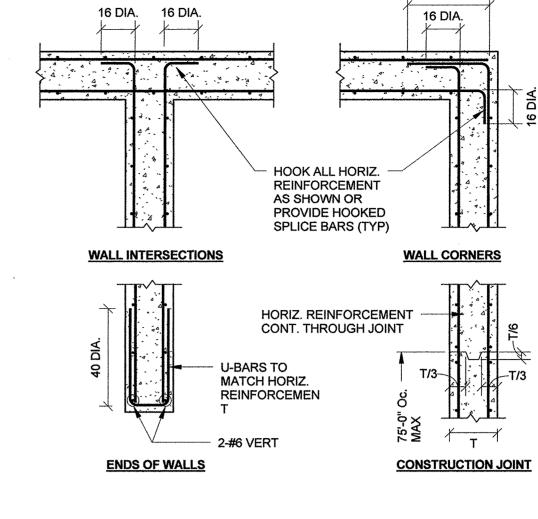
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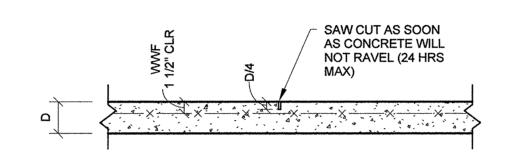
ATTIC / ROOF FRAMING PLAN




TYPICAL CONCRETE WALL REINFORCING DETAIL - WALLS LESS THAN 10" THICK



TYPICAL CONCRETE WALL REINF DETIAL - WALLS
10" THICK OR MORE



TYPICAL SLAB ON GRADE CONTROL JOINT DETAIL

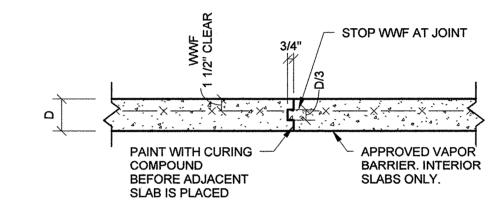

TYPICAL SLAB ON GRADE CONSTRUCTION JOINT DETAIL

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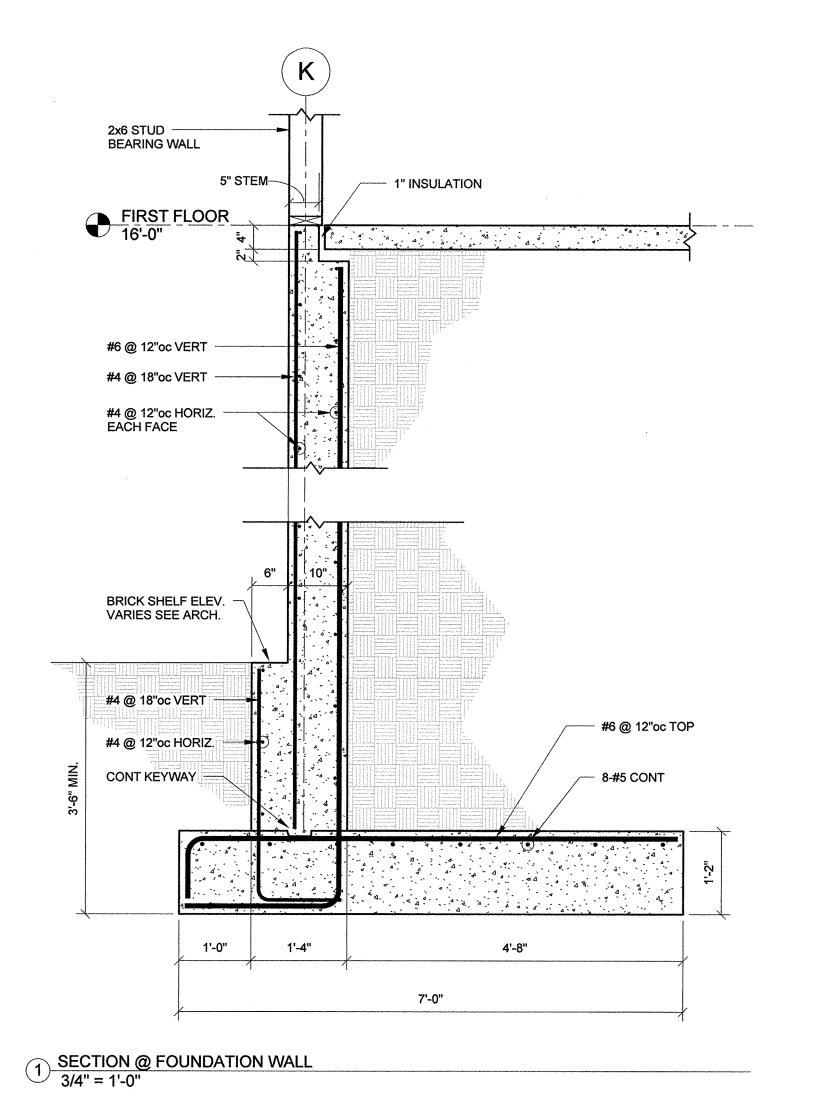
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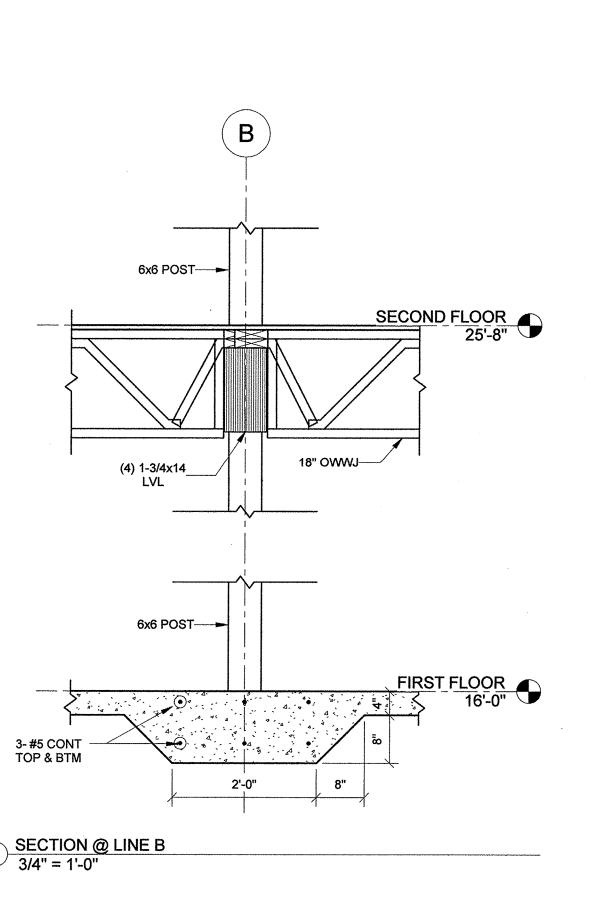
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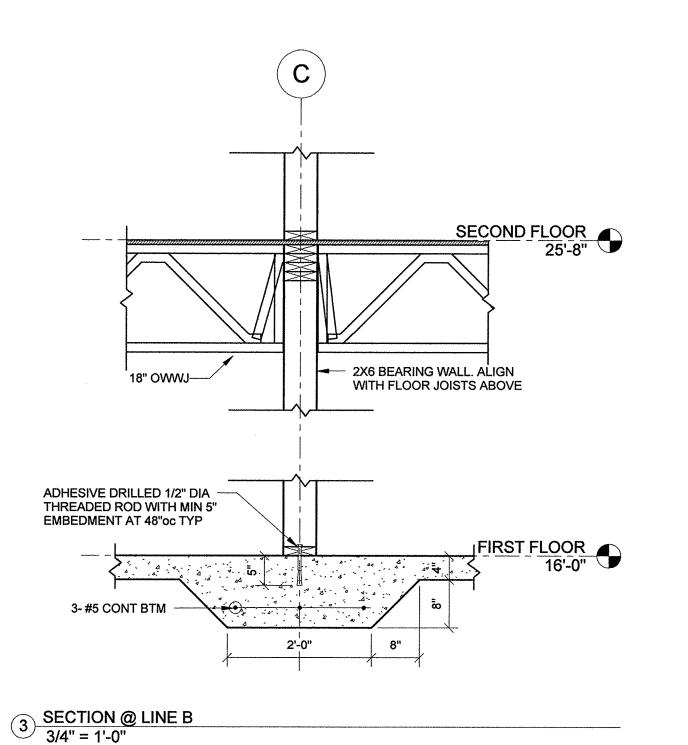
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TYPICAL DETAILS







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**SECTIONS** 

### PLUMBING GENERAL NOTES

- THE PLUMBING CONTRACTOR SHALL COORDINATE ALL WORK TO BE PERFORMED WITH THE GENERAL, FIRE PROTECTION, HVAC AND ELECTRICAL CONTRACTORS. ANY WORK DONE BY THIS CONTRACTOR WHICH INTERFERES WITH WORK BY OTHERS AND WHICH WAS NOT FIRST COORDINATED SHALL BE REMOVED AND RELOCATED AT PLUMBING CONTRACTOR'S EXPENSE.
- THIS CONTRACTOR SHALL BE RESPONSIBLE FOR VERIFICATION OF ALL UTILITIES AND THE PLACEMENT OF ALL PLUMBING EQUIPMENT PRIOR TO THE START OF HIS WORK. NO EXTRAS WILL BE ALLOWED DUE TO EQUIPMENT LOCATION CHANGE FROM THAT ON THE DRAWING.
- IT IS THE INTENT THAT THE WORK SHALL BE COMPLETE IN EVERY RESPECT AND THAT ANY MATERIAL OR WORK NOT SPECIFICALLY MENTIONED OR SHOWN ON THE DRAWINGS BUT NECESSARY TO FULLY COMPLETE THE WORK SHALL BE PROVIDED.
- 4. THE LOCATION OF SOME ITEMS SHOWN ON THE DRAWINGS MAY BE APPROXIMATE AND THE OWNER SHALL HAVE THE RIGHT TO MAKE MINOR REVISIONS BEFORE THE WORK IS INSTALLED WITHOUT ADDITIONAL COST.
- ALL WORK SHALL BE PERFORMED IN ACCORDANCE WITH ALL APPLICABLE CODES AND OWNER'S MINIMUM REQUIREMENTS. IN ALL CASES, THE MORE STRINGENT
- THIS CONTRACTOR SHALL FURNISH AND INSTALL ALL NECESSARY VALVES, TRAPS AND ALL CONTROL DEVICES REQUIRED FOR PROPER COMPLETION OF UTILITY
- STORM, WASTE AND VENT PIPING SHALL BE CAST IRON.
- WATER PIPING SHALL BE TYPE "L" COPPER WITH LEAD-FREE SOLDER JOINTS AND NON-CORROSIVE LEAD-FREE FLUX
- DOMESTIC WATER PIPING SHALL BE INSULATED WITH A MINIMUM OF 1/2" FIBERGLASS INSULATION HAVING A VAPOR BARRIER JACKET WITH SEALED JOINTS.
- 10. ALL WATER PIPING SHALL BE CONCEALED WITHIN A WALL OR PIPE CHASE EXCEPT FOR THOSE CHROME PLATED PORTIONS THAT ARE REQUIRED TO MAKE FINAL CONNECTIONS TO PLUMBING FIXTURES.
- 11. PROVIDE CHROME PLATED ESCUTCHEONS WHERE PIPES PENETRATE FLOORS, WALLS OR CEILINGS.
- 12. ALL WATER SUPPLIES TO FIXTURES OR GROUP OF FIXTURES MUST INCLUDE WATER HAMMER ARRESTORS SIZED IN ACCORDANCE WITH P.D.I. STANDARDS.
- 13. THE CONTRACTOR SHALL PROVIDE OVERFLOW PANS FOR ALL WASHING MACHINES LOCATED IN LAUNDRY ROOM ON EACH FLOOR. PIPE OVERFLOW PANS TO FLOOR
- 14. REFER TO OTHER TRADE'S DRAWINGS FOR ADDITIONAL INFORMATION.

					PLU	IMBING FIXTURE				
SYMBOL		FIX	FIXTURE			FITTINGS			OARDIED.	DEMONO
SIMBUL	MANUFACTURER	MODEL	TYPE	SIZE	MANUFACTURER	TYPE	SUPPLY	TRAP	CARRIER	REMARKS
WC-1	тото	ECO DRAKE CST744E	FLOOR MOUNTED E-MAX FLUSHING 1.28 GPF	_	· _		MCGUIRE 172LK 1/2" SUPPLY	INTEGRAL	<del>-</del>	1. SOFTCLOSE TOILET SEAT SS114, CLOSED FRONT WITH COVER & STA-TITE HINGES.
WC-2 (H/C)	тото	ECO DRAKE CST744EL	FLOOR MOUNTED POWER WASH 1.28 GPF		_	_	MCGUIRE 172LK 1/2" SUPPLY	INTEGRAL	-	1. SOFTCLOSE TOILET SEAT SS114, CLOSED FRONT WITH COVER & STA-TITE HINGES.
L-1	SWANSTONE GNTOUR	LAVATORY <del>-LT191(C</del> )	INTEGRAL UNDERCOUNTER BOWL	24" ¥ 30" 20-1/2"×12-3/8"	SYMMONS	SYMMONS DIA SLS-3512	MCGUIRE 170LK	2" CHROME PLATED CAST BRASS	-	1. UNDERCOUNTER SINK INTEGRAL 2. SINGLE POST ROUND FAUCET 3. NIAGARA N3205N AERATOR 0.5 GPM
L-2 (H/C)	SWANSTON TOTO WHOUP	LAVATORY -LT191(C)	UNDERCOUNTER BOWL	24"x 30" 20 1/2"x12 3/8".	SYMMONS	SYMMONS DIA SLS-3512	MCGUIRE 170LK	2" CHROME PLATED CAST BRASS	-	<ol> <li>MCGUIRE PRODRAINWC DRAIN WITH PERFORATED STRAINER &amp; 1-1/4" TAILPIECE HANDICAP OFFSET</li> <li>TRUEBRO HANDILAV-GUARD INSULATION KIT ON SUPPLIES AND WASTE.</li> <li>NIAGARA N3205N AERATOR 0.5 GPM</li> </ol>
SK-1	ELKAY	NEPTUNE NUH2118	S.S. UNDERMOUNT	22"x24"	SYMMONS	SYMMETRIX DECK MOUNTED S-23	MCGUIRE 175WC	2" CHROME PLATED CAST BRASS OFFSET DRAIN DELUX S.S. STRAINER	_	1. GARBAGE DISPOSAL 2. PROVIDE WITH 1.5 GPM AERATOR
SK-2 (H/C)	ELKAY	LUSTERTONE LRAD-2222	SELF RIMMING S.S. INSERT	22"Wx22"Dx 6-1/2"H	SYMMONS	SYMMETRIX DECK MOUNTED S-23	MCGUIRE 175WC	2" CHROME PLATED CAST BRASS OFFSET DRAIN DELUX S.S. STRAINER	-	1. HANDICAP ACCESSIBLE 2. TRUEBRO HANDILAV-GUARD INSULATION KIT ON SUPPLIES AND WASTE 3. GARBAGE DISPOSAL 4. PROVIDE WITH 1.5 GPM AERATOR
GD-1	Insinkerator	BADGER 5	CONTINUOUS FEED	_		-	_	1-1/2" CUSHIONED SLIP JOINT CONNECTION	_	1. DISHWASHER DRAIN CONNECTION 2. ON/OFF CONTROL: WALL SWITCH 3. 1/2 HP/120V/1PH/1725 RPM
SH-1	AMERICAN STANDARD	<del>-</del>	TUB/SHOWER	60"W x 30"D x 16-5/8"H	SYMMONS DIA	3501-CYL	-	2"	<del>-</del>	1. SELF CAULKING BRASS DRAIN W/S.S. STRAINER. 2. 1.5 GPM SHOWERHEAD
SH-2	AMERICAN STANDARD	TILE	ADA COMPLIANT ROLL—IN SHOWER	CUSTOM	SYMMONS	S-3504-H321-V-CYL-B	·	2*	-	1. HANDICAP ACCESSIBLE 2. GRAB BARS BY ARCHITECT 3. ADJUSTABLE WALL BRACKET FOR HAND HELD SHOWEF 4. SELF CAULKING BRASS DRAIN W/S.S. STRAINER. 5. REMOVABLE SEAT BY ARCHITECT 6. INTEGRAL SERVICE STOPS 7. 1.5GPM SHOWERHEAD
WB-1	GUY GREY	WB-200	RECESSED BOX	11-3/4 <b>"</b> W x 9-1/2"D	-	_	_	2"	-	PROVIDE WITH 'DRIPTITE' LAUNDRY TRAY AND FLOODSTOP MOISTURE SENSOR MODEL FS3/4H-90
HB-A	ZURN	Z1310	ECOLOTROL WALL HYDRANT	-	<del></del>	_	-	_	-	

GAS WATER HEATER SCHEDULE									
TAG	MANUFACTURER	MODEL	TANK SIZE	RECOVERY		BTUH	REMARKS		
		MODEL		GPH	TEMP RISE	INPUT	CANAMAN		
GWH-1	NAVIEN	CH-240-ASME	_	4.5	77*	199	WALL MOUNTED CONDENSING GAS COMBINATION BOILER		

### PROVIDE UNITS WITH:


- CH QUICK-INSTALL MANIFOLD KIT: (GXXX001178)
- PLUMB EASY VALVE SET: 1"STANDARD (BCSA0563)
- CONDENSATE NEUTRALIZER: (UA1300001A) READY LINK COMMUNICATION CABLE: (BCRA1129)
- OUTDOOR RESETR SENSOR: (NASS9EX0TS01) CONDENSATE DRAIN HOSE: (BH2206006A)

	PLUMBING FIXTURE ROUGHING SCHEDULE								
TAG	Fixture type	s/w	٧	CW	HW	REMARKS			
WC-1	WATER CLOSET	4*	2"	1/2"	_				
WC-2	WATER CLOSET	4"	2"	1/2"		HANDICAP ACCESSIBLE			
L-1	LAVATORY	2"	2"	1/2"	1/2"				
L-2	LAVATORY	2"	2*	1/2"	1/2"	HANDICAP ACCESSIBLE.			
SK-1	SINK	2"	2"	1/2"	1/2"	1/2" HW TO DISHWASHER			
SK-2	SINK	2"	2"	1/2"	1/2"	HANDICAP ACCESSIBLE. 1/2" HW TO DISHWASHER			
SH-1	TUB/SHOWER	2"	2"	1/2"	1/2*				
SH-2	TUB/SHOWER	2"	2"	1/2"	1/2*	HANDICAP ACCESSIBLE			
WB-1	WASHING MACHINE BOX	2"	2"	1/2"	1/2"				
H.B.	HOSE BIBB	-	-	3/4"	_				

DRAIN SCHEDULE								
TYPE	MANUFACTURER	MODEL	DESCRIPTION	REMARKS				
FD-A	ZURN	Z-415	GENERAL PURPOSE	W/ SURE SEAL INLINE 4" FLOOR DRAIN TRAP SEALER MODEL SS4009				

THERMOSTATIC MIXING VALVE SCHEDULE						
ID	MFG'R	MODEL NO.	GPM	DELTA P	INLETS	OUTLET
TMV-1	LAWLER MFG.	#803		_	1-1/4"	1-1/2"

PRESSURE REGULATING VALVE SCHEDULE							
ID	MFG'R	MODEL NO.	SIZE	DELTA P	MIN. GPM	MAX. GPM	
PRV-1	WATTS	SERIES 223 LP	1/2*	25	1/2	6	

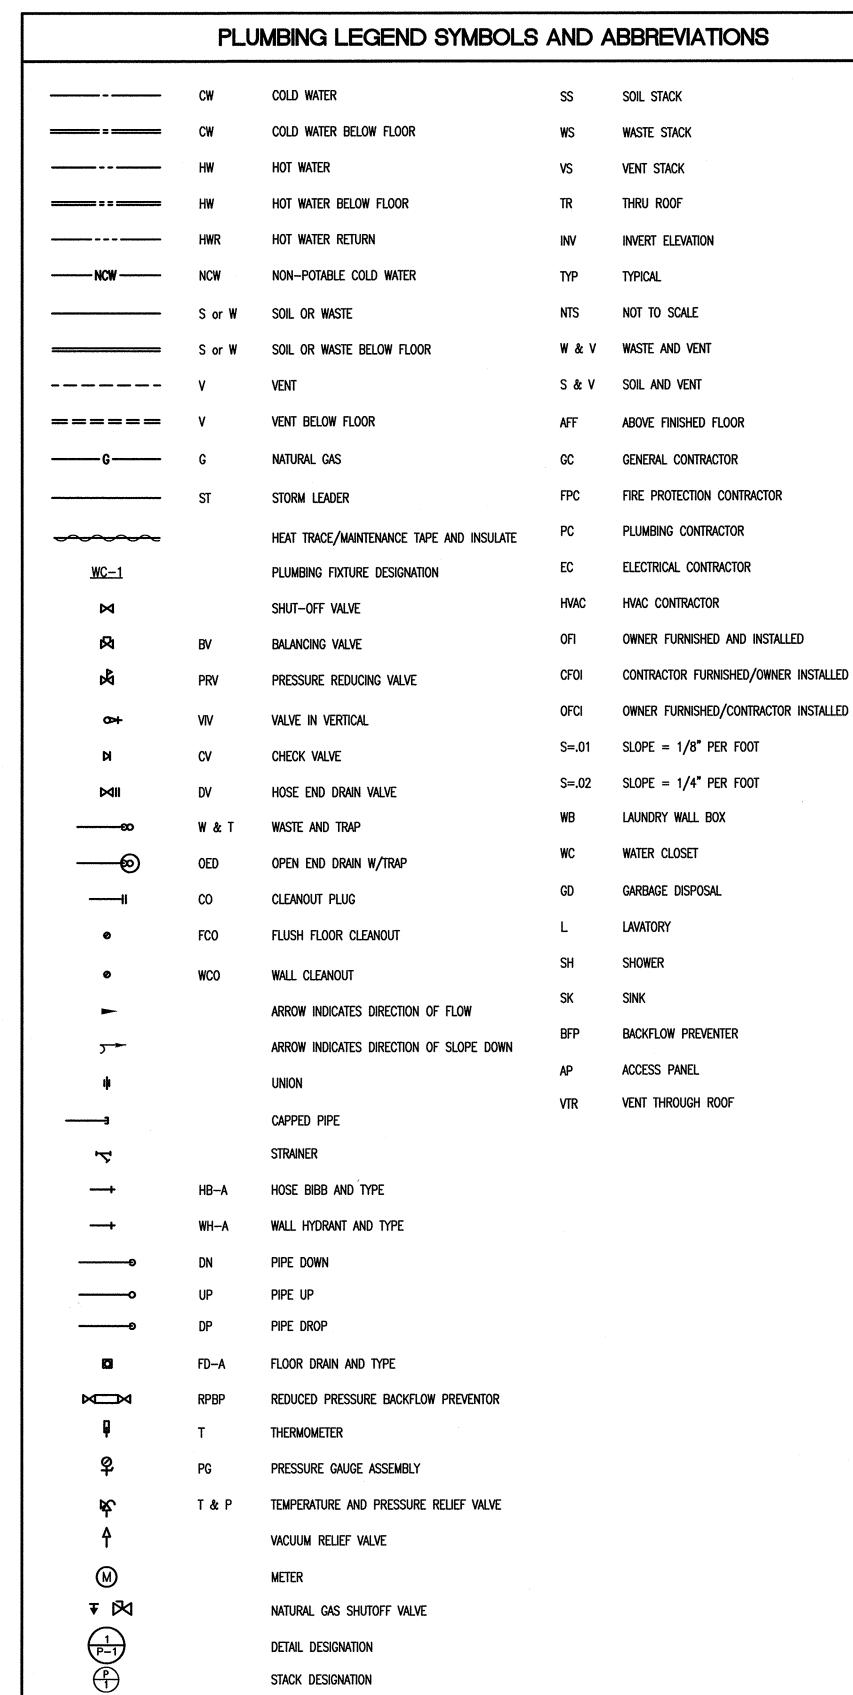

# Washington Village Phase 1

### 13 Day Street Building A

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# **ARCHITECTURE**


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**PLUMBING** SCHEDULES **LEGENDS & NOTES** 

P-001

1) 3/4" CW DOWN TO EXTERIOR HOSE BIB.

1" CW VALVED & CAPPED WITH BACKFLOW PREVENTER FOR IRRIGATION. COORDINATE LOCATION WITH ALL TRADES.

GENERAL NOTE:

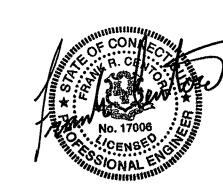COORDINATE ALL WORK WITH ALL OTHER TRADES. REFER TO OTHER TRADE'S DRAWINGS FOR ADDITIONAL INFORMATION.

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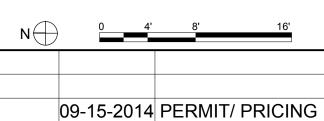
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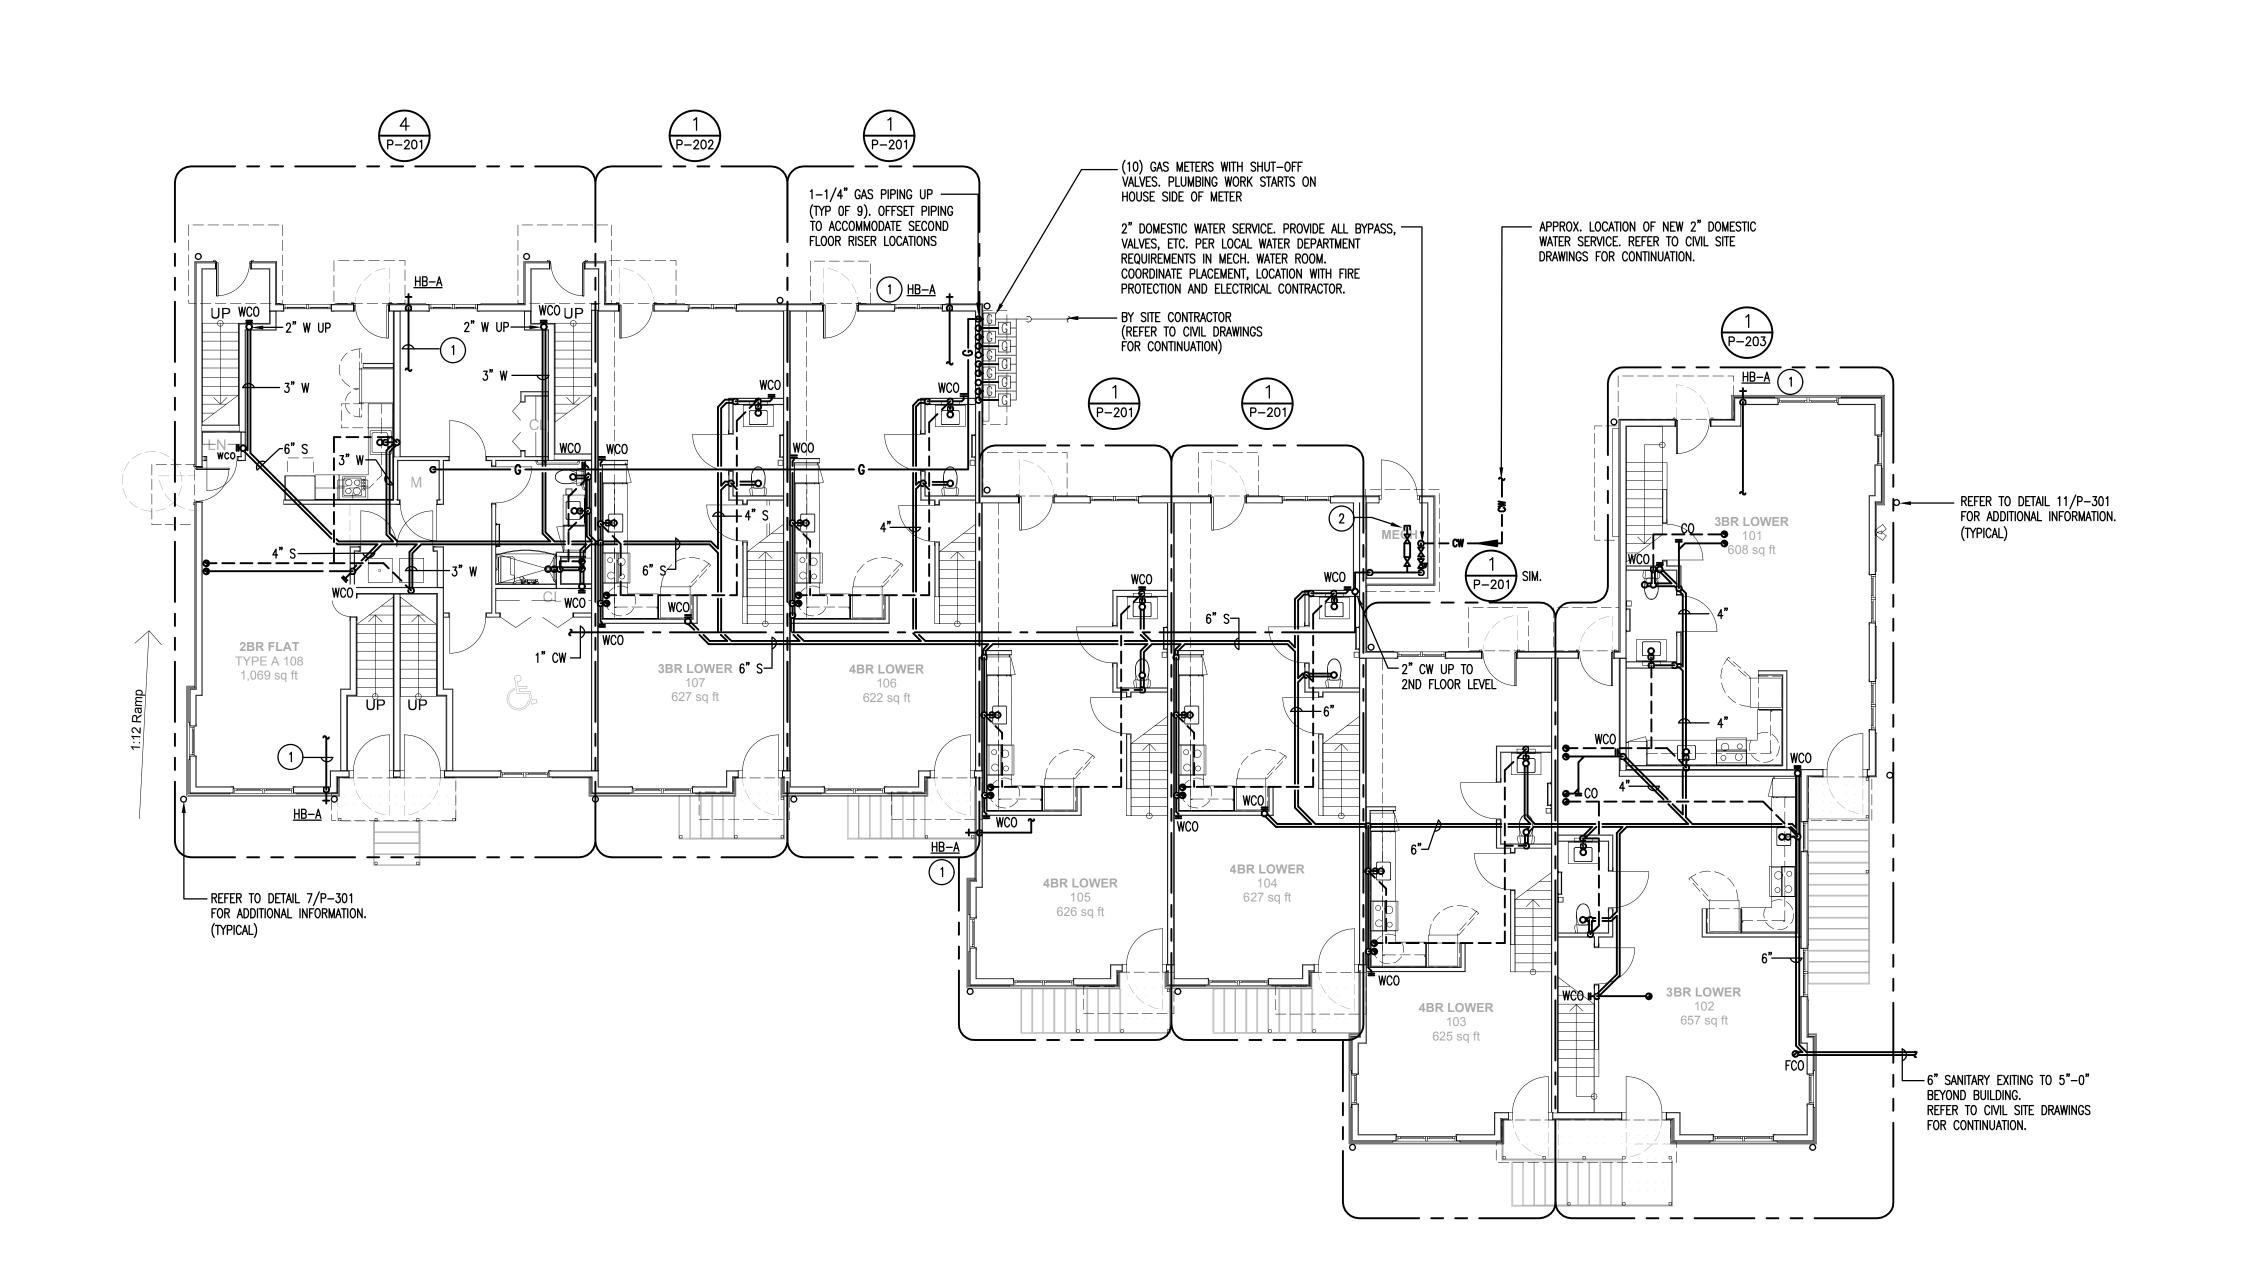
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BUILDING A FIRST FLOOR PLAN - PLUMBING

PROJECT NORTH



1 FIRST FLOOR PLAN - PLUMBING
SCALE: 1/8"=1'-0"

### PLUMBING WORK NOTES

GENERAL NOTE:

. COORDINATE ALL WORK WITH ALL OTHER TRADES. REFER TO OTHER TRADE'S DRAWINGS FOR ADDITIONAL INFORMATION.

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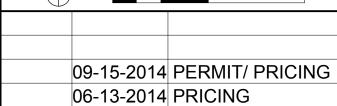
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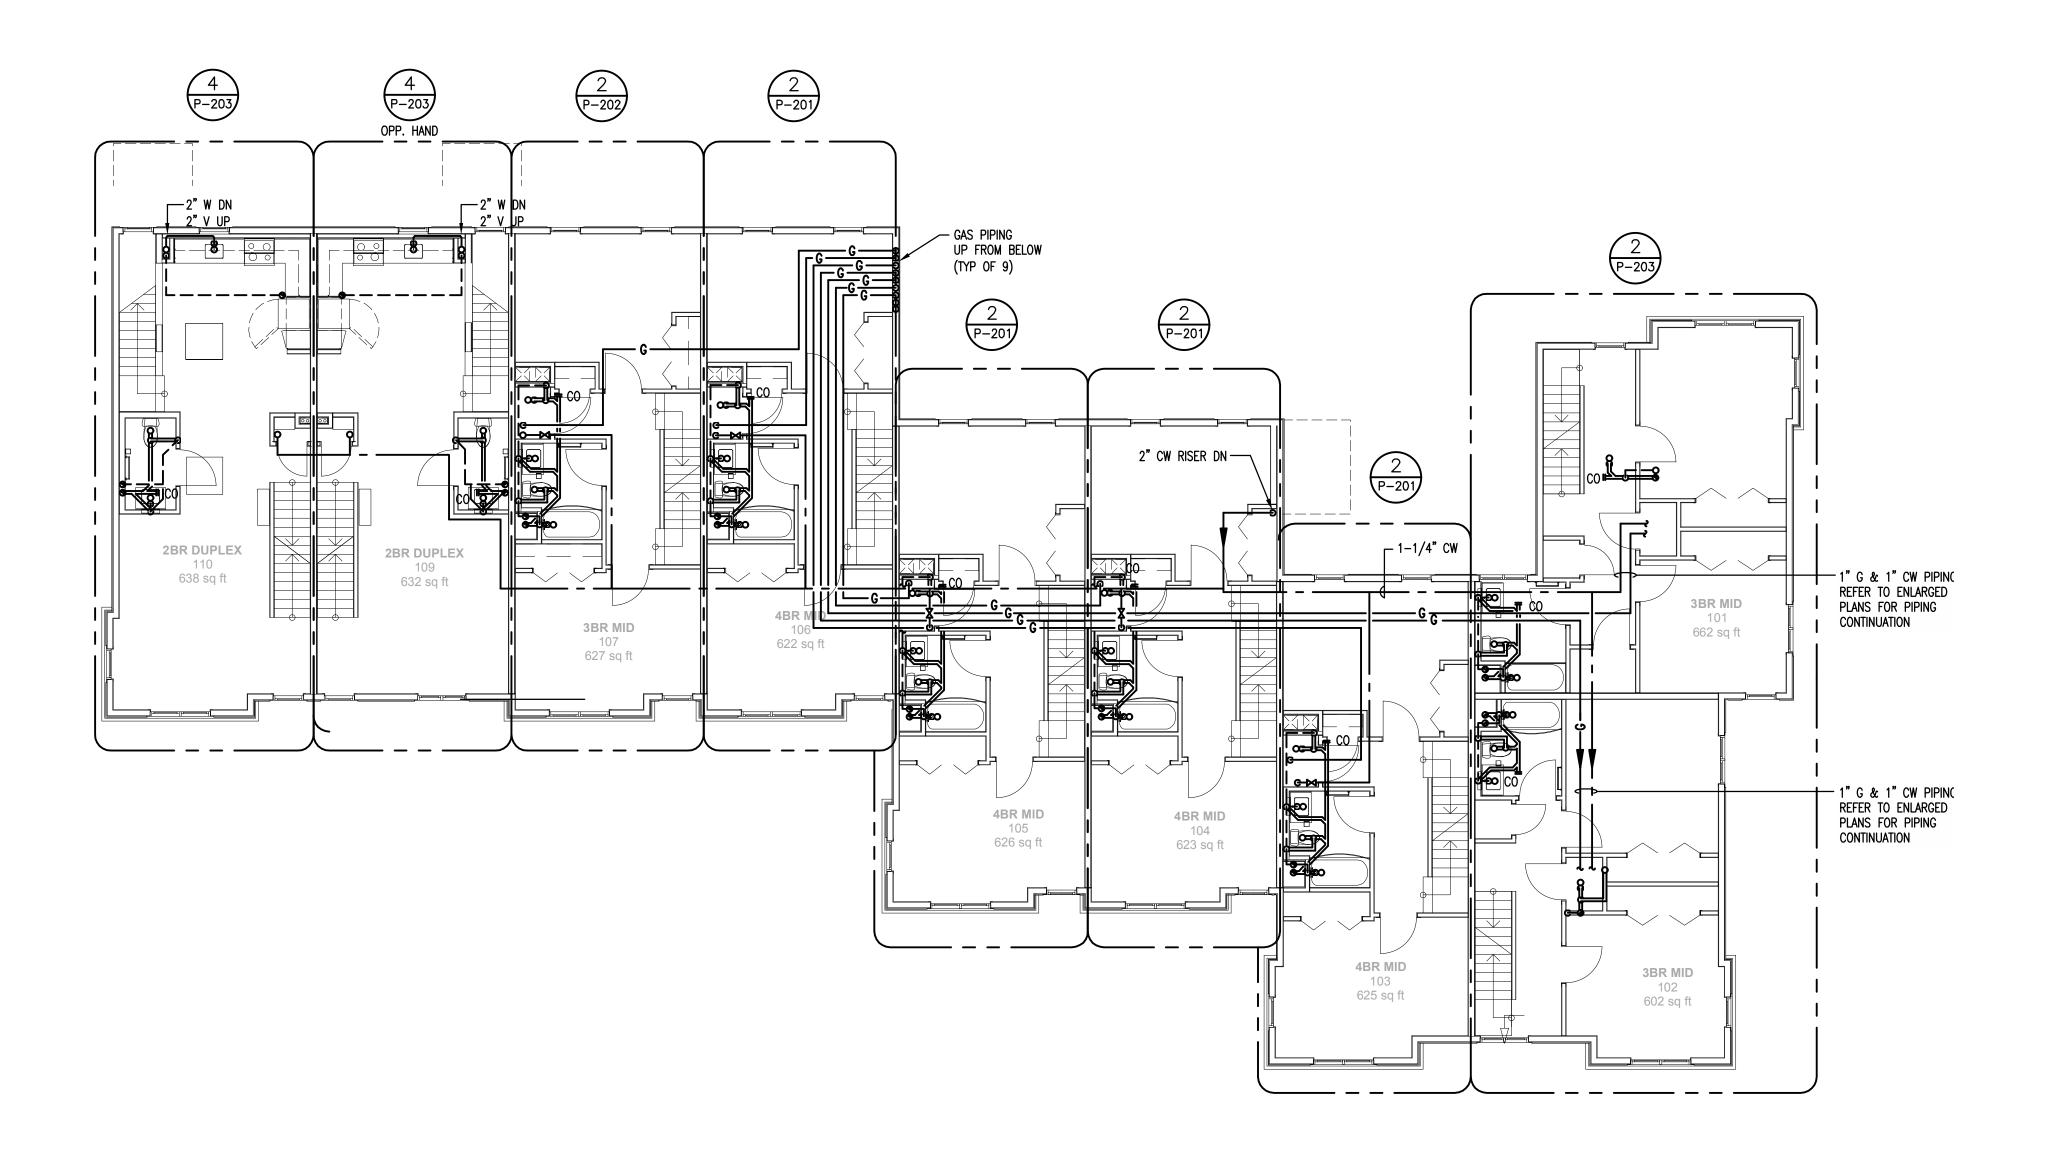
11-18-2013 40% CHFA
09-19-2013 CAM/ SPECIAL PERMIT
MARK DATE DESCRIPTION

PROJECT NO.: 21222/CENTEK #13232.01
DRAWN BY: SAO/TSP
CHECKED BY: FRC

SHEET TITLE

BUILDING A SECOND FLOOR PLAN - PLUMBING

PROJECT NORTH



SECOND FLOOR PLAN - PLUMBING

SCALE: 1/8"=1'-0"

P-102

9/2014 1:30 PM

### PLUMBING WORK NOTES

GENERAL NOTE:

. COORDINATE ALL WORK WITH ALL OTHER TRADES. REFER TO OTHER TRADE'S DRAWINGS FOR ADDITIONAL INFORMATION.

# Washington Village Phase 1

# 13 Day Street Building A

Norwalk, CT

Trinity Washington Village Limited Partnership

the Norwalk Housing Authority




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06-13-2014 PRICING 11-18-2013 40% CHFA 09-19-2013 CAM/ SPECIAL PERMIT

MARK DATE DESCRIPTION


PROJECT NO.: 21222/CENTEK #13232.01 DRAWN BY: SAO/TSP

SHEET TITLE

CHECKED BY: FRC

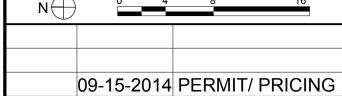**BUILDING A** THIRD FLOOR PLAN - PLUMBING

PROJECT NORTH

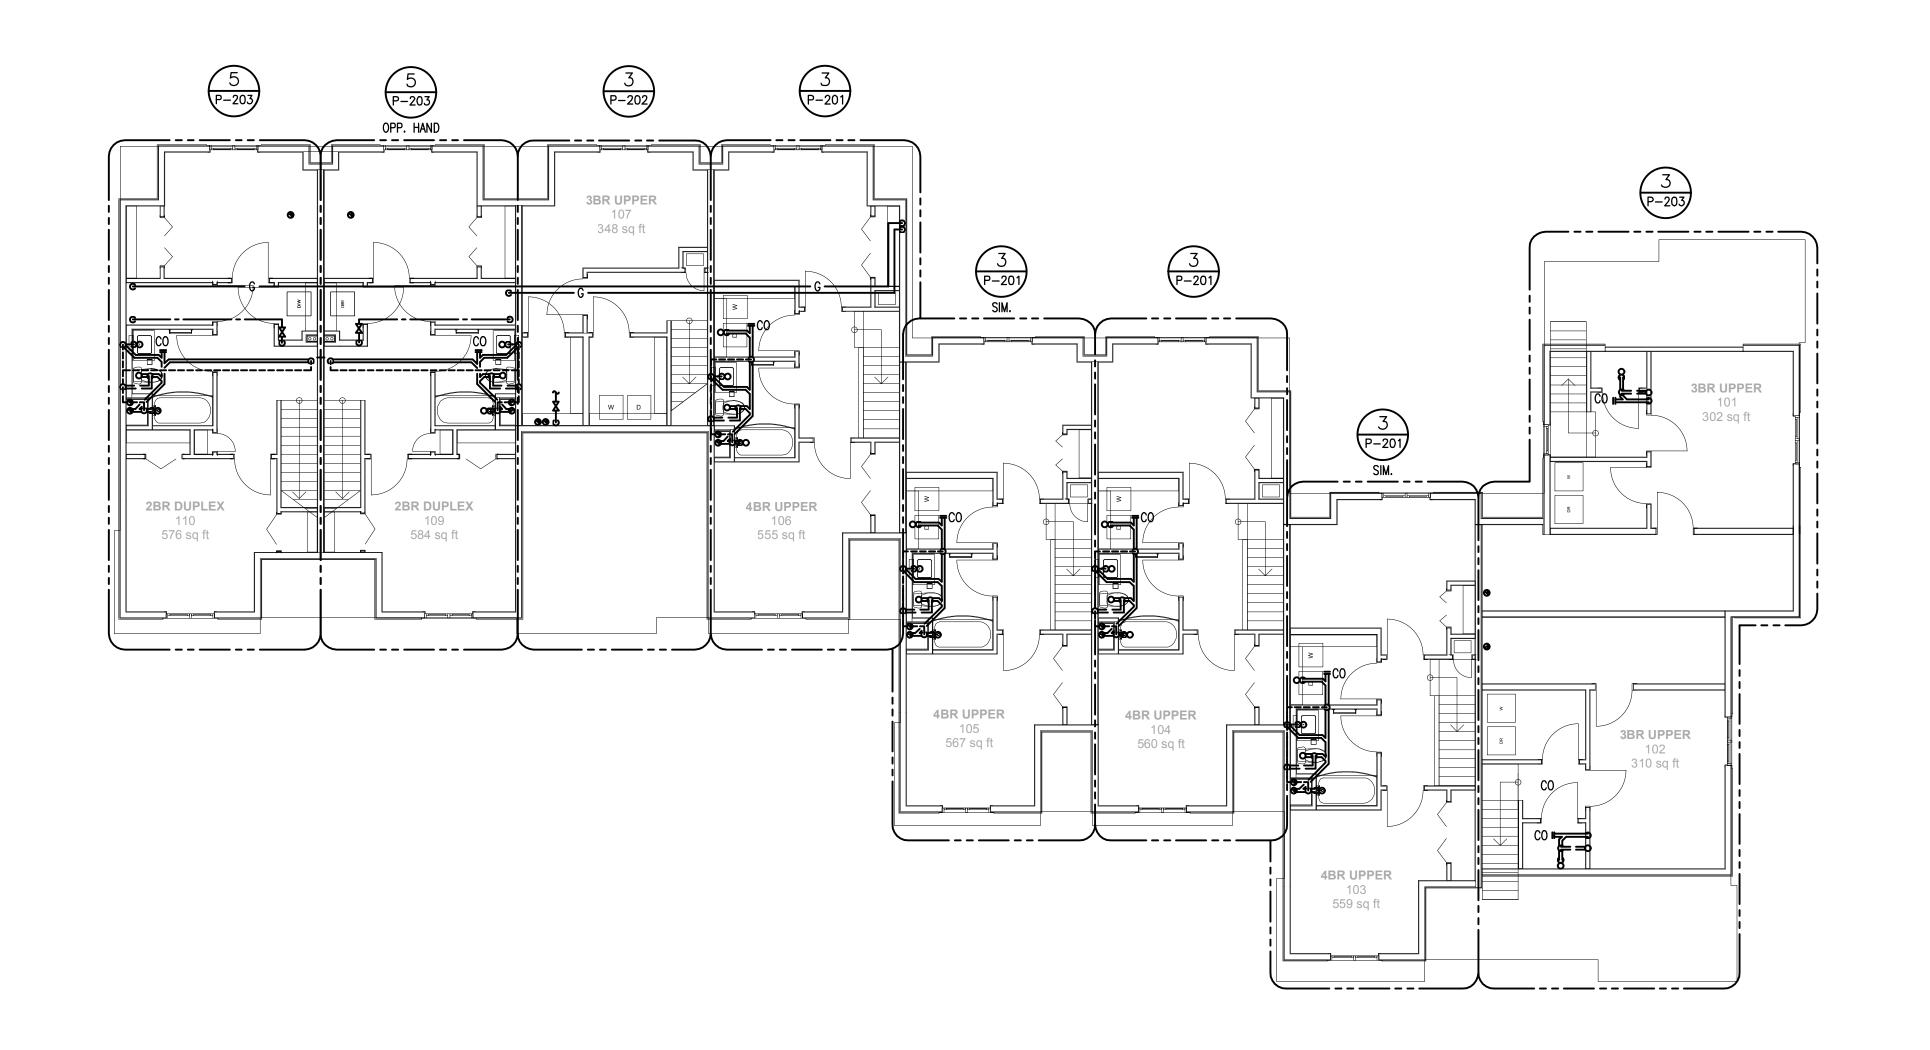

THIRD FLOOR PLAN - PLUMBING

SCALE: 1/8"=1'-0"

PLUMBING WORK NOTES

GENERAL NOTE:

1. COORDINATE ALL WORK WITH ALL OTHER TRADES. REFER TO OTHER TRADE'S DRAWINGS FOR ADDITIONAL INFORMATION.

## Washington Village Phase 1

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09-19-2013 CAM/ SPECIAL PERMIT
MARK DATE DESCRIPTION


PROJECT NO.: 21222/CENTEK #13232.01 DRAWN BY: SAO/TSP

SHEET TITLE

CHECKED BY: FRC

BUILDING A ROOF PLAN -PLUMBING

PROJECT NORTH

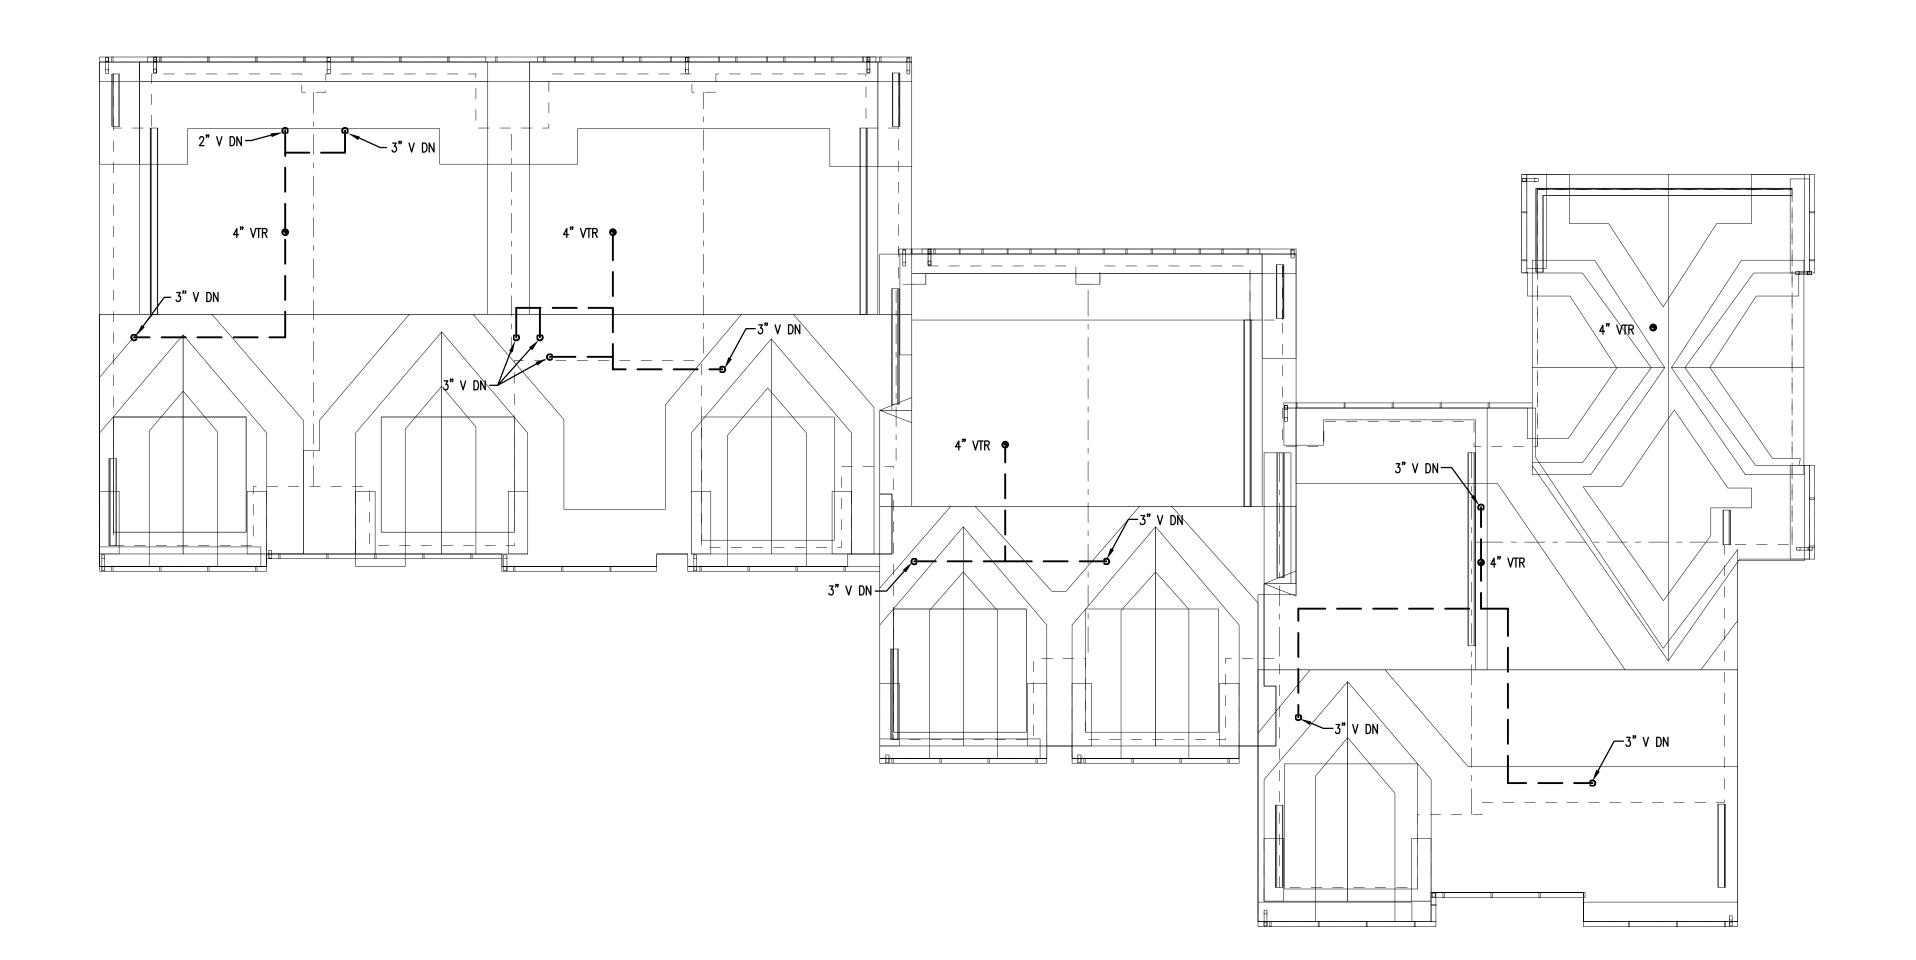

1 ROOF PLAN - PLUMBING
SCALE: 1/8"=1'-0"

P-104

#### PLUMBING WORK NOTES

. COORDINATE ALL WORK WITH ALL OTHER TRADES. REFER TO OTHER TRADE'S DRAWINGS FOR ADDITIONAL INFORMATION.

# Washington Village Phase 1

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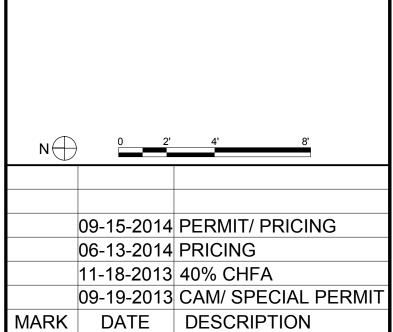
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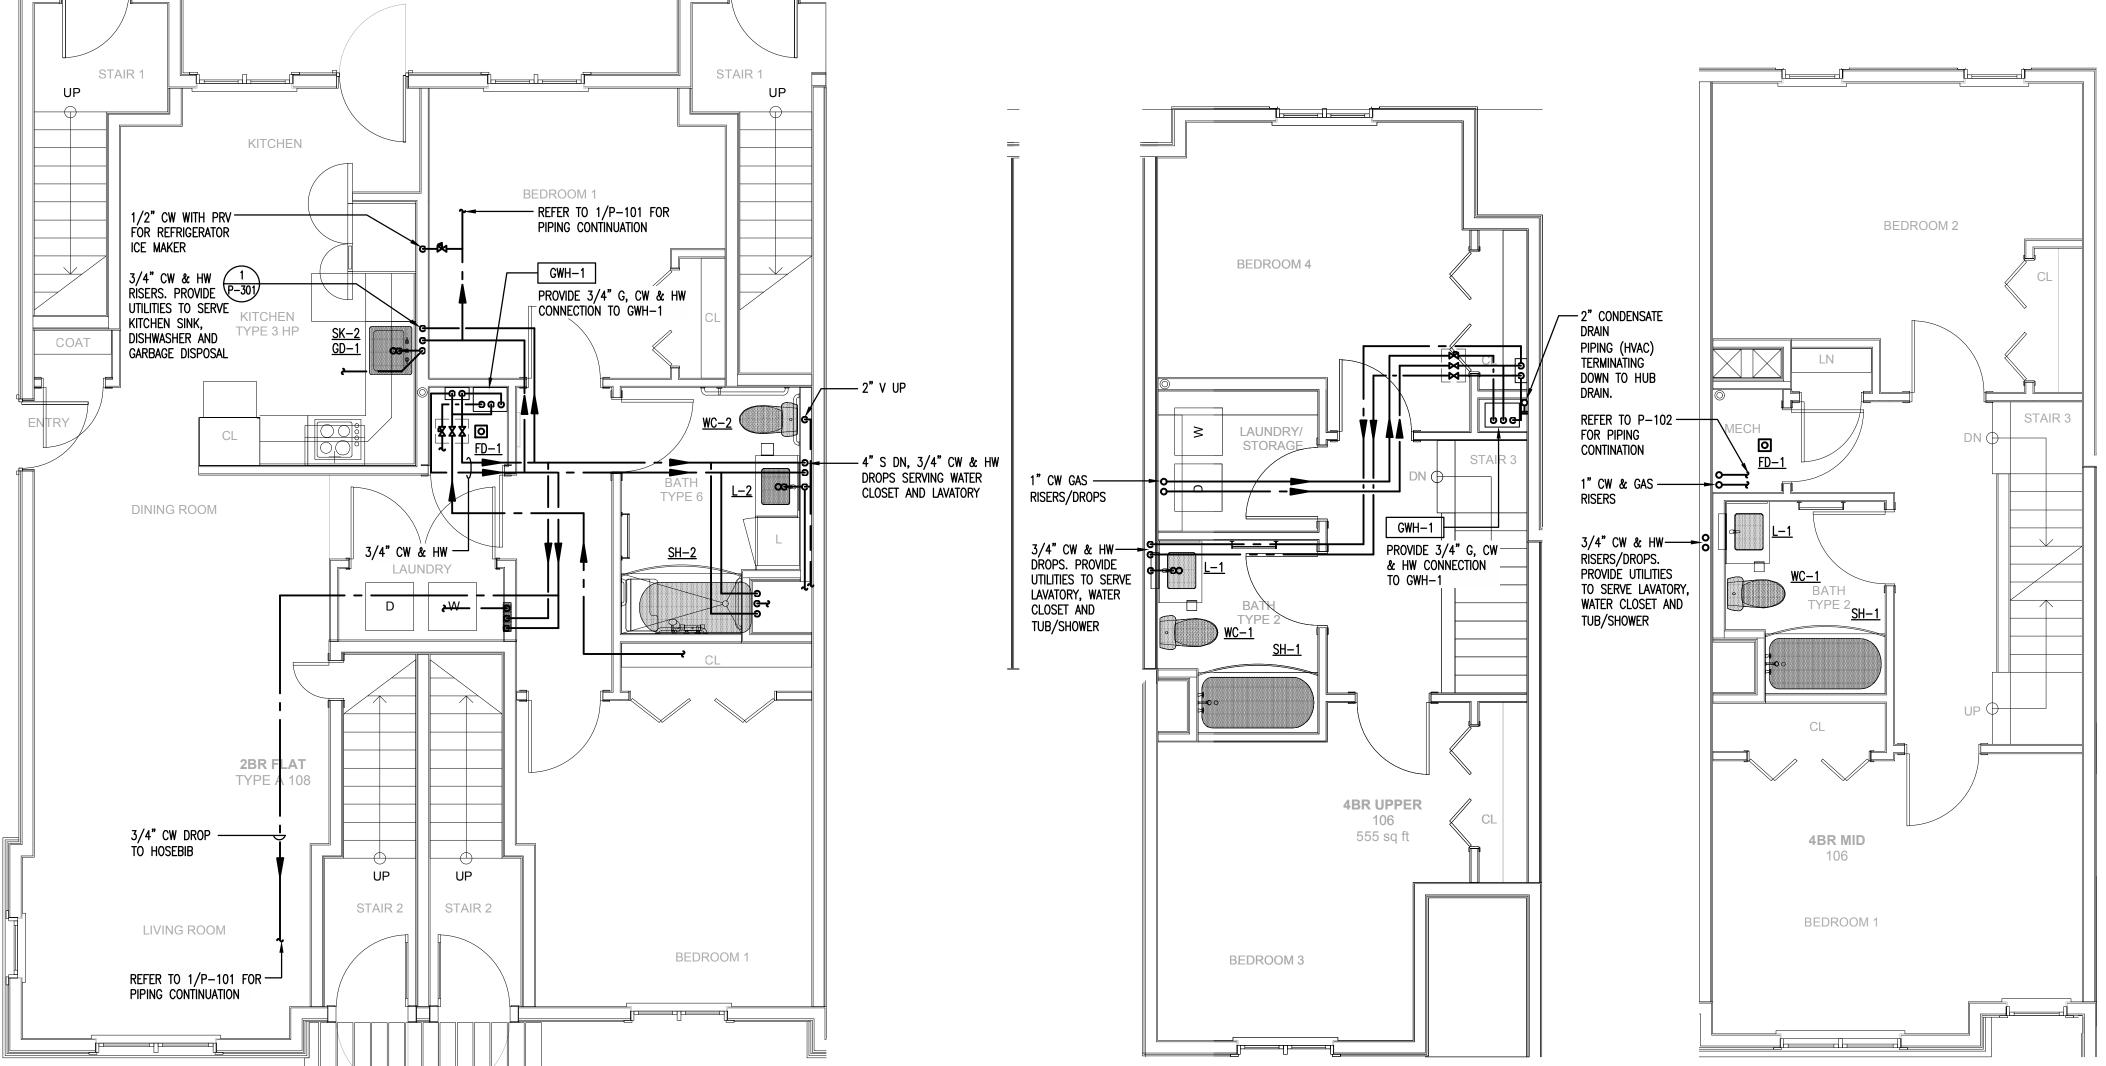


PROJECT NO.: 21222/CENTEK #13232.01 DRAWN BY: SAO/TSP CHECKED BY: FRC

SHEET TITLE

TYPICAL UNIT PLANS **BUILDING A PLUMBING** 

P-201




**DINING ROOM** SK4TCHEN GD-17 PE 2 3/4" CW & HW RISERS. PROVIDE UTILITIES TO SERVE KITCHEN SINK, DISHWASHER AND GARBAGE DISPOSAL STAIR 3 **4BR LOWER** 106 1/2" CW WITH PRV — FOR REFRIGERATOR ICE MAKER LIVING ROOM

2 TOWNHOUSE SCALE: 1/4"=1'-0" (FOUR BEDROOM TOWNHOUSE)

TOWNHOUSE FIRST FLOOR PLAN - PLUMBING (FOUR BEDROOM TOWNHOUSE) (FOUR BEDROOM TOWNHOUSE)

PROJECT NORTH

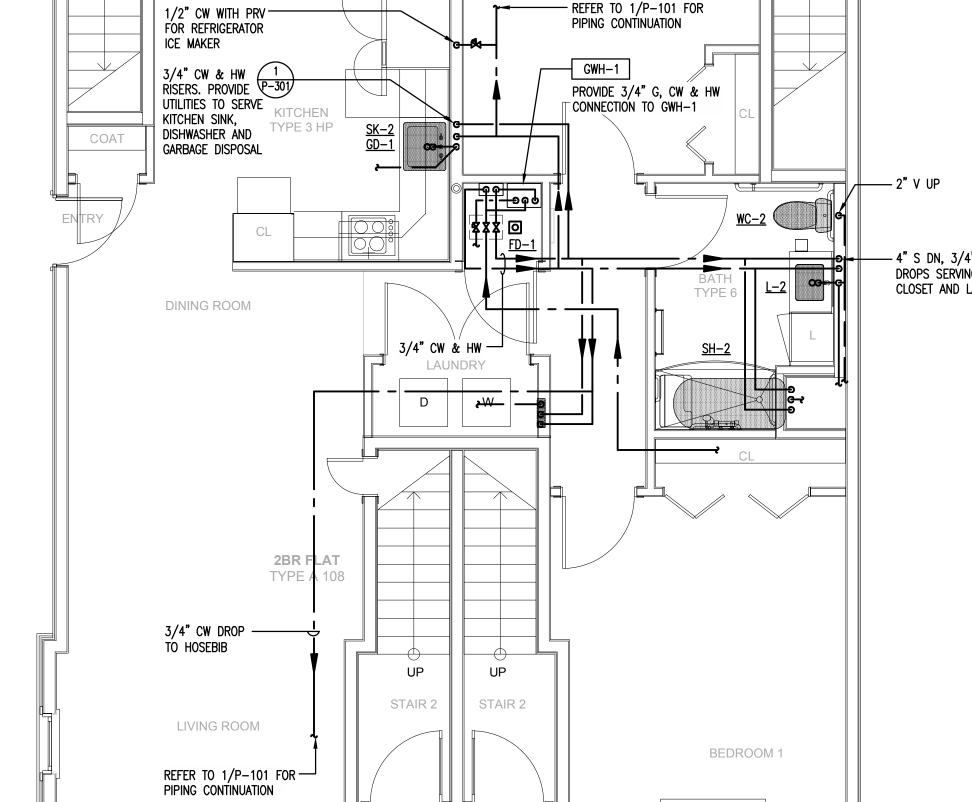

2BR FLAT - PLUMBING
SCALE: 1/4"=1'-0"

TOWNHOUSE THIRD FLOOR PLAN - PLUMBING

TOWNHOUSE SECOND FLOOR PLAN - PLUMBING

#### PLUMBING WORK NOTES

GENERAL NOTE:

DINING ROOM

SK4TCHEN GD-YPE 2

1/2" CW WITH PRV — FOR REFRIGERATOR ICE MAKER

3/4" CW & HW TRISERS. PROVIDE P-301)
UTILITIES TO SERVE
KITCHEN SINK,
DISHWASHER AND
GARBAGE DISPOSAL

. COORDINATE ALL WORK WITH ALL OTHER TRADES. REFER TO OTHER TRADE'S DRAWINGS FOR ADDITIONAL INFORMATION.

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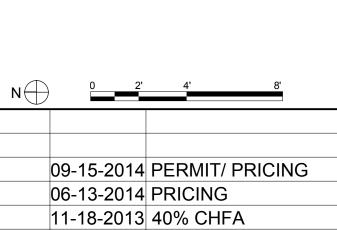
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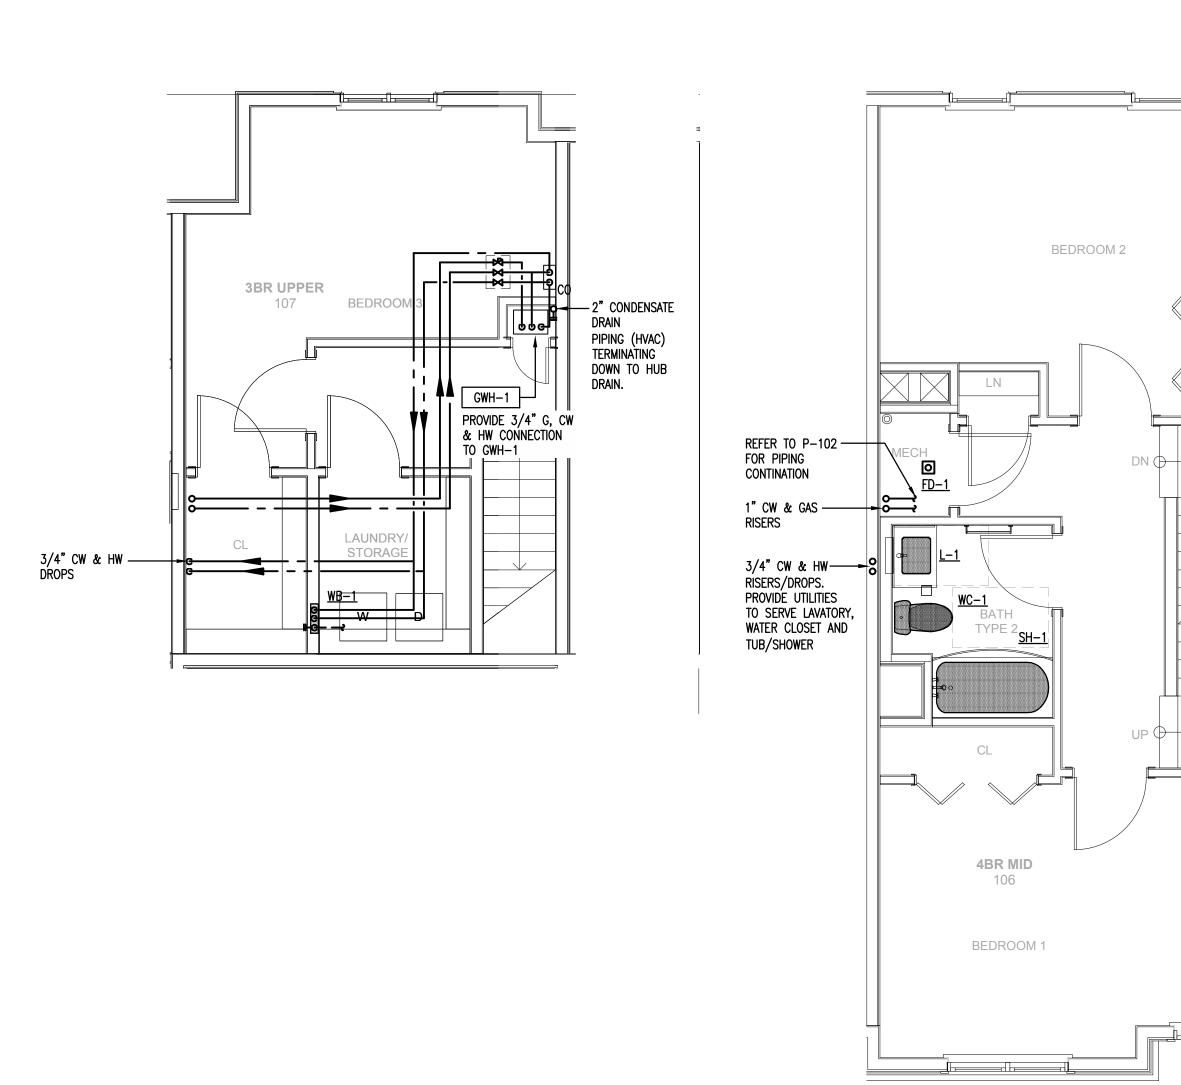
09-19-2013 CAM/ SPECIAL PERMIT MARK DATE DESCRIPTION

PROJECT NO.: 21222/CENTEK #13232.01 DRAWN BY: SAO/TSP CHECKED BY: FRC

SHEET TITLE

TYPICAL UNIT PLANS BUILDING A **PLUMBING** 

PROJECT NORTH



TOWNHOUSE THIRD FLOOR PLAN - PLUMBING

SCALE: 1/4"=1'-0" (THREE BEDROOM TOWNHOUSE)

(THREE BEDROOM TOWNHOUSE)

TOWNHOUSE SECOND FLOOR PLAN - PLUMBING SCALE: 1/4"=1'-0" (THREE BEDROOM TOWNHOUSE)

Y TOWNHOUSE FIRST FLOOR PLAN - PLUMBING SCALE: 1/4"=1'-0" (THREE BEDROOM TOWNHOUSE)


UP STAIR 3


**4BR LOWER** 106

LIVING ROOM

P-202



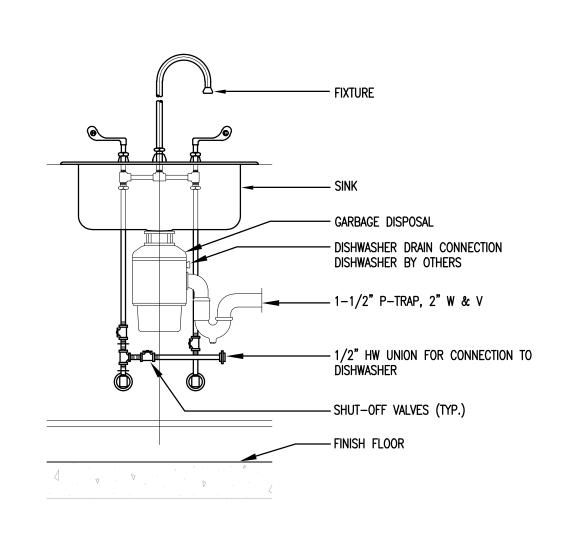

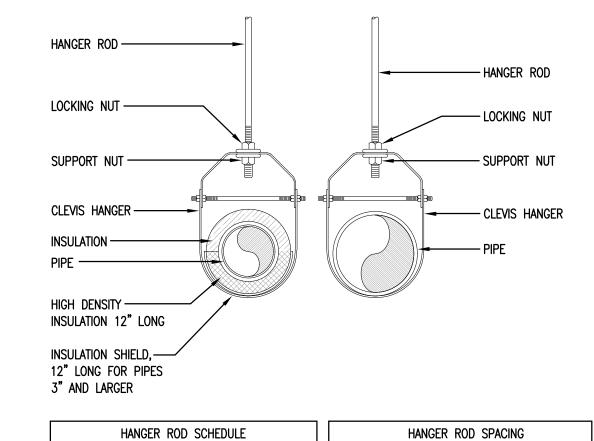

ROD SIZE 3/8" DIA.

1/2" DIA.

- DOMESTIC WATER

PLUMBING PIPE HANGER INSTALLATION DETAIL

N.T.S.


PIPE SIZE

UP TO 2" 2-1/2" THRU 3"

4" AND 5" 6" THRU 8"

FINISH FLOOR  SLAB ON GRADE	FLUSH FLOOR CLEANOUT  ADJUSTABLE TOP
	LONG SWEEP BEND OR TWO 1/8TH BENDS
F	ESILIENT GASKET JOINTS

3 FLUSH FLOOR CLEANOUT

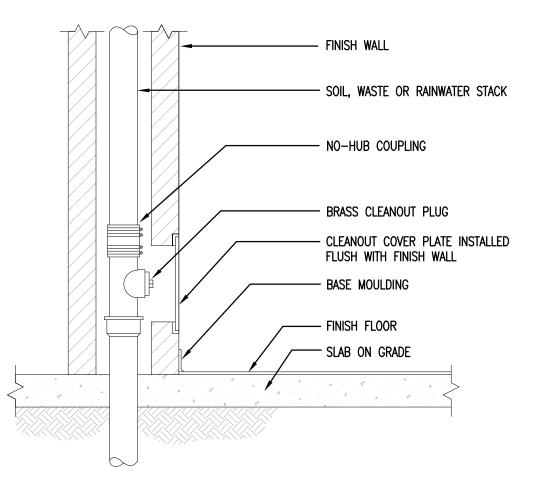

4 FLUSH WALL CLEANOUT N.T.S.

11" MAX.

8 SANITARY OFFSET AT BEAM

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Washington Village Phase 1

13 Day Street

Building A

the Norwalk Housing Authority



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- 4" HORIZONTAL SOIL

- NO-HUB COUPLING (TYP)

- 6" BEAM FLANGE

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09-19-2013 CAM/ SPECIAL PERMIT MARK DATE DESCRIPTION

PROJECT NO.: 21222/CENTEK #13232.01


DRAWN BY: SAO/TSP CHECKED BY: FRC

SHEET TITLE


PLUMBING **DETAILS** 

P-301



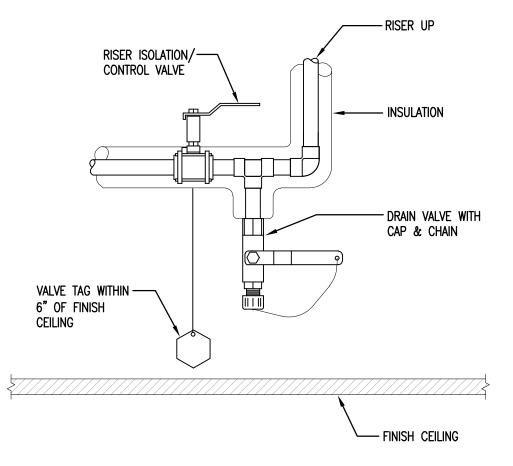

RISER CONTROL AND DRAIN VALVE

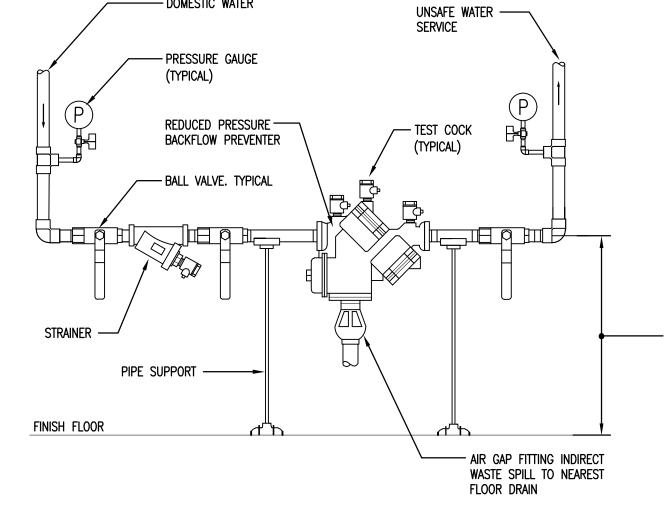



1 1/4"


3" THRU 8" 10" & 12"

MAX. ALLOWABLE SPACING


REDUCED PRESSURE BACKFLOW PREVENTER

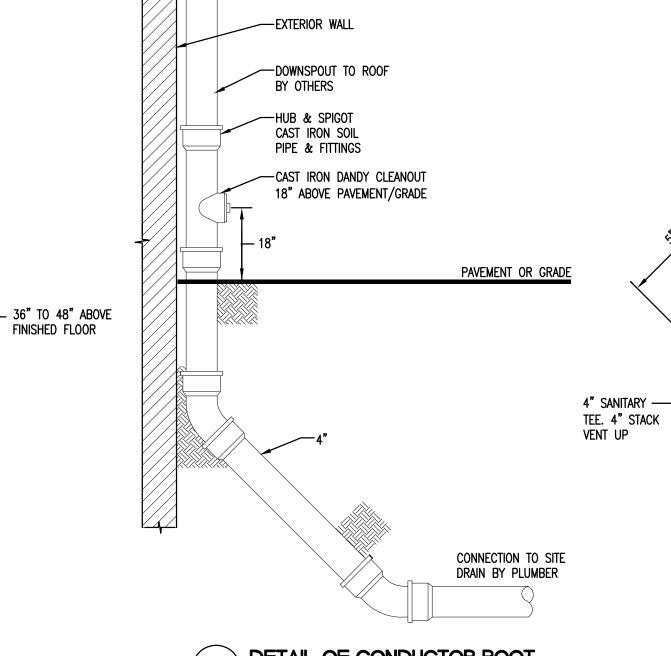

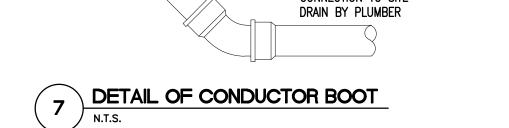

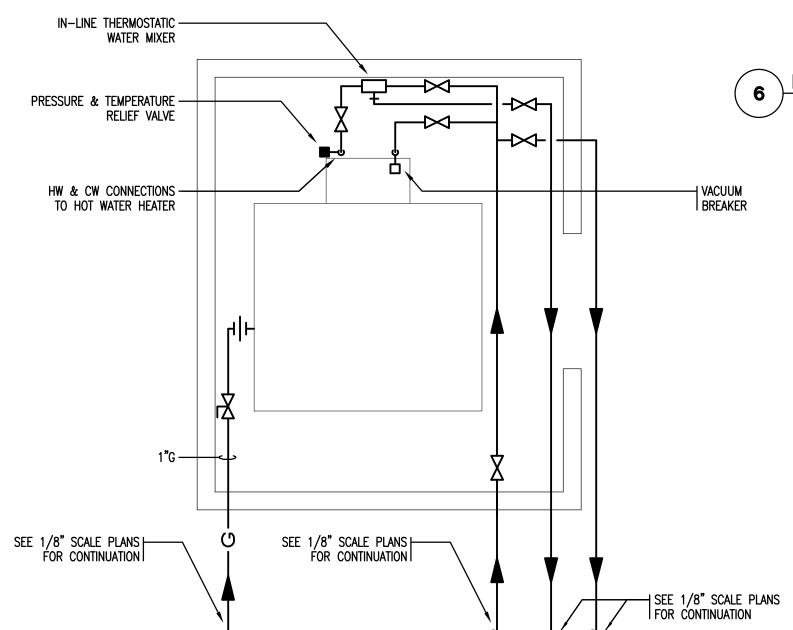

PLUMBING CONNECTIONS AT TYPICAL MECHANICAL ROOM - TOWNHOUSES ONLY N.T.S.

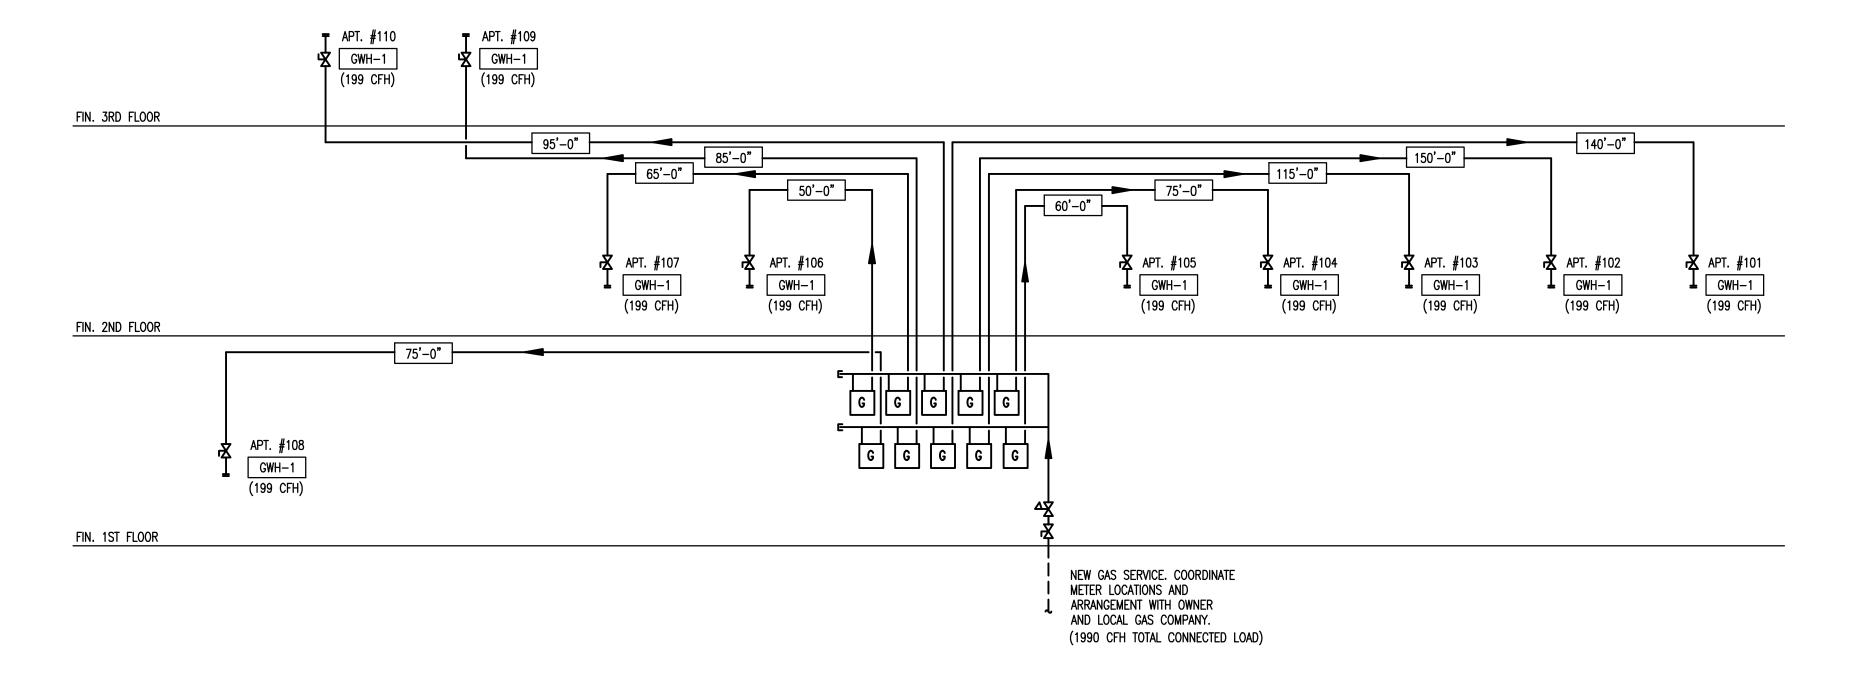

1 PLUMBING GAS RISER DIAGRAM
N.T.S.

Washington Village Phase 1

> 13 Day Street Building A

> > Norwalk, CT

Trinity Washington Village Limited Partnership

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PROJECT NO.: 21222/CENTEK #13232.01
DRAWN BY: SAO/TSP
CHECKED BY: FRC

SHEET TITLE

PLUMBING RISER DIAGRAMS

P-401

		SPRINKLER HEAD	SCHEDU	LE		
SYMBOL	TYPE	MODEL	K-FACTOR	FINISH AND TEMPERATURE	LOCATION	NOTES
<b>(4)</b>	RESIDENTIAL CONCEALED PENDENT	VIKING FREEDOM RESIDENTIAL CONCEALED PENDENT SPRINKLER W/WHITE COVER PLATE	4.9	165'F SPR/ 135' COVER	in noted areas	
⟨B⟩	RESIDENTIAL CONCEALED HORIZONTAL SIDEWALL	VIKING FREEDOM RESIDENTIAL CONCEALED HORIZONTAL SIDEWALL SPRINKLER W/WHITE COVER PLATE	4.0	165°F SPR/ 135° COVER	in noted areas	
$\Diamond$	HIGH TEMPERATURE UPRIGHT QUICK RESPONSE	RELIABLE F1FR	5.6	155'F	MECHANICAL ROOM	PROVIDE HIGH TEMPERATURE SPRINKLER WITH SPRINKLER CAGE.
<b>ⓑ</b>	DRY RECESSED HORIZONTAL SIDEWALL QUICK RESPONSE	RELIABLE F3QR DRY RECESSED HORIZONTAL WHITE POLYESTER COATED SIDEWALL SPRINKLER W/WHITE PAINTED ESCUTCHEON	5.6	155'F	EXTERIOR BALCONIES, GROUND FLOOR PATIOS	

FIRE PROTECTION LEGEND										
SYMBOL	ABBR.	DESCRIPTION								
SPR	SPR	SPRINKLER PIPING								
—— FP ——	FP	COMBINED FIRE PROTECTION PIPING								
● ○ ▶		NEW SPRINKLER HEAD								
<del></del> •		PIPE UP THRU SLAB OF FLOOR ABOVE								
		PIPE DOWN THRU FLOOR SHOWN								
		PIPE DROP								
		PIPE RISE								
Ŷ	FDC	FORGED STORZ FIRE DEPARTMENT CONNECTION								
۵		CONTROL VALVE WITH TAMPER SWITCH								
R	FDV	FIRE DEPARTMENT VALVE								
₽	FS	WATER FLOW SWITCH								
И		RUBBER FACED CHECK VALVE								
Ź		CHECK VALVE								
φ		PRESSURE GAUGE								
×		INSPECTOR'S TEST VALVE								

FLOW TEST DATA
STATIC :       78 PSI         RESIDUAL :       60 PSI         FLOW :       950 GPM         DATE :       5/5/2009
SOURCE OF INFO: SNEW  LOCATION: DAY ST & RICHMOND ST

#### FIRE PROTECTION GENERAL NOTES

- 1. DRAWINGS ARE DIAGRAMMATIC AND SHOW THE GENERAL INTENT OF WORK. SEE DETAILS, RISERS AND SPECIFICATIONS FOR ADDITIONAL INFORMATION.
- 2. COORDINATE WORK WITH PHASING SCHEDULE. ALL WORK TO OCCUR AT OWNER'S CONVENIENCE. NOTIFY OWNER WELL IN ADVANCE OF BEGINNING ANY PHASE OF WORK.
- 3. SPRINKLER HEADS IN AREAS SUBJECT TO EXCESSIVE TEMPERATURES SUCH AS THE AREA IMMEDIATELY AROUND HEATING EQUIPMENT AND OTHER HEAT PRODUCING EQUIPMENT SHALL BE OF THE HIGH TEMPERATURE TYPE.
- 4. IN AREAS WITHOUT FINISHED CEILINGS UPRIGHT SPRINKLER HEADS SHALL BE USED UNLESS OTHERWISE NOTED.
- 5. IN AREAS WITH FINISHED CEILINGS CONCEALED PENDENT SPRINKLERS SHALL BE USED UNLESS OTHERWISE NOTED. FLEX HEADS SHALL NOT BE USED.
- 6. THE FIRE PROTECTION CONTRACTOR SHALL REVIEW THE ARCHITECTURAL REFLECTED CEILING PLANS AS PART OF THIS CONTRACT FOR ADDITIONAL INFORMATION SUCH AS CEILING HEIGHTS, TYPES, SOFFITS AND/OR OTHER DEVICE LOCATIONS.
- THE FIRE PROTECTION CONTRACTOR SHALL REVIEW THE ELECTRICAL DIVISION DRAWINGS AND COORDINATE THE FIRE PROTECTION WORK WITH LOCATIONS OF LIGHTS, AND CEILING MOUNTED DEVICES WHICH MAY INTERFERE WITH SPRINKLER HEAD LOCATIONS OR SPRAY PATTERNS.
- 8. THE FIRE PROTECTION CONTRACTOR SHALL REVIEW THE HVAC DIVISION DRAWINGS AND COORDINATE THE FIRE PROTECTION WORK WITH LOCATIONS OF CEILING MOUNTED DEVICES SUCH AS DIFFUSERS, GRILLES, REGISTERS, AND ALSO THE LOCATIONS OF HEAT PRODUCING EQUIPMENT AND DUCTWORK REQUIRING SPRINKLER PROTECTION BELOW IT.
- 9. SPRINKLER CONTRACTOR SHALL SUBMIT SHOP DRAWINGS AND HYDRAULIC CALCULATIONS TO A/E OF RECORD. CONTRACTOR SHALL PERFORM HIS OWN UP—TO—DATE FLOW TEST TO HYDRAULICALLY CALCULATE THIS PROJECT.
- 10. IT IS THE INTENT OF THIS PROJECT TO CONCEAL ALL PIPING WHEREVER POSSIBLE.
- 11. ALL EXPOSED PIPING SHALL BE PRIME AND 2—COAT FINISH PAINTED. COLOR FOR EACH SPACE WILL BE SELECTED BY THE ARCHITECT.
- 12. THE FIRE PROTECTION CONTRACTOR SHALL DESIGN ALL SPRINKLER SYSTEMS IN EACH APARTMENT TO MEET THE REQUIREMENTS OF AN NFPA-13R (2002) SYSTEM.
- 13. THE FIRE PROTECTION CONTRACTOR SHALL VERIFY WITH THE LOCAL FIRE DEPARTMENT AND ARCHITECT FOR FINAL LOCATIONS OF ALL FIRE DEPARTMENT CONNECTIONS FOR EACH BUILDING PRIOR TO INSTALLATION.
- LAYOUT OF EACH APARTMENT. THE FIRE PROTECTION CONTRACTOR SHALL PROVIDE RESIDENTIAL SIDEWALL SPRINKLERS IN ALL AREAS THAT ARE BELOW UNHEATED ATTIC SPACES.

14. THE FIRE PROTECTION CONTRACTOR SHALL COORDINATE ALL SPRINKLER PIPING WITH THE STRUCTURAL

- 15. ALL ATTIC SPACES SHALL BE NON-ACCESSIBLE AND UNHEATED. A DRY SYSTEM SHALL NOT BE REQUIRED TO BE INSTALLED IN ANY ATTICS.
- 16. ALL PORCH AND BAY ROOFS SHALL BE REQUIRED TO HAVE DRY SPRINKLER PROTECTION.

#### SPRINKLER DESIGN CRITERIA

....250 GPM

TOTAL HOSE STREAM ALLOWANCE

(INSIDE & OUTSIDE) : .....

## Washington Village Phase 1

#### 13 Day Street Building A

Norwalk, CT

Trinity Washington Village Limited Partnership

the Norwalk Housing Authority



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MARK DATE DESCRIPTION

PROJECT NO.: 21222/CENTEK #13232.01
DRAWN BY: KNL
CHECKED BY: FRC

SHEET TITLE

FIRE PROTECTION NOTES, SCHEDULES AND LEGENDS

FP-000

#### FIRE PROTECTION WORK NOTES

ALL SPRINKLERS SHALL BE TYPE 'A' UNLESS NOTED OTHERWISE.

ALL SPRINKLER MAIN AND BRANCH PIPE SIZES SHALL BE BASED UPON HYDRAULIC CALCULATIONS PERFORMED BY FIRE PROTECTION CONTRACTOR.

GENERAL NOTE:

—APPROXIMATE LOCATION FOR CHECK VALVE ACCESS PANEL.

3BR<sub>+</sub>2-1/2"

3BR LOWER 102 657 sq ft

1. COORDINATE ALL WORK WITH ALL OTHER TRADES. REFER TO OTHER TRADE'S DRAWINGS FOR ADDITIONAL INFORMATION.

## Washington Village Phase 1

13 Day Street Building A

Norwalk, CT

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the Norwalk Housing Authority



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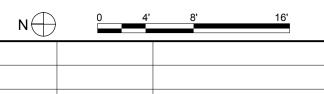
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MARK DATE DESCRIPTION

PROJECT NO.: 21222/CENTEK #13232.01

DRAWN BY: KNL
CHECKED BY: FRC

SHEET TITLE

BUILDING A FIRST FLOOR PLAN - FIRE PROTECTION

PROJECT NORTH

FIRST FLOOR PLAN - FIRE PROTECTION

SCALE: 1/8"=1'-0"

**4BR LOWER** 103 625 sq ft

4" FIRE SERVICE FROM HANFORD PLACE

SPRINKLER RISER UP

**4BR LOWER** 104 627 sq ft

**4BR LOWER** 105 626 sq ft

**2BR FLAT** TYPE A 108

1,069 sq ft

3BR LOWER 107

627 sq ft

**4BR LOWER** 106

622 sq ft

#### FIRE PROTECTION WORK NOTES

- ALL SPRINKLERS SHALL BE TYPE 'A' UNLESS NOTED OTHERWISE.
- ALL SPRINKLER MAIN AND BRANCH PIPE SIZES SHALL BE BASED UPON HYDRAULIC CALCULATIONS PERFORMED BY FIRE PROTECTION CONTRACTOR.

GENERAL NOTE:

. COORDINATE ALL WORK WITH ALL OTHER TRADES. REFER TO OTHER TRADE'S DRAWINGS FOR ADDITIONAL INFORMATION.

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11-18-2013 40% CHFA 09-19-2013 CAM/ SPECIAL PERMIT MARK DATE DESCRIPTION

PROJECT NO.: 21222/CENTEK #13232.01 DRAWN BY: KNL

CHECKED BY: FRC

SHEET TITLE

BUILDING A SECOND FLOOR PLAN - FIRE PROTECTION

3BR MID 103 625 sq ft 602 sq ft SECOND FLOOR PLAN - FIRE PROTECTION

SCALE: 1/8"=1'-0"

**3BR MID** 101

SPRINKLER RISER DN

4BR MID 104 623 sq ft

626 sq ft

**4BR MID** 106

622 sq ft

3BR MID

**2BR DUPLEX** 

638 sq ft

#### FIRE PROTECTION WORK NOTES

ALL SPRINKLERS SHALL BE TYPE 'B' UNLESS OTHERWISE NOTED. ALL SPRINKLER MAIN AND BRANCH PIPE SIZES SHALL BE BASED UPON HYDRAULIC CALCULATIONS PERFORMED BY FIRE PROTECTION CONTRACTOR.

GENERAL NOTE:

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# Washington Village Phase 1

13 Day Street Building A

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SHEET TITLE


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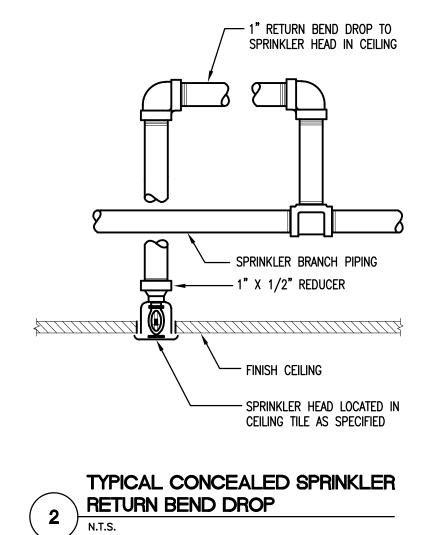
**BUILDING A** THIRD FLOOR PLAN - FIRE PROTECTION





THIRD FLOOR PLAN - FIRE PROTECTION

SCALE: 1/8"=1'-0"



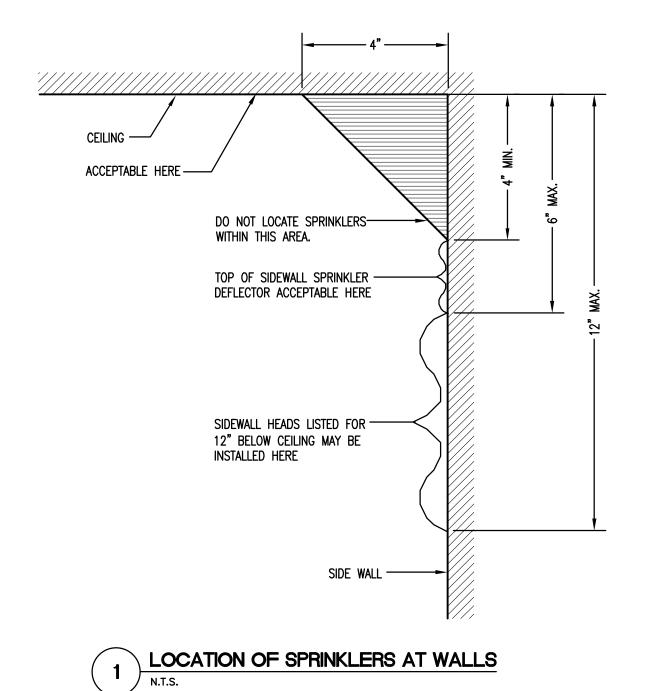

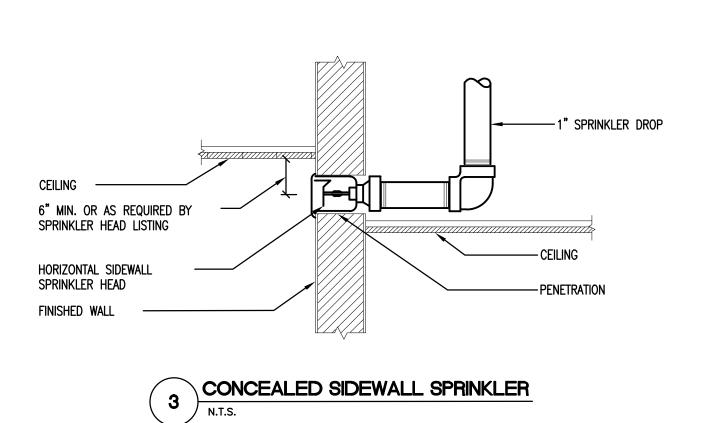

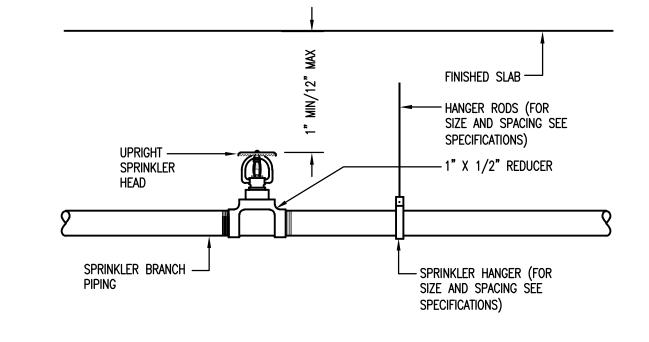

4 TYPICAL UPRIGHT SPRINKLER

N.T.S.

FLOOR

FLOOR

BECHANICAL JOINTS WITH

RETMANER GLANUS

CONCRETE THRUST

BROX SEE DETMI.

UNDISTURBED EARTH

JP.S. STEEL SLEINE

DROP FOOTING AS REQUIRED

DROP FOOTING AS REQUIRED


THE SERVICE ENTRANCE DETAIL.

TO STEEL SLEINE

THE SERVICE ENTRANCE DETAIL.

TO STEEL SLEINE

THE SERVICE ENTRANCE DETAIL.

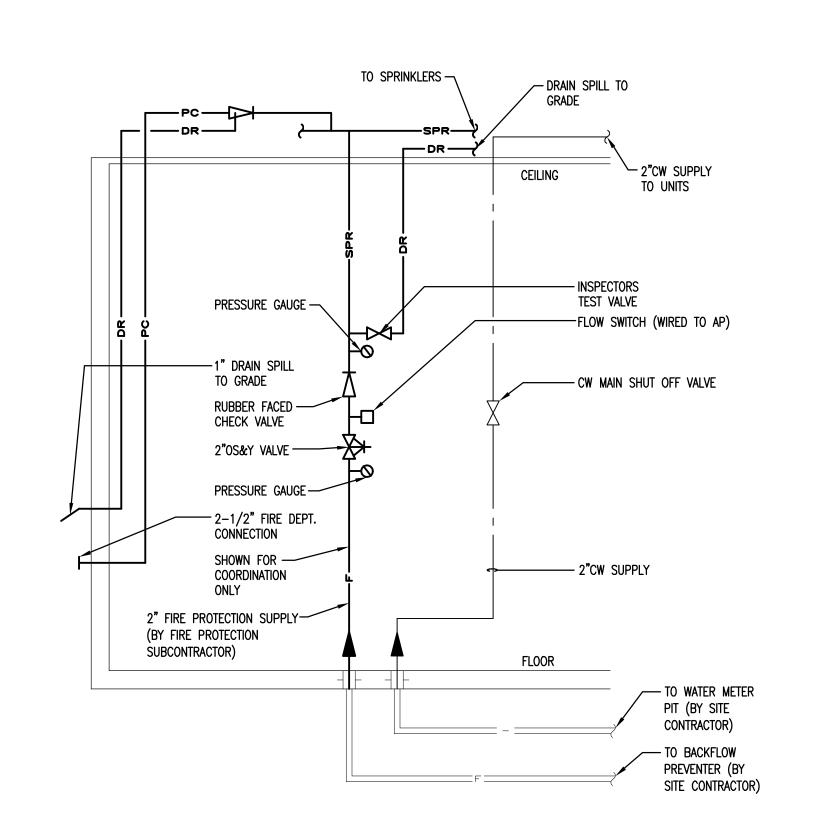

TYPICAL BLDG. 'A' MAIN SHUT-OFF VALVE ASSEMBLIES
WITH METER PIT (DOMESTIC AND FIRE PROTECTION WATER)

N.T.S.

Washington Village Phase 1

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PROJECT NO.: 21222/CENTEK #13232.01

MARK DATE DESCRIPTION

DRAWN BY: KNL CHECKED BY: FRC

SHEET TITLE

FIRE PROTECTION DETAILS

FP-200

							AIR I	HANI	DLING	G UN	IT SC	HEC	DULE	=					
			F/	AN		МС	OTOR DATA	A @ 60	HZ	H	IOT WATE	R COIL @	70°F EA	ΛT		OX COOLING CO	IL		
UNIT NUMBER	LOCATION	SPEED SETTING	CFM	RPM	EXT SP	HP	RPM	VOLTS	PHASE	MBH	EWT *F	LWT *F	GPM	△PRESS FT. H <sub>2</sub> 0	TOTAL MBH	SENS MBH	EAT DB/WB (DEG F)	NOTES	EMER POWER
AHU-1	SEE PLANS	Н	650	VAR.	0.5	-	VAR.	120	1	25	140	120	_	_	18	-	80/67	1,4,5	NO
AHU-2	SEE PLANS	Н	700	VAR.	0.5	-	VAR.	120	1	34	140	120	-	-	24	-	80/67	1,4,5	NO
AHU-3	SEE PLANS	Н	900	VAR.	0.5	-	VAR.	120	1	42	140	120	-	-	30	-	80/67	1 <b>,4,</b> 5	-
AHU-4	SEE PLANS	Н	600	VAR.	0.5	-	VAR.	120	1	25	140	120	_	1	18	-	80/67	2,4,5	_
AHU-5	SEE PLANS	Н	800	VAR.	0.5	-	VAR.	120	1	34	140	120	_	_	24	-	80/67	2,4,5	-
AHU-6	SEE PLANS	Н	1200	VAR.	0.5	-	VAR.	120	1	50	140	120	_	_	36	-	80/67	2,4,5	-
AHU-7	SEE PLANS	Н	300	VAR.	0.5	1	VAR.	120	1	14	140	120	_	_	9.5	-	80/67	1,4,5	-
AHU-8	SEE PLANS	Н	1100	VAR.	0.5	-	VAR.	120	1	50	140	120	_	-	36	-	80/67	1,4,5	_
AHU-9	SEE PLANS	Н	1400	VAR.	0.5	-	VAR.	120	1	68	140	120	_	-	48	-	80/67	1,4,5	_
AHU-10	SEE PLANS	Н	650	VAR.	0.5	-	VAR.	120	1	68	140	120	_	-	48	-	80/67	3,4,5	_

1. UNIT SIMILAR TO DAIKIN FXMQ\_P SERIES (AHU EFFICIENCY RATING SHALL BE 15 SEER MIN. WHEN COMBINED WITH CONDENSING UNIT)

2. UNIT SIMILAR TO DAIKIN FXTQ SERIES (AHU EFFICIENCY RATING SHALL BE 15 SEER MIN. WHEN COMBINED WITH CONDENSING UNIT)

3. UNIT SIMILIAR TO DAIKIN FXMQ\_MFVJU SERIES.

4. HIGH STATIC MOTOR REQUIRED. 5. PROVIDE WITH MERV 6 FILTER.

AIR COOLED CONDENSING UNIT SCHEDULE													
SYMBOL	MAKE	MODEL NUMBER	TYPE	SYSTEM SERVED	TOTAL CAP. MBH	SUCTION TEMP	AMB AIR TEMP DEG F	ELECTRICAL DATA VOLT/PH	NOTES				
CU-1	DAIKIN	RXYMQ36	AC	SEE PLANS	36	42.5	91.0	208/1	ALL				
CU-2	DAIKIN	RXYMQ48	AC	SEE PLANS	48	42.5	91.0	208/1	ALL				

1. SELECTIONS BASED ON DAIKIN (15 SEER CONDENSING UNIT MIN.)

2. PROVIDE WITH LIQUID & SUCTION LINE, FILTER DRYERS, SIGHT GLASS AND ALL OTHER REFRIGERANT SPECIALTIES.

3. PROVIDE WITH REFRIGERANT SOLENOID VALVE 4. PROVIDE WITH ANTI SHORT CYCLE TIMER

5. PROVIDE WITH RUBBER ISOLATORS

6. PROVIDE WITH LOW PRESSURE SWITCH.

									FAN	SCH	EDUL	_E							
Ī							WHEEL			MOTOR	DATA @	60 HZ							
	UNIT NUMBER	LOCATION	SERVICE	CFM	S.P. (IN. H <sub>2</sub> 0)	O) FAN RPM	DIAMETER (IN.)	CLASS	MBHP	MHP	RPM	AMPS	VOLTS	PHASE	INLET VANES	FAN TYPE	SIMILAR TO	NOTES	EMER POWER
ĺ	EX-1	BATHROOM	BATHROOM	75	.25	-	-	-	_	_	_	0.17	120	1	NO	CEILING	PANASONIC FV-08VQ5	1,2,3	NO
	EX-2	BATHROOM	BATHROOM	75	.25	-	_	_	_	_	_	0.17	120	1	NO	CEILING	PANASONIC FV-08VQ5	2,3	NO

. PANASONIC FAN TO BE CONTROLLED BY AUBE SWITCH.

2. PROVIDE PREMIUM EFFICIENCY MOTOR. 3. FAN SHALL BE ENERGY STAR RATED.

								UNI	T HE	ATE	RSC	HED	ULE							
			F	AN		М	OTOR DAT	A @ 60	HZ		HOT WAT	TER COIL		STEAM	COIL	ELECTR	IC COIL		SEE	
UNIT NUMBER	LOCATION	SPEED SETTING	CFM	RPM	EXT SP	HP	RPM	VOLTS	PHASE	EWT *F	LWT *F	GPM	△PRESS FT. H <sub>2</sub> 0	INLET PSIG	#/HR	VOLTS	KW	SIMILAR TO	NOTES BELOW	EMER POWER
UH-1	SEE PLANS	Н	53	3200	-	31W	3200	115	1	140	120	1	.17	-	-	-	-	BEACON MORRIS W-42	1,3	NO
UH-3	SEE PLANS	Н	1800	1000	_	1/12	1000	115	1	140	120	7.9	.36	ı	-	1	-	BEACON MORRIS HB-108	1	NO
UH-4	SEE PLANS	Н	103	3200	_	31W	3200	115	1	140	120	1	.22	ı	-	-	-	BEACON MORRIS W-84	1	NO
UH-5	SEE PLANS	Н	103	3200	_	31W	3200	115	1	_	_	_	_	-	_	_	_	QMARK	1	NO

1. PROVIDE WITH REMOTE MOUNTED THERMOSTAT.

2. PROVIDE WITH RECESSED MOUNTING ENCLOSURE AND COVER.

	(HOT WATER) FINNED TUBE RADIATION SCHEDULE												
UNIT NO.	MIN CAPACITY BTUH/LIN. FOOT	AWT ° F	PIPE SIZE	FIN SIZE	FINS FOOT	NO. OF ELEMENTS	SELECTION BASED ON	REMARKS	ENCLOSURE HEIGHT	CONSTR. GAUGE			
А	1115	130	3/4"	4-1/4"x4-1/4"	50	3	AIRDALE S-24-16-0	ALL	24	16			


1. FACTORY APPLIED POWER COATED BAKED ENAMEL FINISH. COLOR TO BE SELECTED BY ARCHITECT. 2. PROVIDE ALL TRIMS, END CAPS, CORNERS AND ACCESS PANELS AS REQUIRED.


	EXPANSION/COMPRESSION TANK SCHEDULE													
UNIT NUMBER	LOCATION	SYSTEM SERVED	initial Charge (PSIG)	TANK CAPACITY (GALLONS)	STYLE	TANK LENGTH (IN.) X DIA. (IN.)	TANK FITTING	RELIEF VALVE SETTING	REDUCING VALVE SETTING	NOTES				
TK-1	MECHANICAL RM (UNITS)	HOT WATER	12	2	VERT	12 5/8"x 8"	-	20 PSIG	12 PSIG					

HVAC GENERAL NOTES

GENERAL NOTES APPLICABLE TO ALL HVAC DRAWINGS

- 1. ALL DUCTWORK PENETRATING FIRE RATED WALLS SHALL HAVE FIRE DAMPERS AT EACH PENETRATION.
- 2. ALL DUCTWORK PENETRATING RATED FLOOR SLABS SHALL HAVE FIRE DAMPERS DAMPERS AT EACH PENETRATION.
- 3. EXACT LOCATION OF CEILING DIFFUSER, GRILLES, REGISTERS, ETC. TO BE COORDINATED WITH REFLECTED CEILING
- 4. MINIMUM PIPING RUNOUTS TO REHEAT COILS SHALL BE 3/4".
- 5. HVAC CONTRACTOR SHALL PROVIDE ALL SHEET METAL AND PIPING TRANSITIONS TO DIFFUSERS, TERMINAL BOXES, COILS AND OTHER SIMILAR HVAC EQUIPMENT.
- 6. FOR EQUIPMENT QUANTITIES SCHEDULED, SEE PLANS. SCHEDULES DO NOT INDICATE EXACT QUANTITIES.
- 7. ALL EQUIPMENT SHALL BE INSTALLED IN ACCORDANCE WITH MANUFACTURER'S APPROVED PUBLISHED LITERATURE.
- 8. PROVIDE INSTRUMENTAL TEST HOLES IN DUCTWORK WHEREVER VOLUME DAMPERS ARE REQUIRED.
- 9. ALL WORK UNDER THIS SECTION SHALL BE COORDINATED WITH ALL OTHER TRADES BEFORE ANY INSTALLATION IS
- 10. EXACT LOCATIONS OF THERMOSTATS TO BE COORDINATED WITH ALL OTHER TRADES BEFORE ANY INSTALLATION IS
- 11. ALL EXPOSED EQUIPMENT (REGISTERS, GRILLES, DIFFUSERS, UNIT HEATERS, ETC.) SHALL HAVE COLORS SELECTED BY THE ARCHITECT UNLESS OTHERWISE NOTED. SEE SPECIFICATIONS.
- 12. ALL EQUIPMENT SHALL BE INSTALLED IN SUCH A WAY SO THAT LIGHTS DO NOT BLOCK ACCESS TO UNITS AND RELATED ACCESSORIES.
- 13. FURNISH ALL ACCESS PANELS FOR VALVES AND DAMPERS IN WALLS, CEILING AND FLOORS AS REQUIRED PER PLANS AND SPECIFICATIONS. ACTUAL NUMBERS TO BE FIELD DETERMINED — LOCATIONS TO BE APPROVED BY
- 14. ALL CONDENSATION DRAIN PIPING SHALL BE EQUIPPED WITH CLEANOUTS AT THE ENDS OF ALL HORIZONTAL MAINS, AT BASE OF EACH RISER AND AT EACH CHANGE OF DIRECTION.
- 15. ALL STRAINER/RELIEF VALVE DISCHARGE PIPING SHALL RUN TO 12" ABOVE NEAREST FLOOR DRAIN.
- 16. BRANCH DUCTS SERVING SUPPLY, RETURN OR EXHAUST GRILLES SHALL BE 2" LARGER (WIDER) THAN GRILLE NECK SIZE UNLESS NOTED OTHERWISE.
- 17. PROVIDE FLOW METERING STATIONS FOR HOT WATER PIPING TO FACILITATE HYDRONIC BALANCING AT EACH PUMP, AND ALL MAINS LEAVING MECHANICAL ROOMS. UNITS SHALL BE COMPLETE WITH BALANCING VALVES WITH MEMORY
- 18. PROVIDE SEPARATE PROGRAMMABLE ENERGY STAR RATED THERMOSTAT FOR EACH ZONE INDICATED ON THE
- 19. PROVIDE 3/4" DRAIN VALVE WITH HOSE CONNECTION, CAP AND CHAIN AT BASE OF ALL PIPE RISERS AND SYSTEM LOW POINTS AND MANUAL AIR VENTS AT TOP OF ALL RISERS AND SYSTEM HIGH POINTS.
- 20. COORDINATE ALL STRUCTURAL SUPPORT PAD REQUIREMENTS WITH ARCHITECTURAL DRAWINGS FOR ALL EQUIPMENT REQUIRING SAME.
- 21. COORDINATE ALL WATER MAKEUP AND DRAIN REQUIREMENTS WITH PLUMBING DRAWINGS FOR ALL EQUIPMENT
- 22. COORDINATE ALL MOTOR, STARTER, DISCONNECT AND SMOKE DETECTOR REQUIREMENTS WITH ELECTRICAL DRAWINGS FOR ALL EQUIPMENT REQUIRING SAME.
- 23. DUCT DIMENSIONS SHOWN ON PLANS REFER TO INSIDE CLEAR DIMENSIONS.
- 24. PROVIDE ALL PIPE AND DUCT CONNECTIONS TO EQUIPMENT INDICATED ON THE ARCHITECTURAL DRAWINGS AND FOR EQUIPMENT FURNISHED NEW BY THE OWNER. COORDINATE REQUIREMENTS WITH ARCHITECT, OWNER & CONSTRUCTION MANAGER. REVIEW ALL DRAWINGS FOR THESE REQUIREMENTS AND ASCERTAIN THE EXACT SCOPE IN THE FIELD PRIOR TO SUBMITTING BIDS.
- 25. ALL AIR DEVICES PENETRATING CEILING/FLOOR OR CEILING/ROOF RATED ASSEMBLIES SHALL BE PROVIDED WITH CEILING RADIATION DAMPER INSTALLED IN ACCORDANCE WITH MANUFACTURER AND UL LISTING REQUIREMENTS

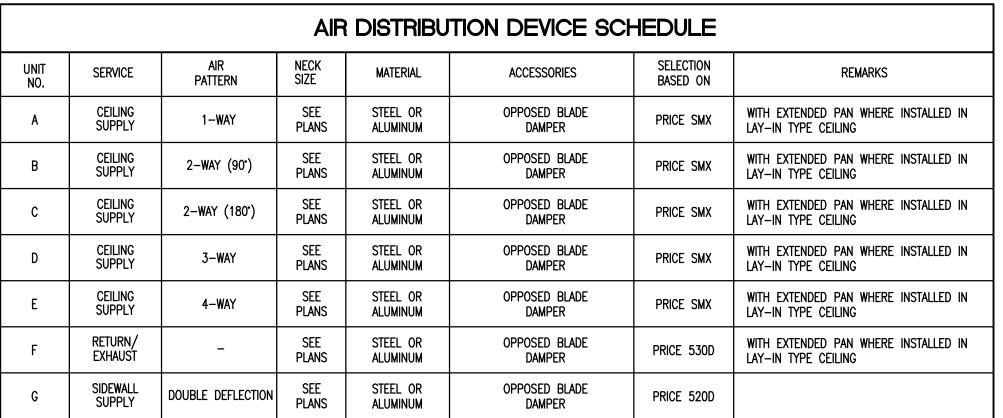

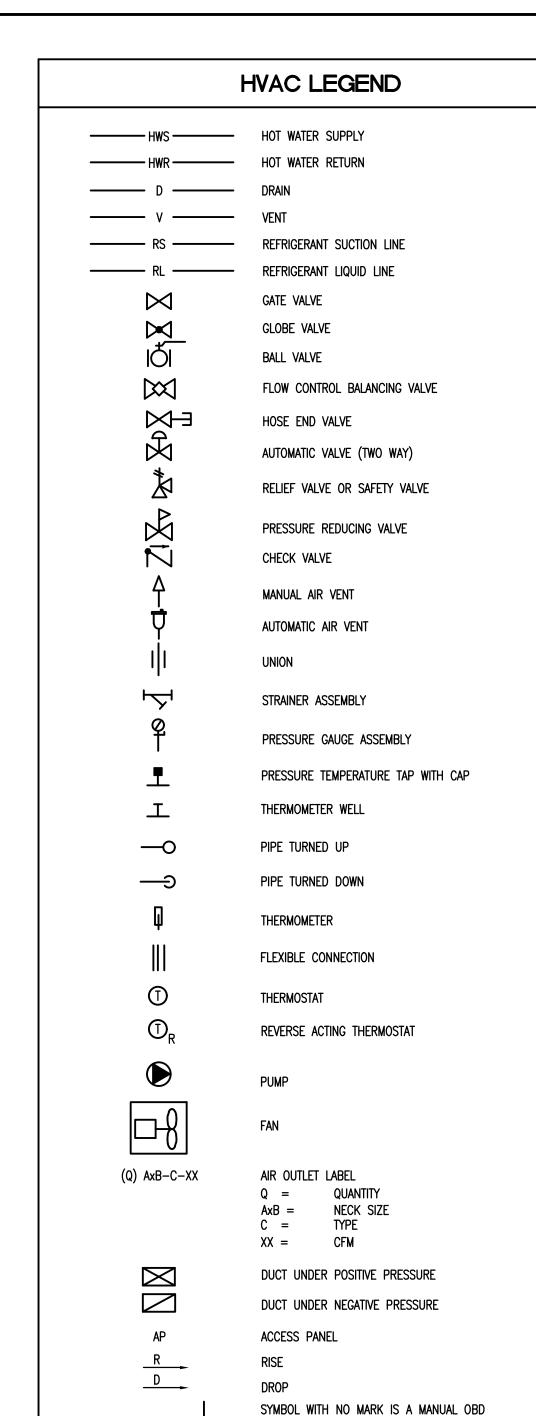

FD FIRE DAMPER

DETAIL REFERENCE (DETAIL "X"


SECTION MARK (SECTION "X"

ON DRAWING "Z")

ON DRAWING "Z")

—— — REFERENCE LINE

AD AUTOMATIC DAMPER BDD BACK DRAFT DAMPER

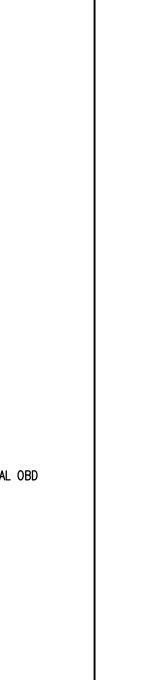



13 Day Street Building A

Norwalk, CT

Trinity Washington Village Limited Partnership

the Norwalk Housing Authority



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09-15-2014 PERMIT/ PRICING 06-13-2014 PRICING 11-18-2013 40% CHFA

09-19-2013 CAM/ SPECIAL PERMIT MARK DATE DESCRIPTION

PROJECT NO.: 21222/CENTEK #13232.01 DRAWN BY: KHS CHECKED BY: FRC

SHEET TITLE

HVAC LEGEND, NOTES AND SCHEDULES

#### HVAC WORK NOTES

1 PROVIDE AND INSTALL REFRIGERANT PIPING AND CONTROL WIRING TO RESPECTIVE AIR HANDLING UNITS. PROVIDE ALL BRACKETS, SLEEVES AND SUPPORTS REQUIRED FOR INSTALLATION.

GENERAL CONTRACTOR SHALL PROVIDE 4" CONCRETE
HOUSEKEEPING PAD FOR EACH UNIT. FINAL LOCATIONS SHALL
BE APPROVED BY ARCHITECT/ENGINEER PRIOR TO INSTALLATION.

GENERAL NOTE:

. COORDINATE ALL WORK WITH ALL OTHER TRADES. REFER TO OTHER TRADE'S DRAWINGS FOR ADDITIONAL INFORMATION.

## Washington Village Phase 1

#### 13 Day Street Building A

Norwalk, CT

Trinity Washington Village Limited Partnership

the Norwalk Housing Authority



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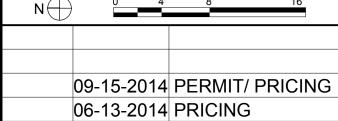
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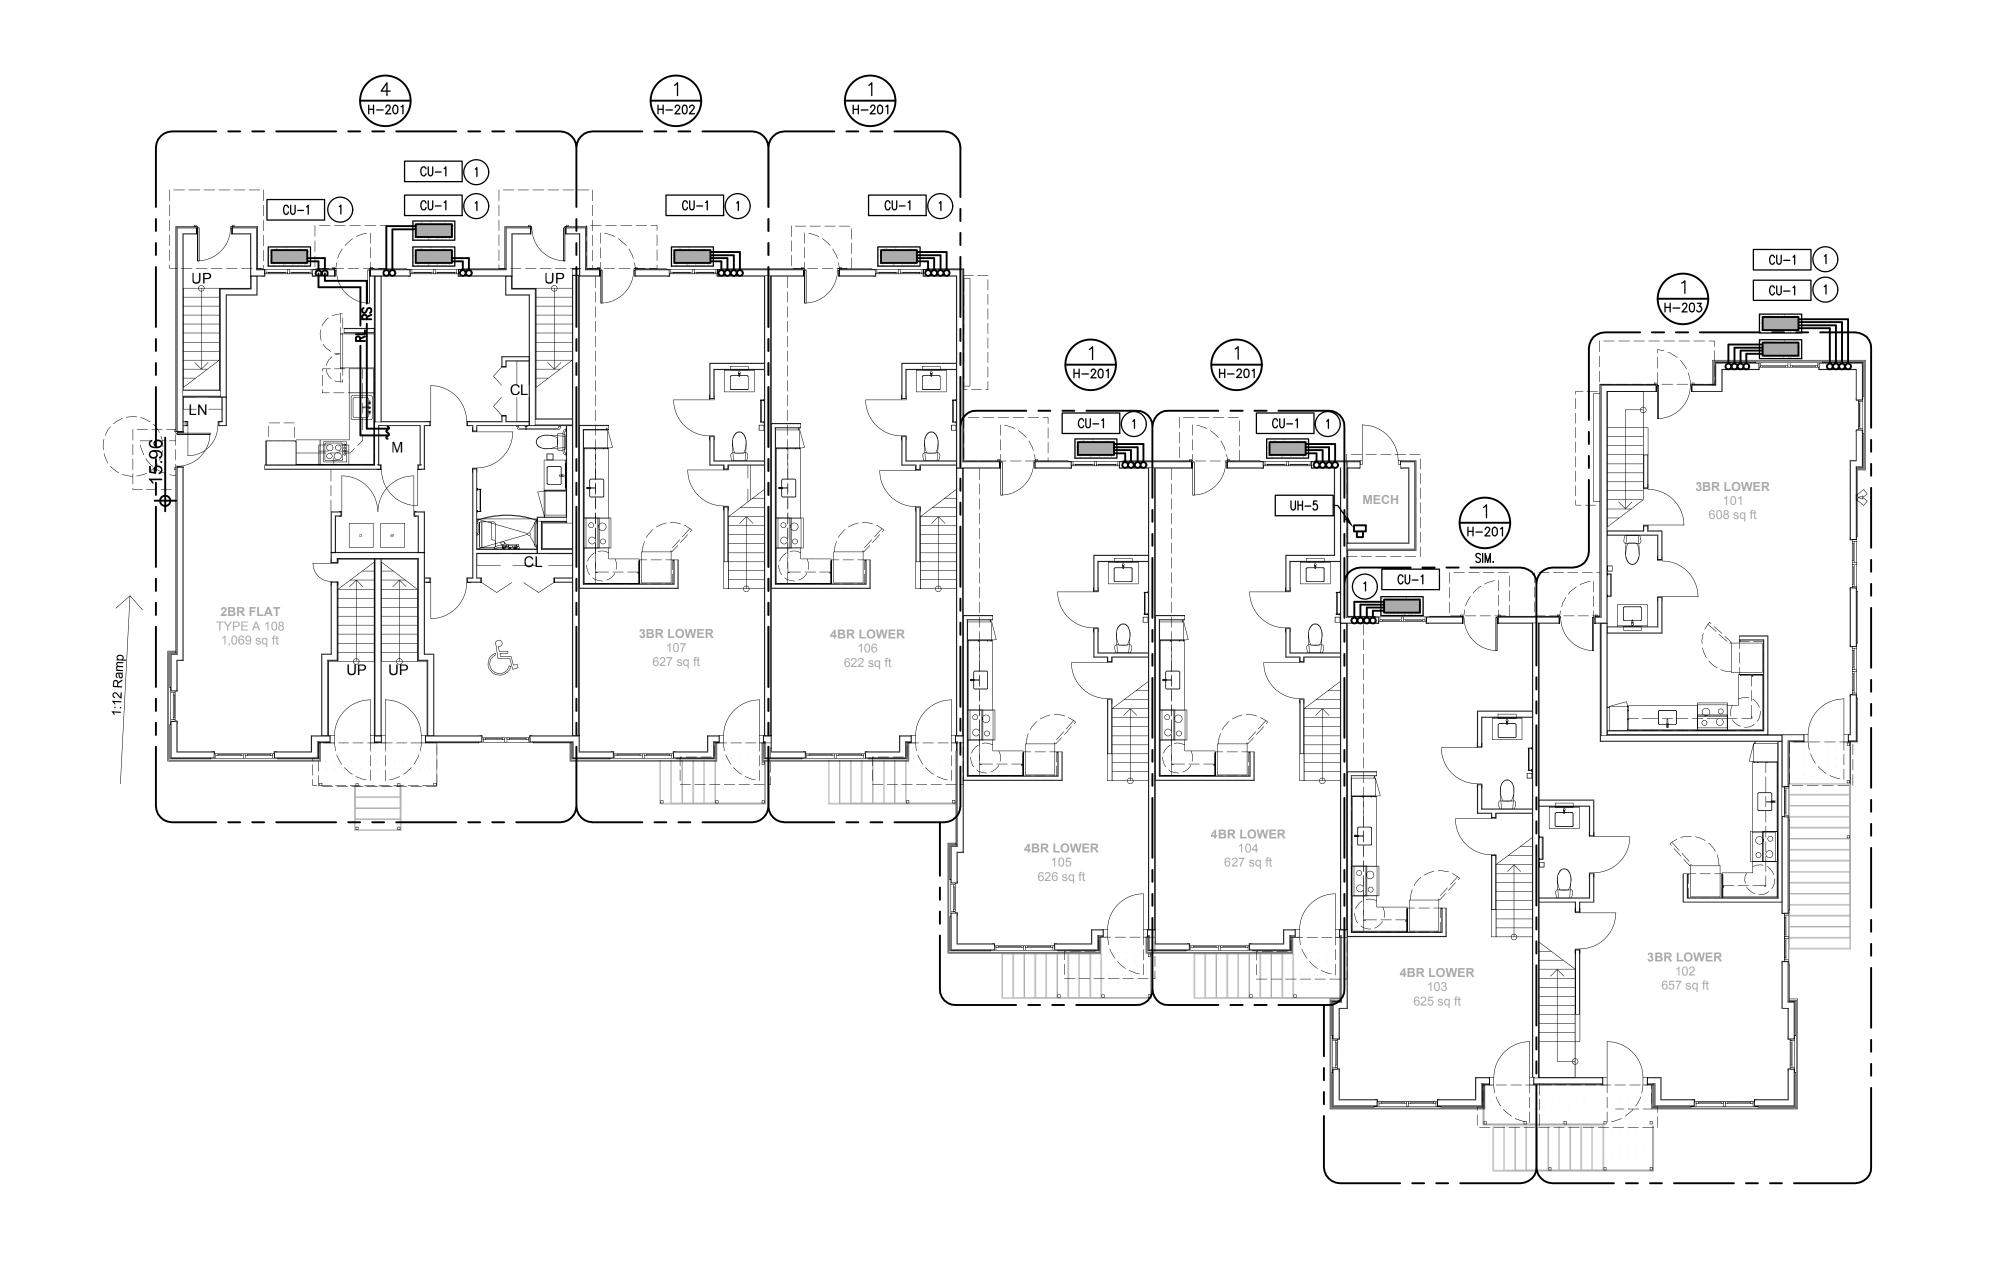
11-18-2013 40% CHFA
09-19-2013 CAM/ SPECIAL PERMIT
MARK DATE DESCRIPTION

PROJECT NO.: 21222/CENTEK #13232.01
DRAWN BY: KHS
CHECKED BY: FRC

SHEET TITLE

BUILDING A FIRST FLOOR PLAN - HVAC

PROJECT NORTH



1 FIRST FLOOR PLAN - HVAC

SCALE: 1/8"=1'-0"

TWO (2) SETS OF REFRIGERANT PIPING RSL & RLL UP FROM CONDENSING UNIT ON FIRST FLOOR UP IN WALL. (TYPICAL ALL UNITS)

ONE SET OF REFRIGERANT PIPING RSL & RLL UP FROM CONDENSING UNIT ON FIRST FLOOR UP IN WALL.

GENERAL NOTE:

. COORDINATE ALL WORK WITH ALL OTHER TRADES. REFER TO OTHER TRADE'S DRAWINGS FOR ADDITIONAL INFORMATION.

## Washington Village Phase 1

13 Day Street Building A

Norwalk, CT

Trinity Washington Village Limited Partnership

the Norwalk Housing Authority



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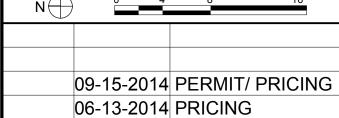
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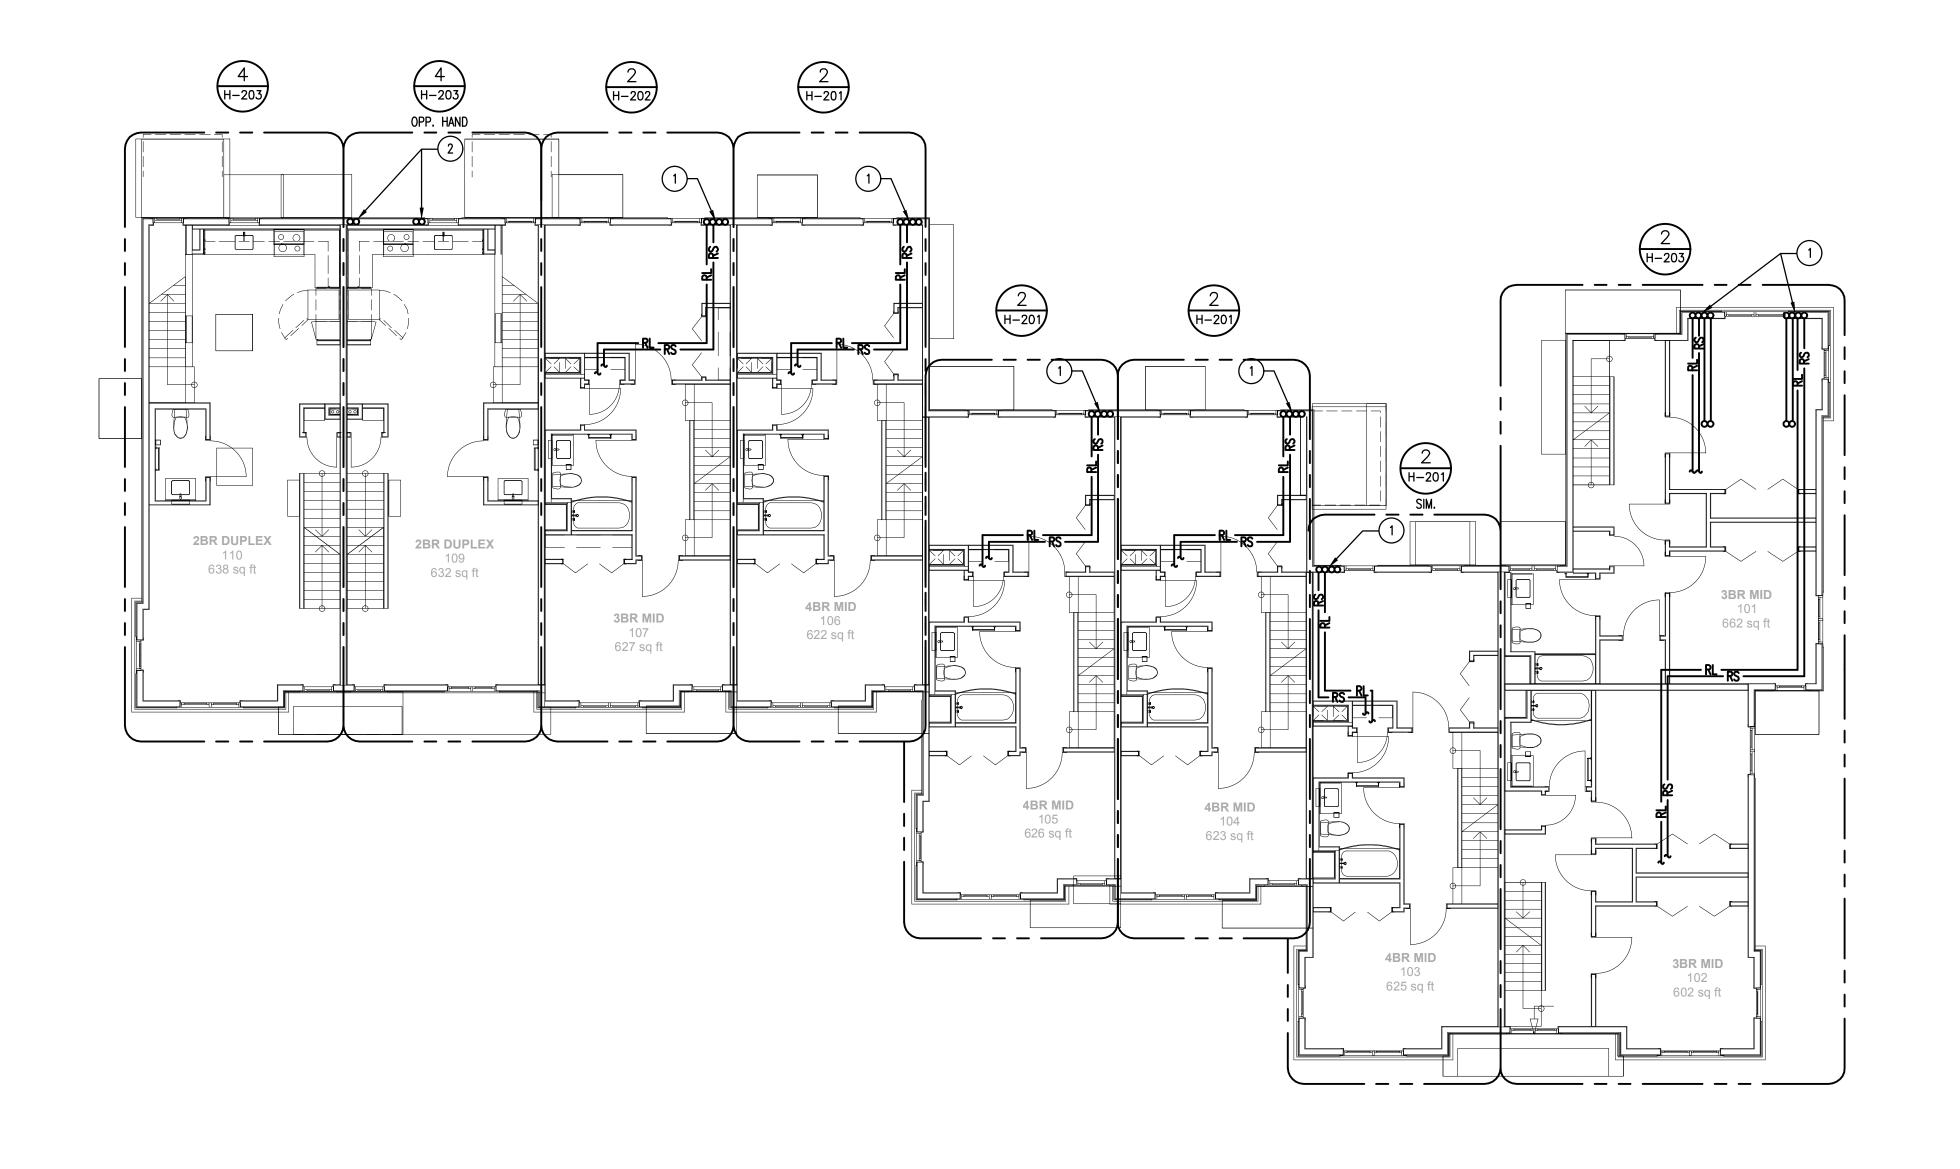
PROJECT NO.: 21222/CENTEK #13232.01 DRAWN BY: KHS

SHEET TITLE

CHECKED BY: FRC

BUILDING A SECOND FLOOR PLAN - HVAC

PROJECT NORTH



SECOND FLOOR PLAN - HVAC

SCALE: 1/8"=1'-0"

#### HVAC WORK NOTES

1 TWO (2) SETS OF REFRIGERANT PIPING RSL & RLL UP FROM CONDENSING UNIT ON FIRST FLOOR UP IN WALL. (TYPICAL ALL UNITS)

2 HOT WATER HEATER CONCENTRIC VENT UP THRU ROOF.

GENERAL NOTE:

3 H-203 1. COORDINATE ALL WORK WITH ALL OTHER TRADES. REFER TO OTHER TRADE'S DRAWINGS FOR ADDITIONAL INFORMATION.

## Washington Village Phase 1

#### 13 Day Street Building A

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11-18-2013 40% CHFA 09-19-2013 CAM/ SPECIAL PERMIT

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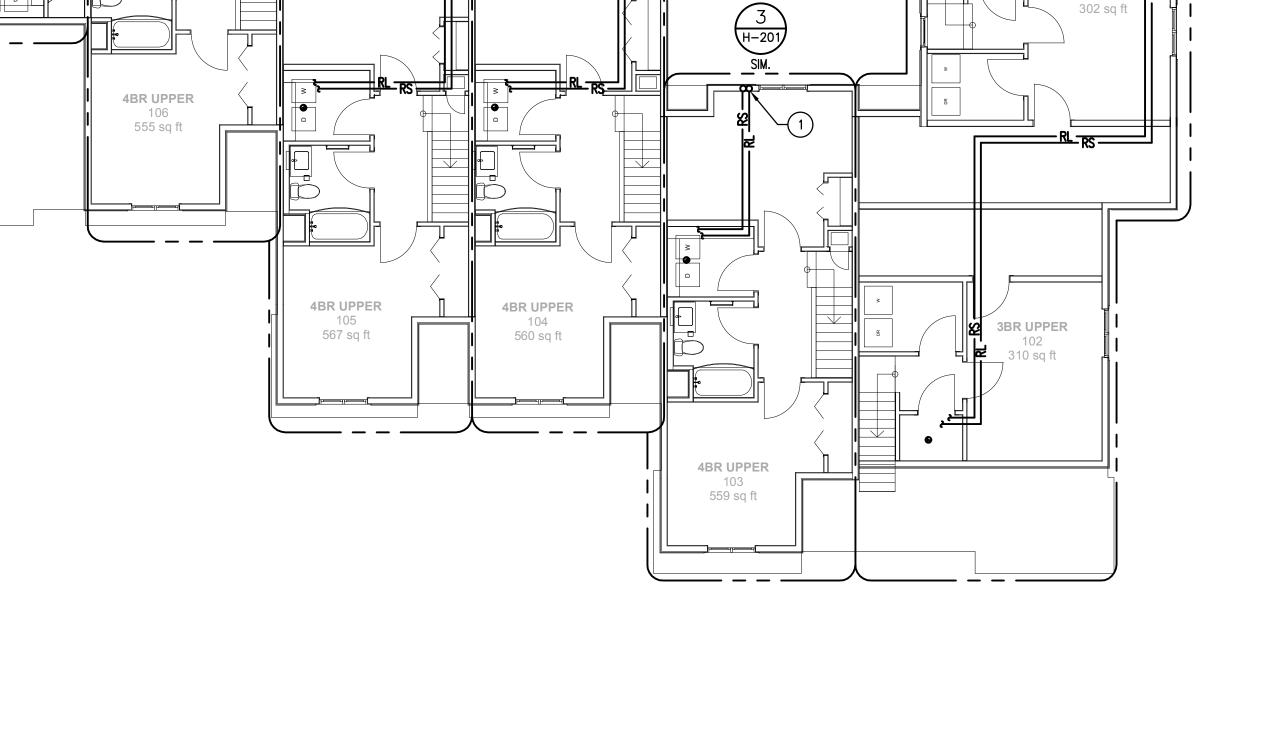
PROJECT NO.: 21222/CENTEK #13232.01

DRAWN BY: KHS
CHECKED BY: FRC

SHEET TITLE

BUILDING A THIRD FLOOR PLAN - HVAC

PROJECT NORTH



1 THIRD FLOOR PLAN - HVAC

SCALE: 1/8"=1'-0"

3 H-201

> 3 H-201 SIM.

**3BR UPPER** 107

348 sq ft

(TYPICAL)

2BR DUPLEX

584 sq ft

5 H-203

2BR DUPLEX

110 576 sq ft

1 HOT WATER HEATER CONCENTRIC VENT THRU ROOF.

2 4" DRYER VENT THRU ROOF WITH VENT CAP.

GENERAL NOTE:

1. COORDINATE ALL WORK WITH ALL OTHER TRADES. REFER TO OTHER TRADE'S DRAWINGS FOR ADDITIONAL INFORMATION.



# Washington Village Phase 1

# 13 Day Street Building A

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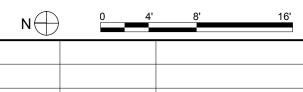
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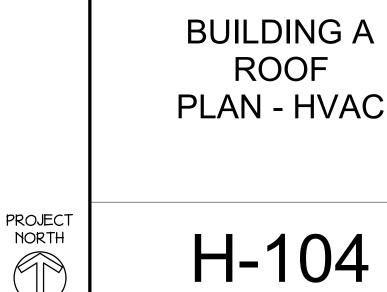
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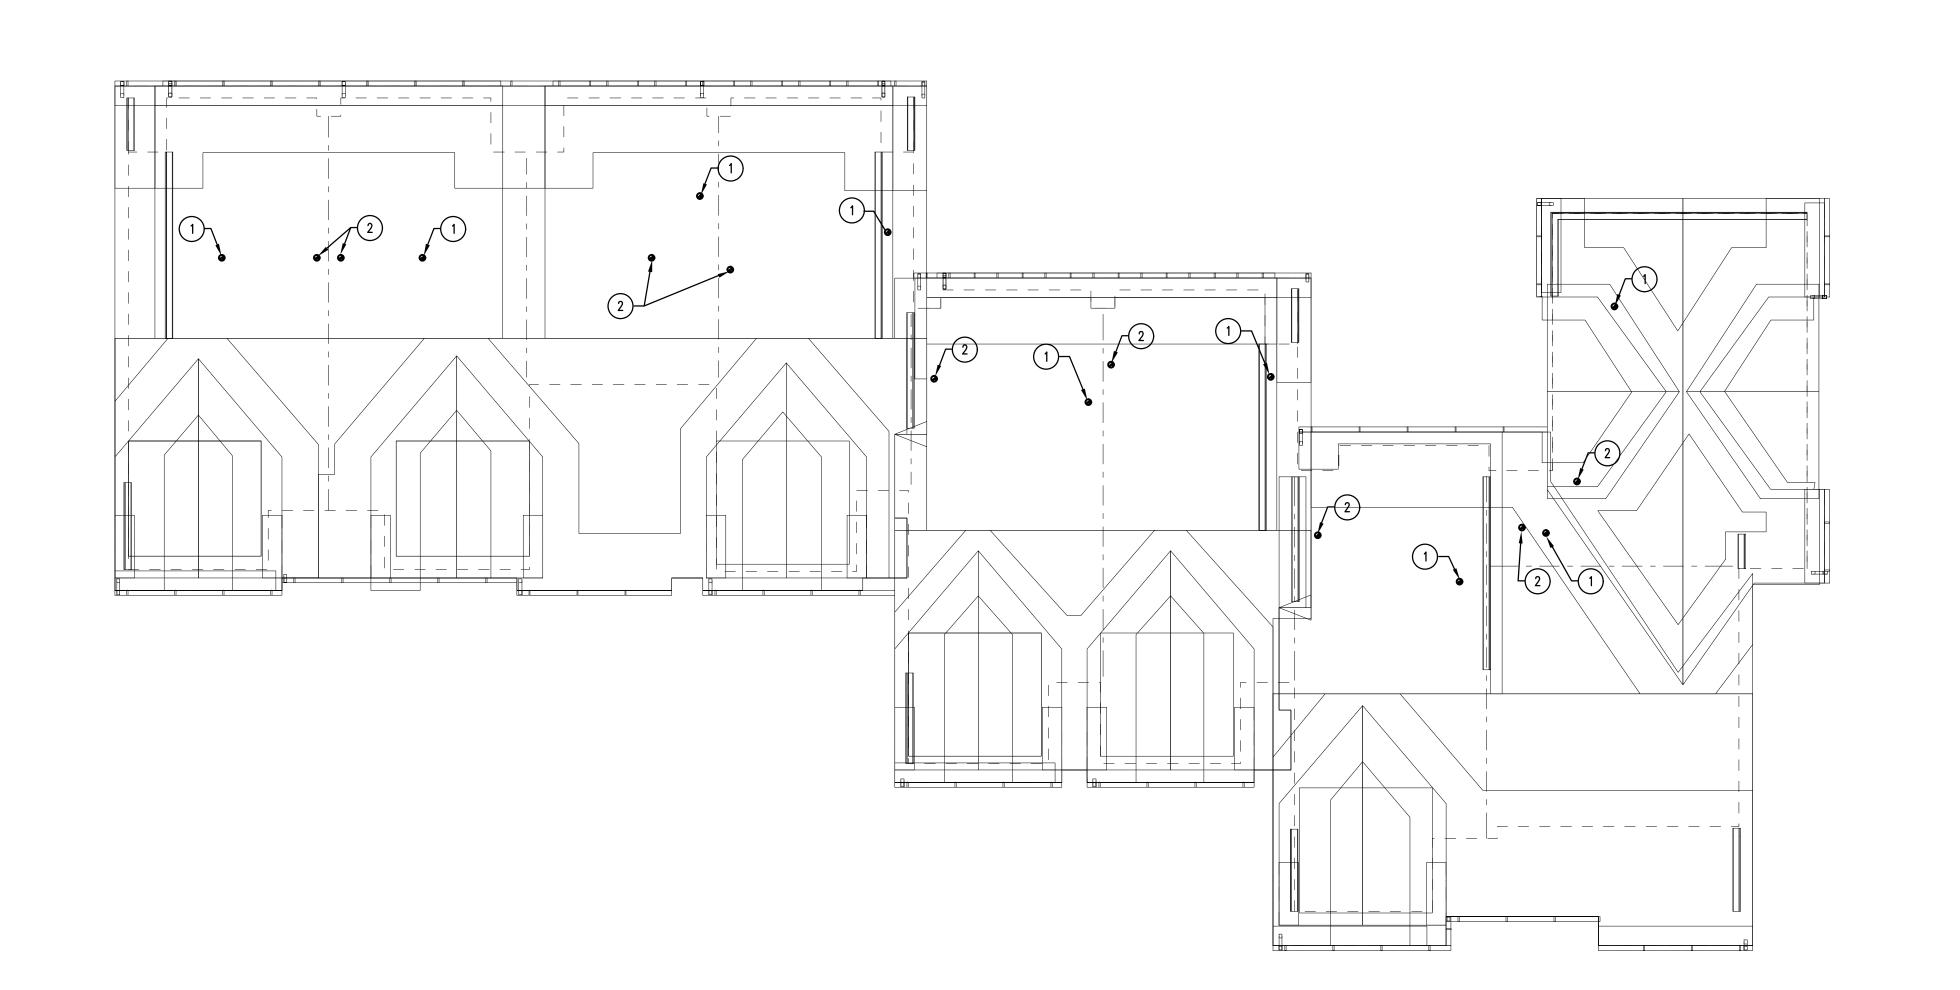
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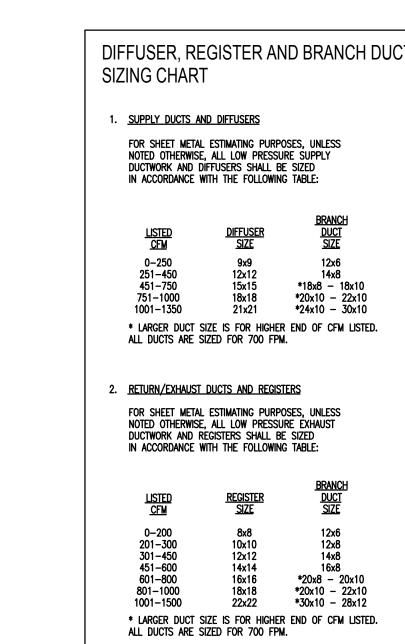
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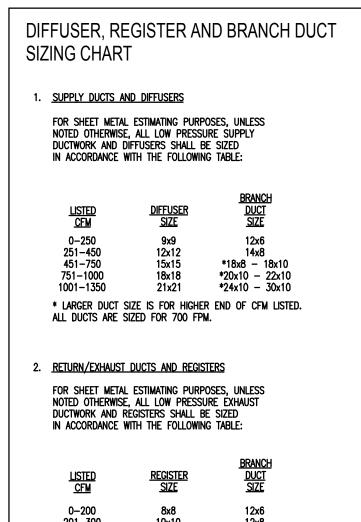
**BUILDING A** ROOF PLAN - HVAC


PROJECT NORTH












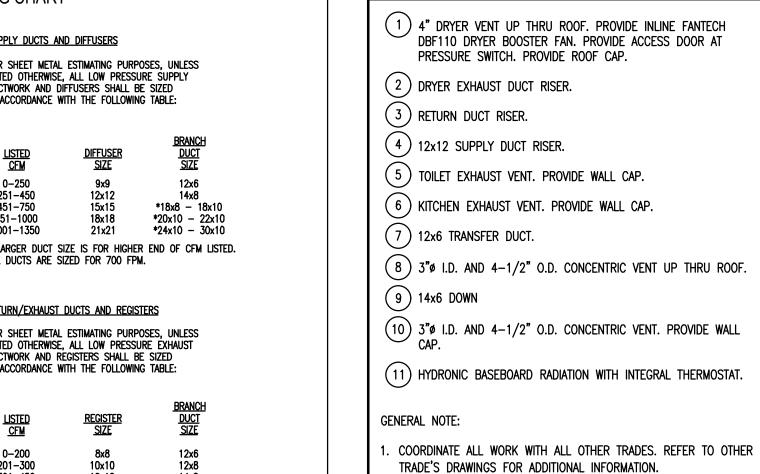

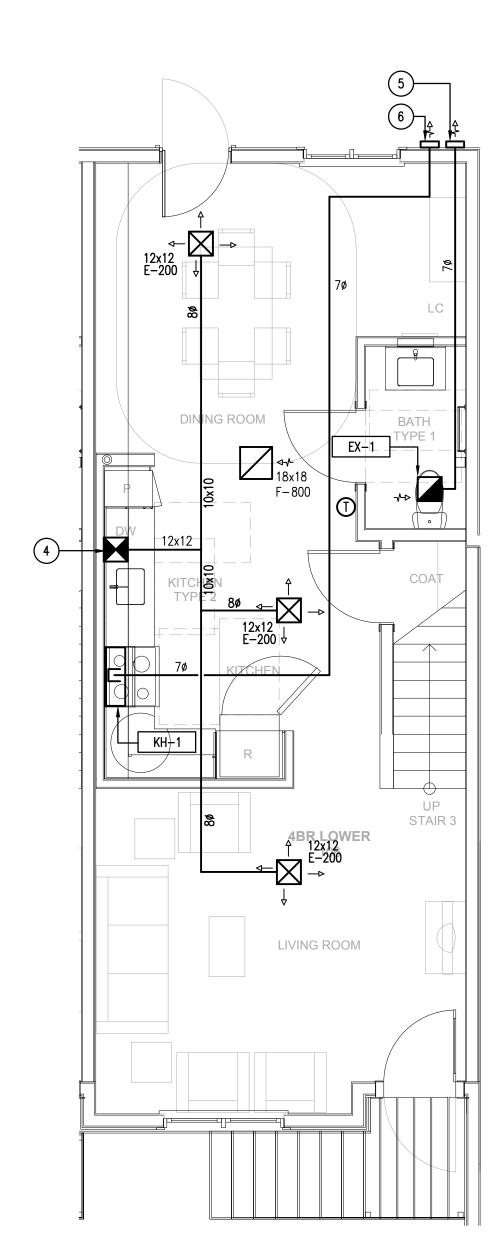


HVAC WORK NOTES

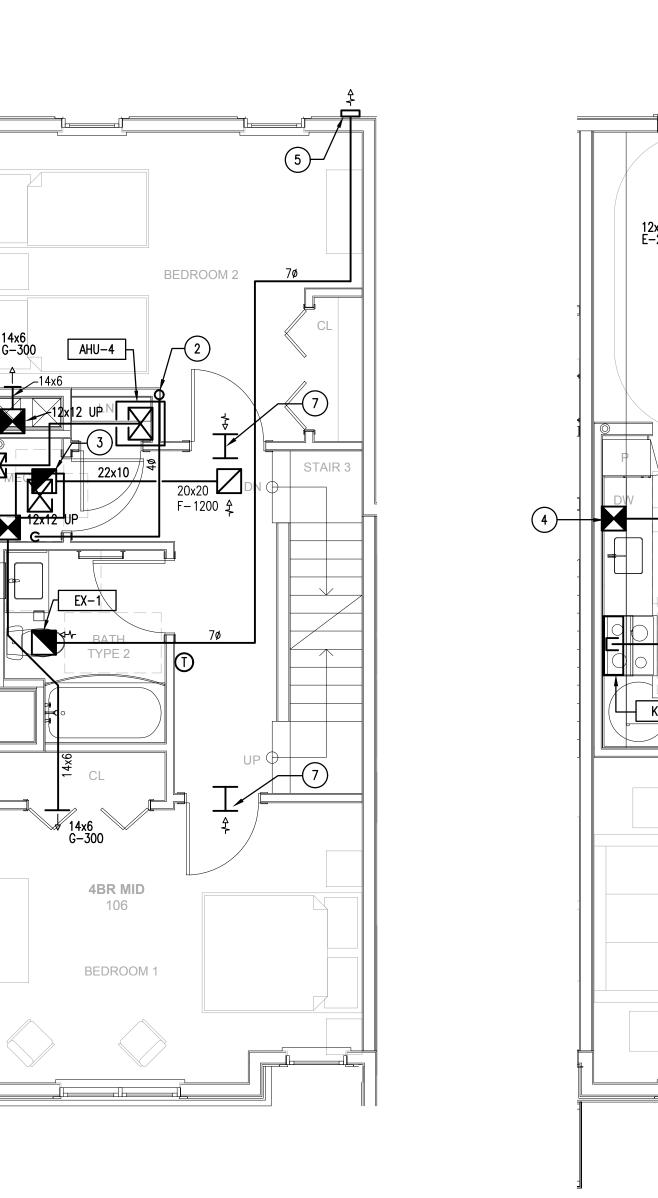

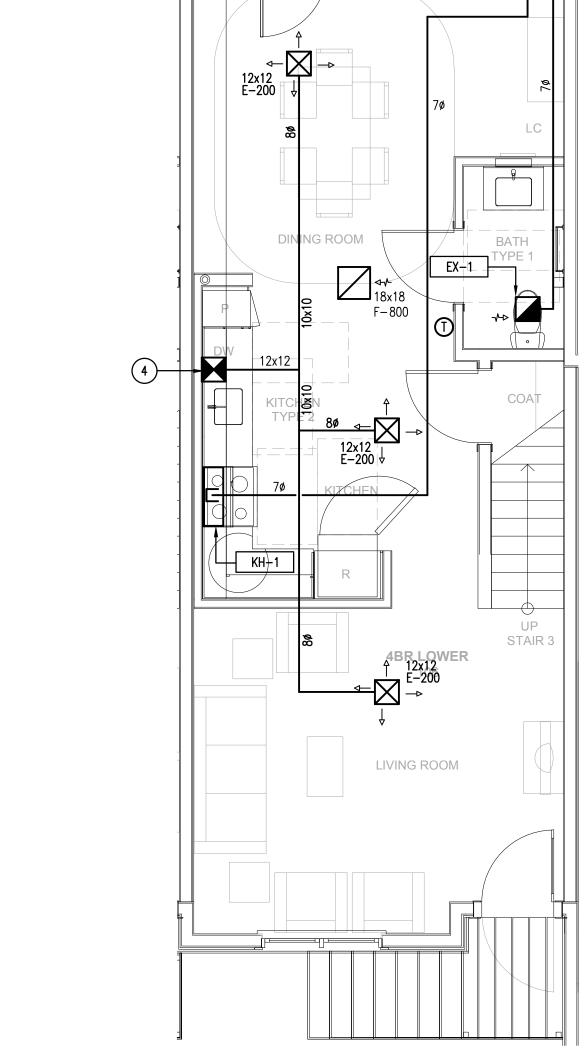



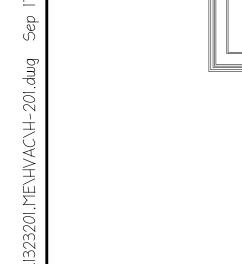

KITCHEN

KITCHEN TYPE 3 HP

10x4 G−150 ←

**2BR FLA** TYPE A 1

BEDROOM 1

3.5-A

4 2BR FLAT - HVAC

SCALE: 1/4"=1'-0"

3.5-A

9x9 E-100

BEDROOM 1

TOWNHOUSE THIRD FLOOR PLAN - HVAC (FOUR BEDROOM TOWNHOUSE)

BEDROOM 3

**4BR UPPER** 106

555 sq ft

BEDROOM 4

TOWNHOUSE SECOND FLOOR PLAN - HVAC SCALE: 1/4"=1'-0" (FOUR BEDROOM TOWNHOUSE)

PROJECT NORTH

# Washington Village Phase 1

# 13 Day Street Building A

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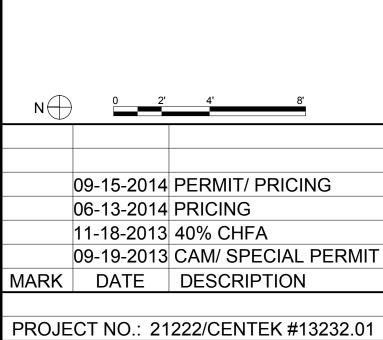
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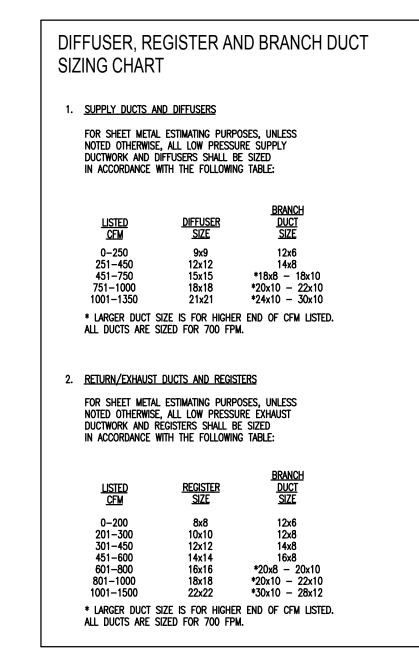





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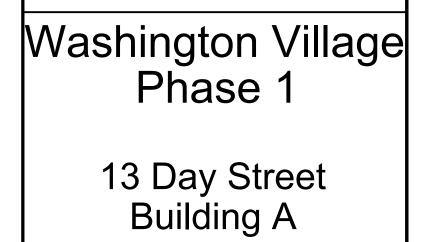
SHEET TITLE

TYPICAL UNIT PLANS **BUILDING A** HVAC



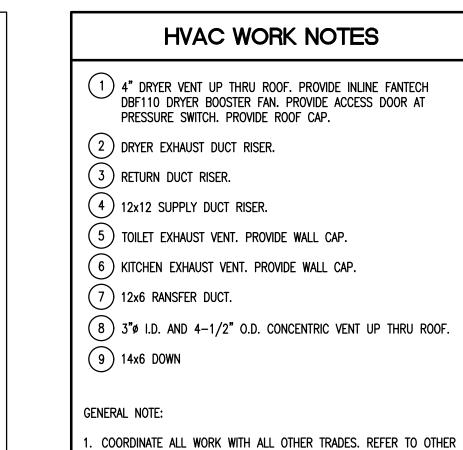

TRADE'S DRAWINGS FOR ADDITIONAL INFORMATION.



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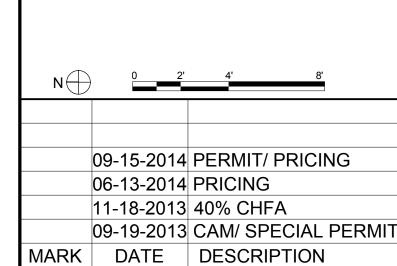
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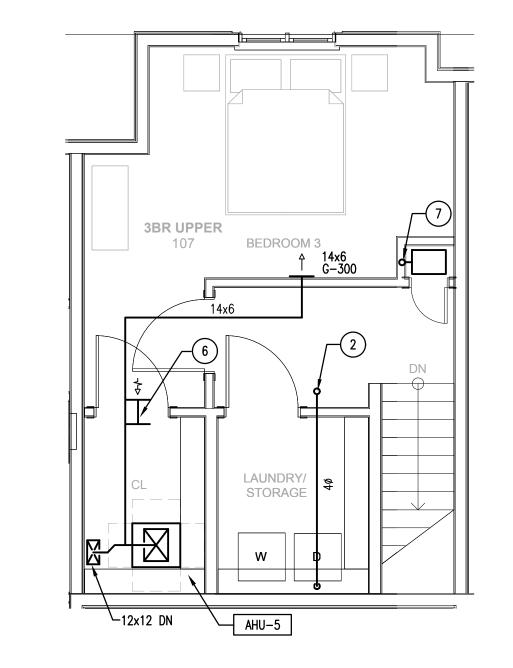


PROJECT NO.: 21222/CENTEK #13232.01 DRAWN BY: KHS CHECKED BY: FRC

SHEET TITLE

TYPICAL UNIT PLANS **BUILDING A** HVAC


PROJECT NORTH



TOWNHOUSE THIRD FLOOR PLAN - HVAC

(THREE BEDROOM TOWNHOUSE)

SCALE: 1/4"=1'-0"

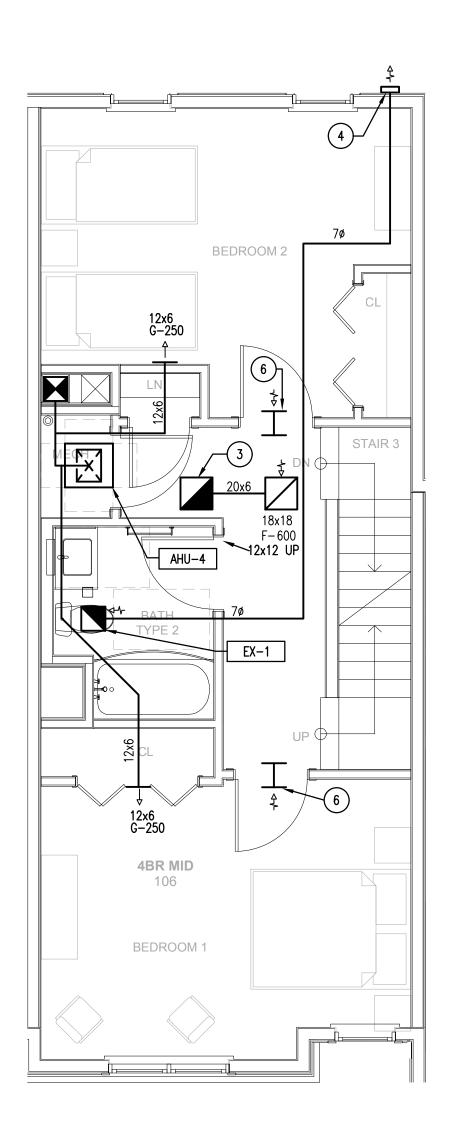





4BR LOWER

KH-1

TOWNHOUSE SECOND FLOOR PLAN - HVAC SCALE: 1/4"=1'-0" (THREE BEDROOM TOWNHOUSE)

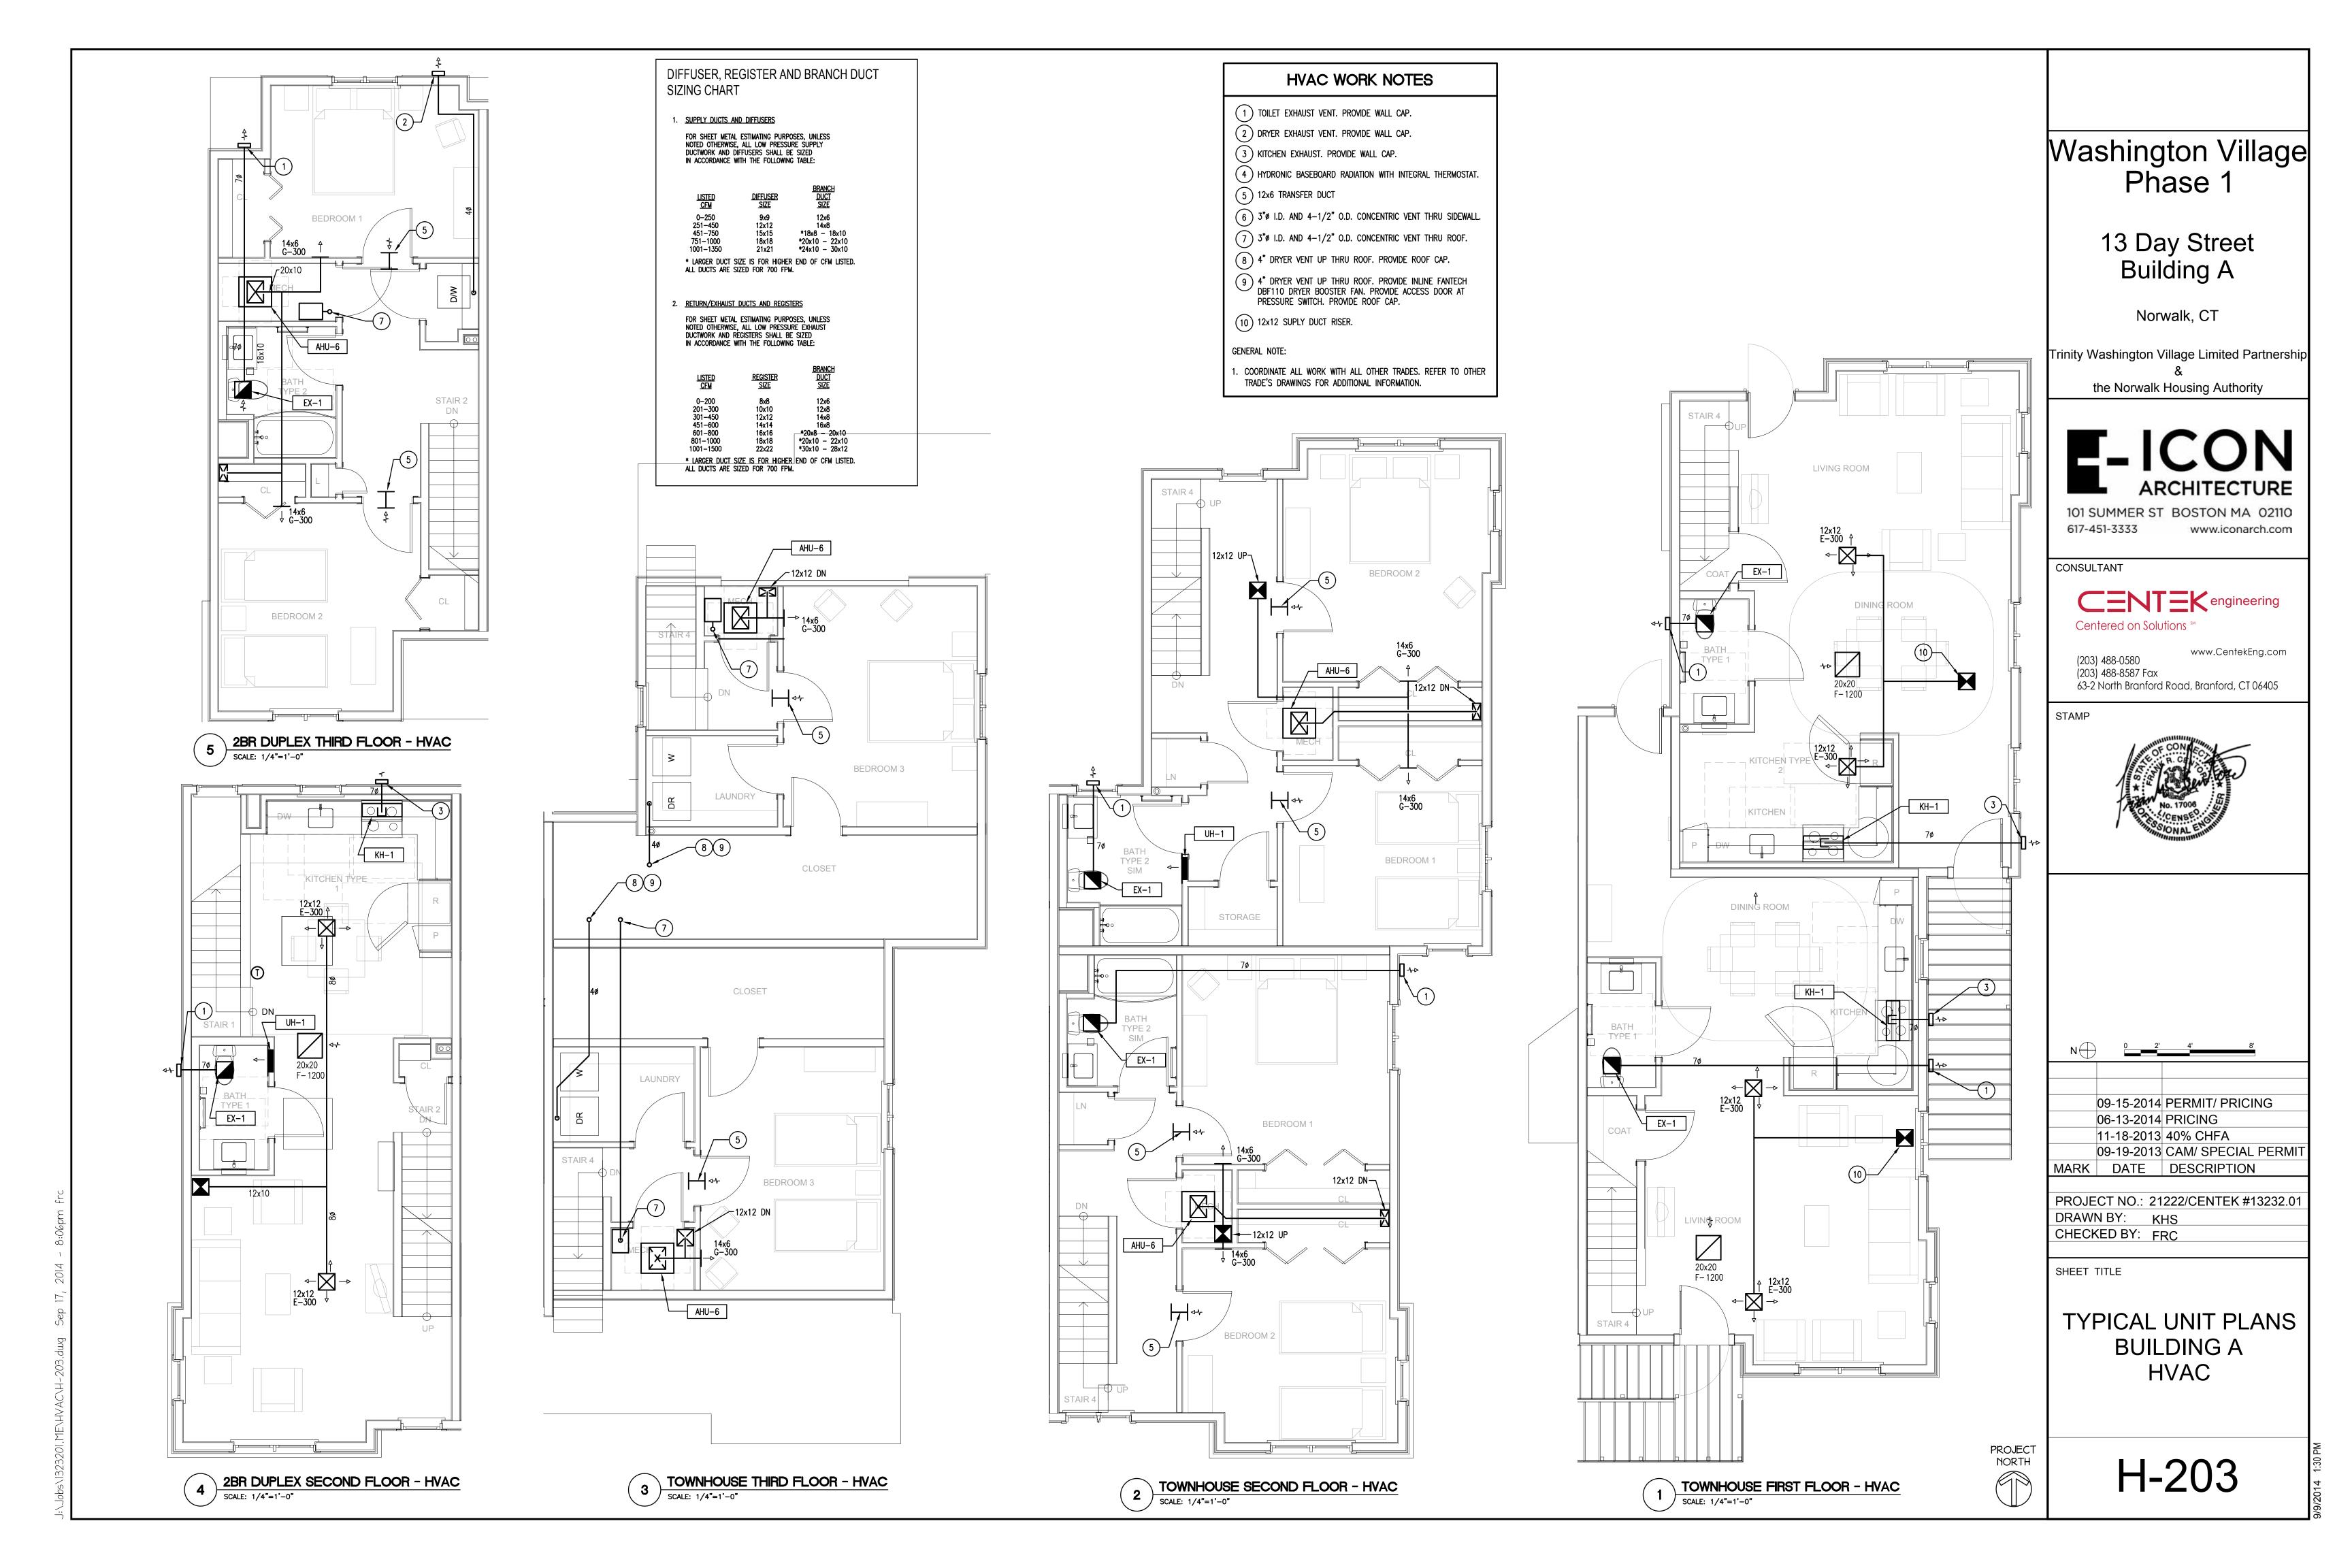


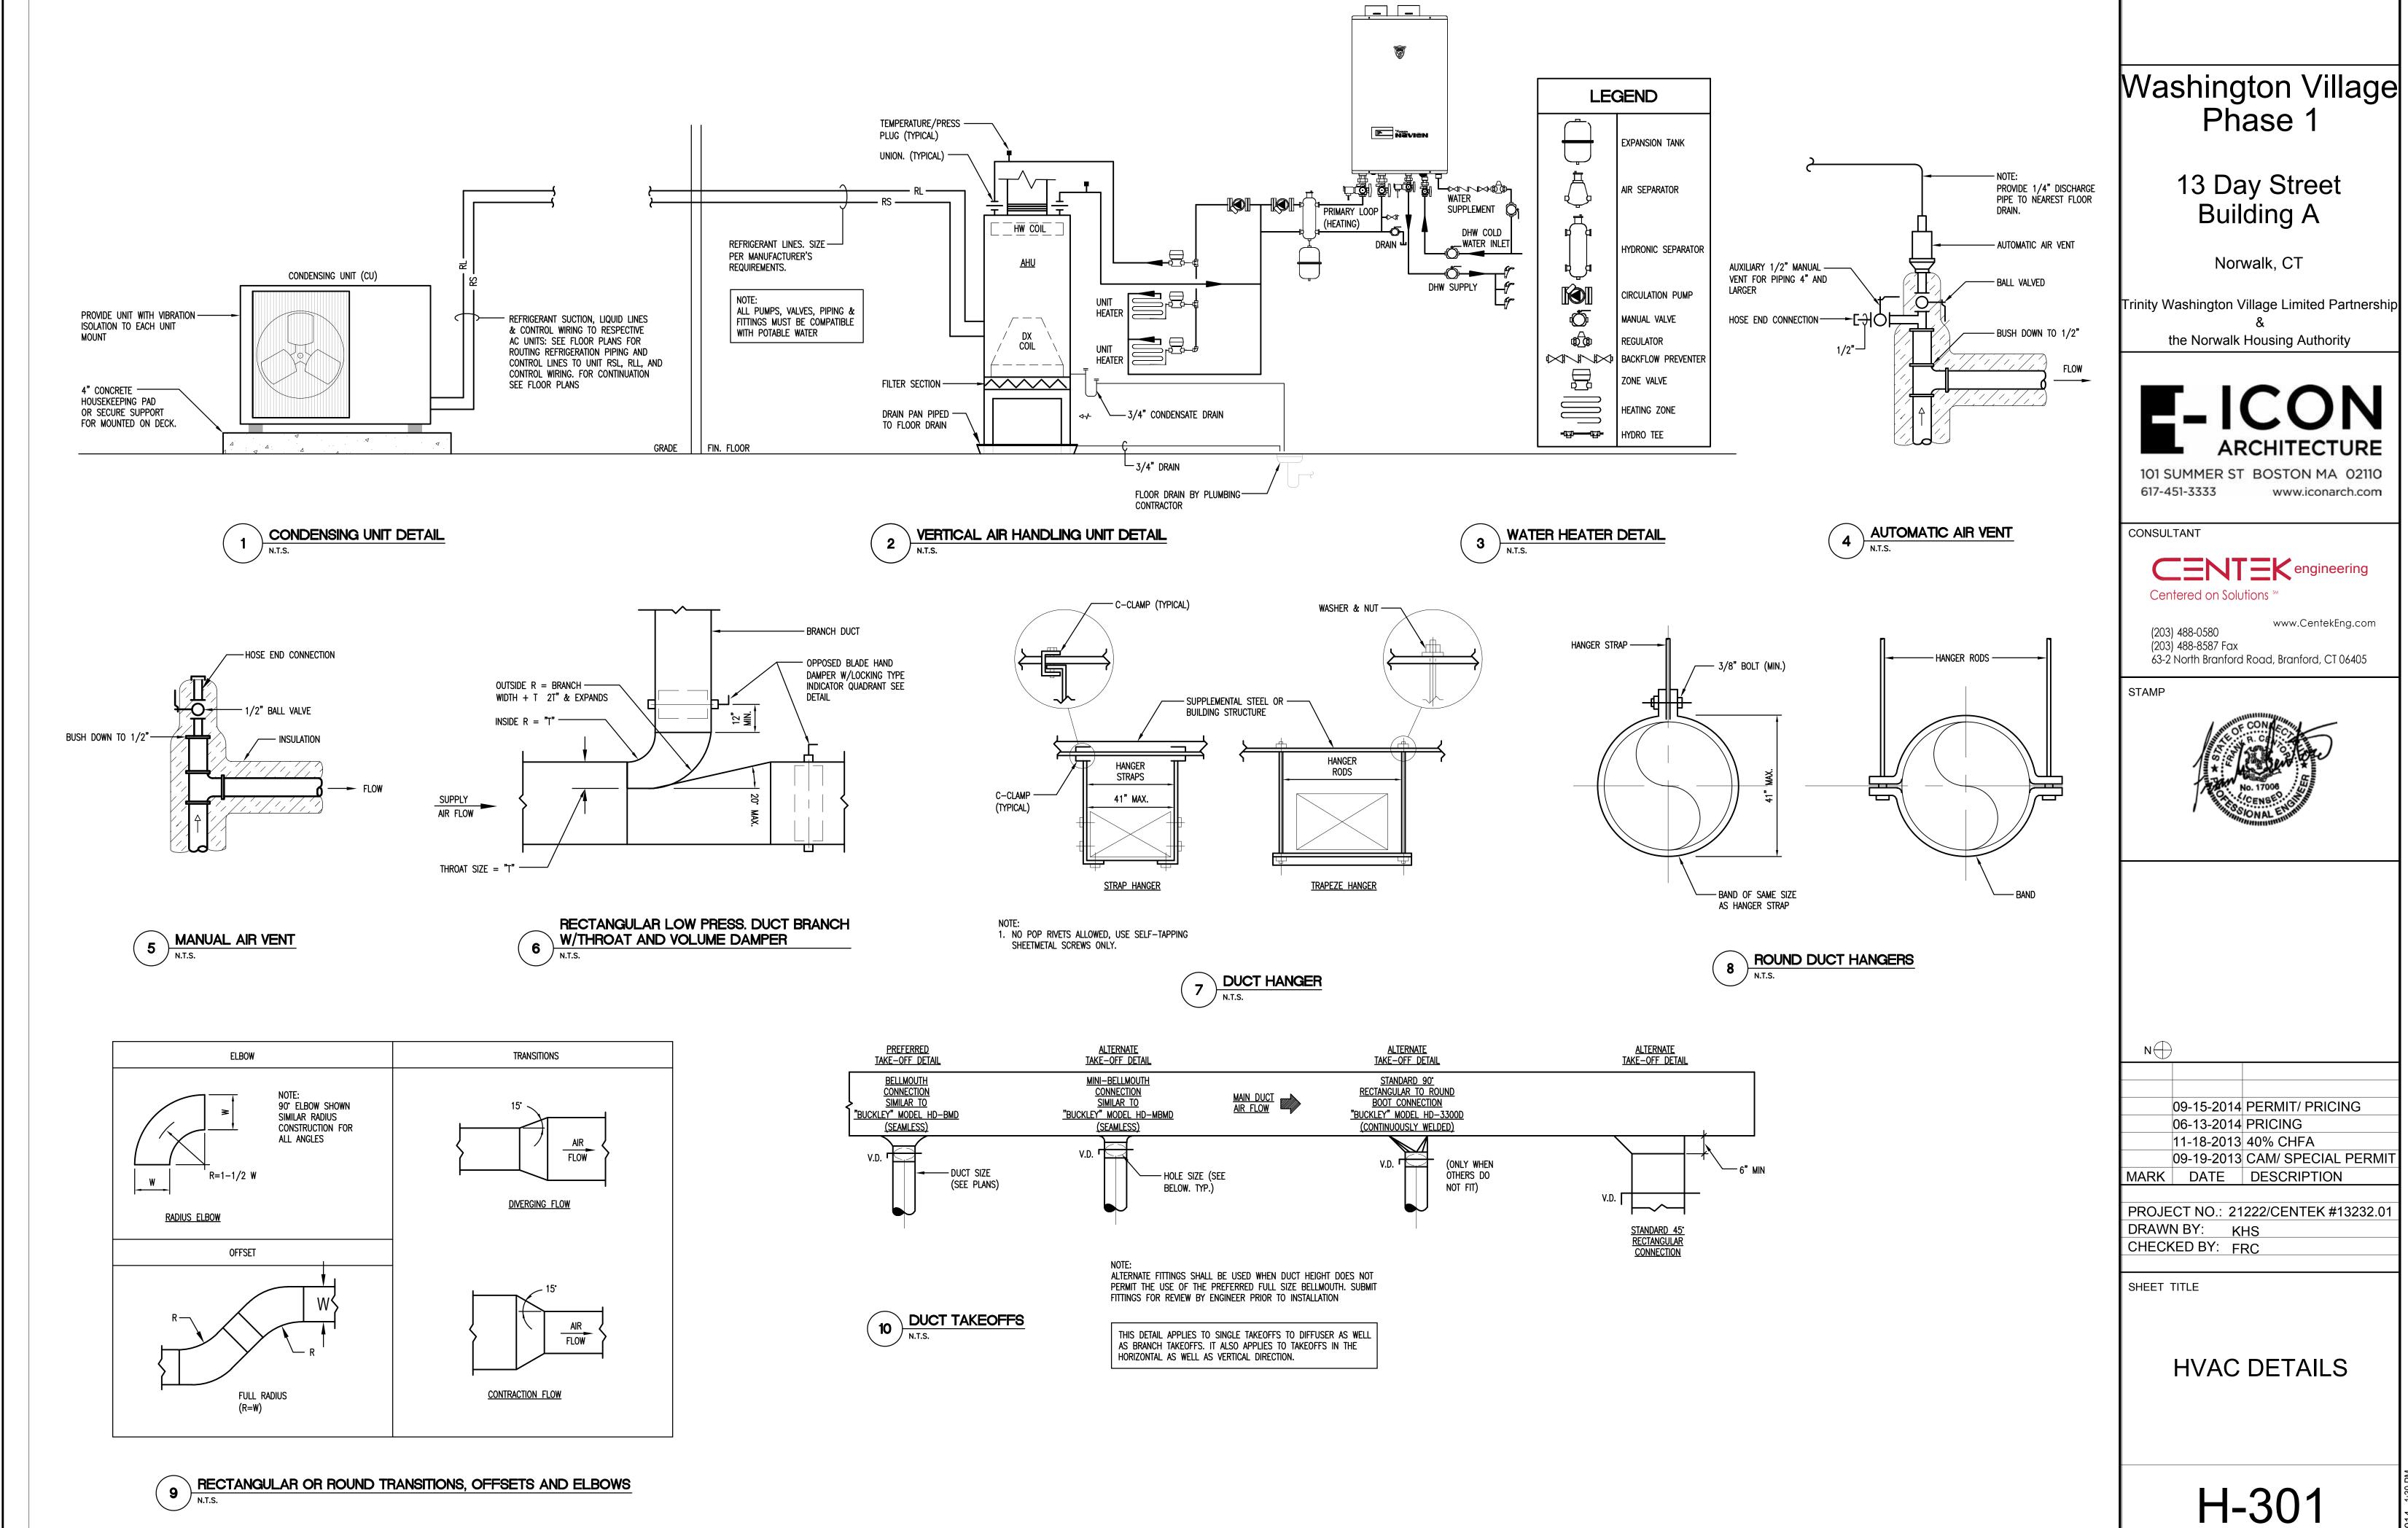


NOTE: 2X+Y SHALL EQUAL TOTAL FAN SP+2" (MINIMUM)

1 TYPICAL AIR HANDLING UNIT CASING DRAIN


N.T.S.

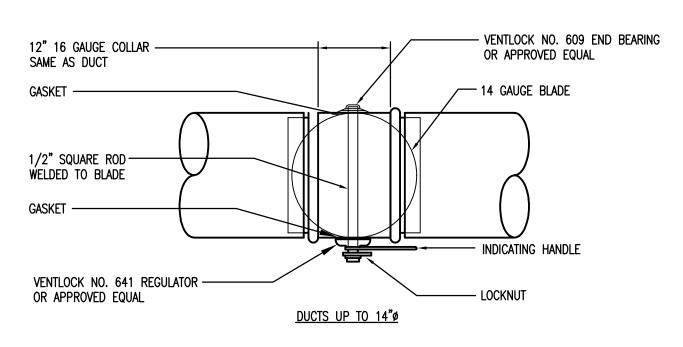

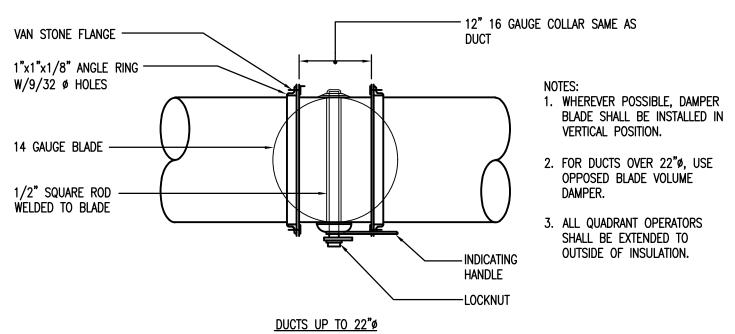


ROUND VOLUME DAMPER

N.T.S.

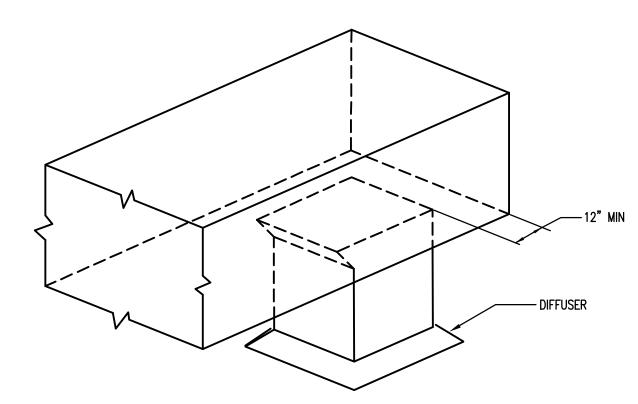


7 RECTANGULAR DIFFUSER CONNECTOR

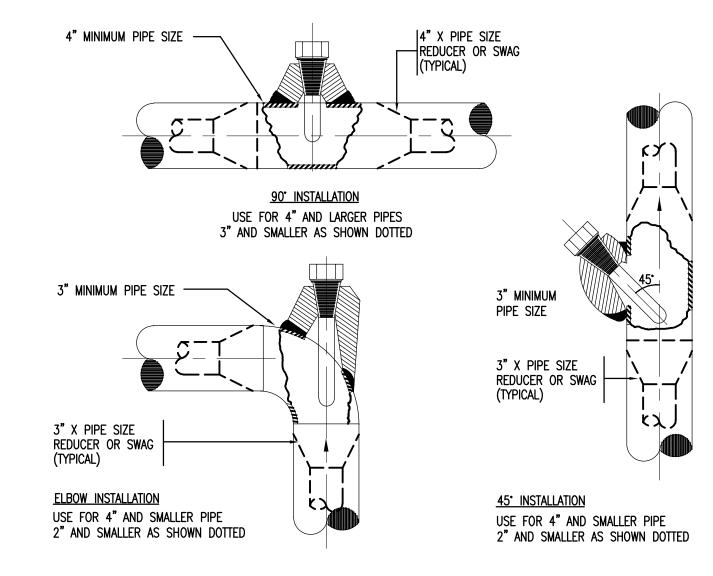


2 TYPICAL THERMOWELL INSTALLATION

N.T.S.

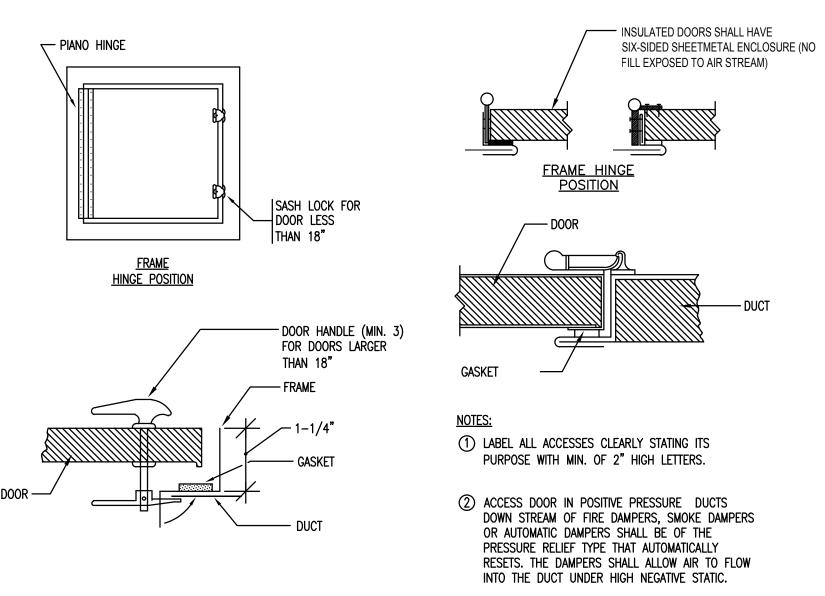


5 DUCT ACCESS DOORS

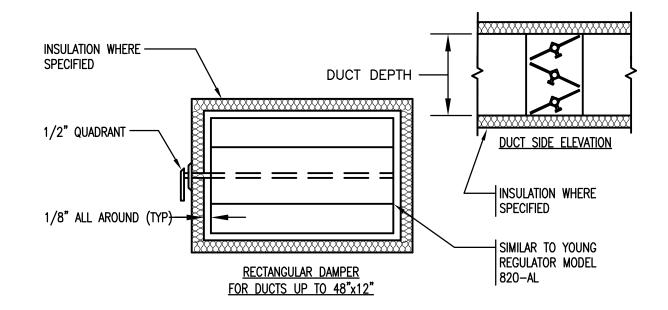

NOTES:

- 1) FOR RECTANGULAR DUCTS OVER 12" HIGH USE HIGH PRESSURE OBD.
  2) ALL BRANCH DUCTS (SUPPLY, RETURN & EXHAUST) SHALL HAVE VOLUME DAMPERS
- 2 ALL BRANCH DUCTS (SUPPLY, RETURN & EXHAUST) SHALL HAVE VOLUME DAMPERS, INCLUDING RUNOUTS TO DIFFUSERS.
- 3 ALL QUADRANT OPERATORS SHALL BE EXTENDED TO OUTSIDE OF INSULATION.
  4 FOR DUCT UNDER 12" IN HEIGHT NOT EXCEEDING 2" PRESSURE CLASS.



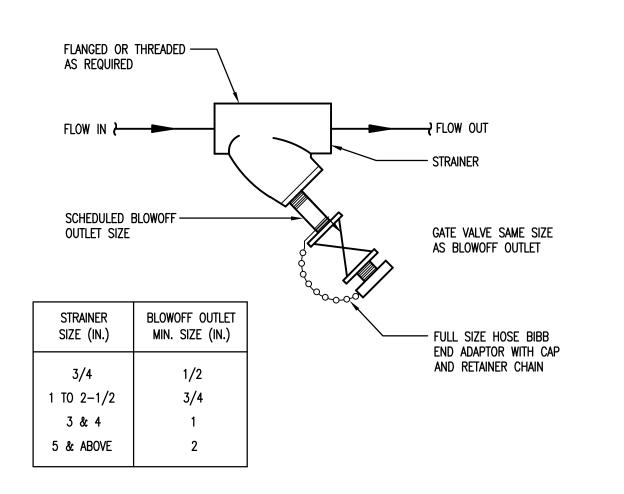

6 STAINER ASSEMBLY

N.T.S.

## Washington Village Phase 1

# 13 Day Street Building A

Norwalk, CT

Trinity Washington Village Limited Partnership &

the Norwalk Housing Authority



101 SUMMER ST BOSTON MA 02110 617-451-3333 www.iconarch.com

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STAMP



09-15-2014 PERMIT/ PRICING
06-13-2014 PRICING
11-18-2013 40% CHFA
09-19-2013 CAM/ SPECIAL PERMIT

MARK DATE DESCRIPTION

PROJECT NO.: 21222/CENTEK #13232.01 DRAWN BY: KHS

SHEET TITLE

CHECKED BY: FRC

HVAC DETAILS

#### NOTIFICATION DEVICE

NOTIFICATION DEVICE LAYOUT BASED ON THE FOLLOWING: HORNS - 90 DBA STROBES - 15 CD BATHROOMS AND ROOMS SMALLER THAN 100 SF. 75 CD ALL AREAS NOT REQUIRING 15 CD OR 110 CD.

110 CD ROOMS LARGER THAN 400 SF.

ADJUST PLACEMENT AND OUTPUT INTENSITY AS REQUIRED TO ACCOMMODATE FIELD CONDITIONS AND MEET CODE REQUIREMENTS. REFER TO PROJECT SPECIFICATIONS FOR MORE DETAILS.

Ar	AMPERE FRAME (CIRCUIT BREAKER RATING)
AFF	ABOVE FINISHED FLOOR
AFG	ABOVE FINISHED GRADE
AIC	AMPERE INTERRUPTING CAPACITY
AL	ALUMINUM
ARCH	ARCHITECT
AT	AMPERE TRIP (CIRCUIT BREAKER RATING)
ATC	AUTOMATIC TEMPERATURE CONTROL
AWG	AMERICAN WIRE GAUGE
BFC	BELOW FINISHED CEILING
BLDG	BUILDING
С	CONDUIT
CAT	CATALOG
C/B	CIRCUIT BREAKER
CIR	CIRCUIT
COL	COLUMN
CU	COPPER
DW	DISHWASHER
DWG	DRAWING
EC	EMPTY CONDUIT
F	FLUSH
FT	FEET
GD	GARBAGE DISPOSAL
G	GROUND
HPF	HIGH POWER FACTOR
JBOX/J.B.	JUNCTION BOX
KCMIL	ONE THOUSAND CIRCULAR MILS
KVA	KILOVOLT-AMPERES
KW	KILOWATTS
MCB	MAIN CIRCUIT BREAKER
MISC	MISCELLANEOUS
MLO	MAIN LUGS ONLY
NC	NORMALLY CLOSED
NEC	NATIONAL ELECTRICAL CODE
NO	NORMALLY OPEN
NTS	NOT TO SCALE
Р	POLE
PVC	POLYVINYL CHLORIDE
R	RECESSED
S	SURFACE
SP	SPARE
SW	SWITCH
TEL	TELEPHONE
٧	VOLT
Υ	WYE
W	WATT
XFMR	TRANSFORMER

1/2 SWITCHED DUPLEX RECEPACLE "LA" INDICATES LAMP

**ABBREVIATIONS** 

AMPERE FRAME (CIRCUIT BREAKER RATING)

**AMPERES** 

#### SYMBOL LIST MOUNTING HEIGHTS SHALL BE AS INDICATED UNLESS SHOWN OTHERWISE ON ELECTRICAL DRAWINGS OR ARCHITECTURAL ELEVATIONS CALL SYSTEM FIRE ALARM SYSTEM RACEWAYS AND WIRING L43/1,3 HOMERUN TO PANELBOARD. "L43" INDICATES PANEL, "1,3" INDICATES CIRCUIT NUMBERS, FIRE ALARM PULL STATION DOME LIGHT CEILING MOUNTED (20A, 1P, UNLESS INDICATED OTHERWISE) HEAT DETECTOR BATHROOM PULL CORD 1. GREEN GROUND CONDUCTOR NOT INDICATED BUT SHALL BE INCLUDED IN EACH PHOTOELECTRIC SMOKE DETECTOR TRANSFORMER RACEWAY. SIZE SHALL BE #12AWG UNLESS INDICATED OTHERWISE. PHOTOELECTRIC SMOKE DETECTOR WITH ADJACENT CARBON MONOXIDE 2. HOMERUNS TO PANELBOARDS SHALL HAVE A MAXIMUM OF THREE (3) PHASE POWER DISTRIBUTION EQUIPMENT DETECTOR. (PROVIDE TWO SEPARATE DETECTORS. COMBINATION DETECTOR IS CONDUCTORS (ONE PER PHASE) PLUS NEUTRAL AND GROUND CONDUCTORS IN NOT PERMITTED.) EACH CONDUIT. PANELBOARD, SURFACE MOUNTED LIGHTING FIXTURES PHOTOELECTRIC SMOKE DETECTOR FOR ELEVATOR RECALL. PANELBOARD, FLUSH MOUNTED FLUORESCENT LIGHTING FIXTURE CEILING OR RECESSED MOUNTED. "F1" INDICATES JUNCTION BOX, SIZED PER NEC AND EQUIPMENT VENDOR (REFER TO AUDIO/VISUAL FIRE ALARM, "V" INDICATES VISUAL ONLY, • FIXTURE TYPE, "2" INDICATES CIRCUIT NUMBER, "a" INDICATORS SWITCH CONTROL, ARCHITECTURAL AND EQUIPMENT VENDORS' DRAWINGS FOR SIZE AND LOCATION) "WP" INDICATES WEATHERPROOF. "•" INDICATES WIRED TO LIFE SAFETY, HALF SHADED INDICATES BATTERY **MISCELLANEOUS** FIRE ALARM CONTROL PANEL UNDERCOUNTER TASK LIGHT FIRE ALARM REMOTE ANNUNCIATOR JUNCTION BOX SIZED PER NEC. "AD" INDICATES AUTO DOOR RECESSED OR SURFACE MOUNTED LIGHTING FIXTURE, SOLID FILL INDICATES WIRED TO LIFE FIRE ALARM MONITOR MODULE JUNCTION BOX SIZED PER NEC. "GD" INDICATES GARBAGE DISPOSAL FIRE ALARM CONTROL MODULE FLUORESCENT BARE LAMP STRIP OR INDUSTRIAL STRIP "•" INDICATES WIRED TO LIFE SAFETY. JUNCTION BOX SIZED PER NEC. "DW" INDICATES DISH WASHER. PROVIDE ADJACENT DISCONNECT TOGGLE SWITCH IN ACCESSIBLE LOCATION. TAMPER SWITCH WALL WASH OR DIRECTIONAL LIGHTING FIXTURE. JUNCTION BOX SIZED PER NEC. "ATC" INDICATES CONNECTION FOR FLOW SWITCH AUTOMATIC TEMPERATURE CONTROL CEILING MOUNTED ILLUMINATED EXIT SIGN, ARROWS AS INDICATED ON SPRINKLER BELL DRAWINGS. JUNCTION BOX SIZED PER NEC. "AU" INDICATES CONNECTION FOR BATHROOM EXHAUST FAN, CONTROLLED BY AUBIE SWITCH. TELECOMMUNICATIONS (MOUNTED 18" AFF) SITE LIGHTING FIXTURE. NON FUSED DISCONNECT SWITCH TOGGLE SWITCHES (MOUNTED 48" AFF) TELEPHONE OUTLET. "W' INDICATES MOUNTED 48"AFF FUSED DISCONNECT SWITCH COMBINATION TELEPHONE/DATA OUTLET - "CT" INDICATES SINGLE POLE TOGGLE SWITCH. "a" INDICATES FIXTURE CONTROL COAXIAL CABLE TV OUTLET MOUNTED 8" ABOVE COUNTER TOP. THREE WAY TOGGLE SWITCH BRANCH CIRCUIT WIRING NOTES TELCO TERMINAL BOX SINGLE POLE SWITCH FOR DUPLEX RECEPTACLE "LA" INDICATES LAMP 1. WIRING IS SHOWN ON DRAWINGS ONLY FOR SPECIFIC ROUTES OR SPECIAL CONDITIONS. CABLE TV EQUIPMENT BOX SINGLE POLE TOGGLE SWITCH WITH PILOT LIGHT 2. WIRING AND CONDUIT SHALL BE REQUIRED BETWEEN ALL OUTLETS INDICATED WITH NET MEDIA CENTER (I.C.C. MINI DISTRIBUTION CENTER) WITH ADJACENT DOUBLE SINGLE POLE TOGGLE SWITCH FOR GARBAGE DISPOSAL CIRCUIT NUMBERS AND PANEL DESIGNATIONS. DUPLEX RECEPTACLE. LOCATE NEAR CEILING. "2" INDICATES CIRCUIT NUMBER. AUBIE SWITCH FOR FAN CONTROL 3. ALL SWITCH CONTROLS SHALL BE PROVIDED WITH WIRING AND CONDUIT AS REQUIRED. MASTER INTERCOM DEVICE (PROVIDE WITH VISUAL NOTIFICATION IN HAIRING IMPAIRED UNITS.) 4. ALTHOUGH ALL BRANCH CIRCUIT WIRING AND CONDUIT IS NOT SHOWN, IT IS THE DIMMER SWITCH, "3" INDICATES 3-WAY. INTENT OF THESE DOCUMENTS THAT A COMPLETE BRANCH CIRCUIT WIRING SYSTEM BE TENANT INTERCOM DEVICE INSTALLED. OCCUPANCY SENSOR SWITCH. SENSORSWITCH MODEL #: WSD-PDT INTERCOM CONTROL PANEL 5. A GREEN GROUNDING CONDUCTOR SHALL BE RUN WITH ALL CIRCUITS. VERIFY CONDUIT CEILING MOUNTED OCCUPANCY SENSOR. SENSORSWITCH MODEL #: CM-PDT-9 SIZE TO ENSURE IT CAN ACCOMMODATE ALL PHASE, NEUTRAL AND GROUND DOOR BELL CHIME. "V" INDICATES DEVICE HAS AUDIO AND VISUAL NOTIFICATION. <u>RECEPTACLES</u> (MOUNTED 18" AFF) 6. MINIMUM CONDUCTOR SIZE SHALL BE 12 AWG. COPPER. DOOR BELL PUSH BUTTON DUPLEX RECEPTACLE, "R21" INDICATES PANEL, "2" INDICATES CIRCUIT NUMBER, DOORBELL TRANSFORMER "E" INDICATES WIRED TO EMERGENCY PANEL SECURITY SYSTEM KEYPAD DUPLEX RECEPTACLE MOUNTED 8" ABOVE COUNTER TOP SECURITY SYSTEM CONTROL PANEL DUPLEX RECEPTACLE WITH INTEGRAL GROUND FAULT INTERRUPTER. "WP" INDICATES WEATHERPROOF. SECURITY SYSTEM MOTION DETECTOR DUPLEX RECEPTACLE WITH INTEGRAL GROUND FAULT INTERRUPTER MOUNTED 8" ABOVE WINDOW CONTACT/ BREAK DOUBLE DUPLEX RECEPTACLE WITH INTEGRAL GROUND FAULT INTERRUPTER "CT" INDICATES COUNTER TOP MOUNTED DOOR CONTACT BREAK DOUBLE DUPLEX RECEPTACLE SECURITY SYSTEM SIREN SIMPLEX RECEPTACLE FOR REFRIGERATOR PUSH PLATE OUTLET TO SUIT EQUIPMENT RELAY MODULE 30A, 240V, DRYER RECEPTACLE. PROVIDE (3) #10 AWG, (1) #10 AWG GROUND. TIME CLOCK FOR SITE LIGHTING 50A, 240V, STOVE RECEPTACLE. PROVIDE (3) #6 AWG, (1) #6 AWG GROUND.

PHOTOCELL FOR SITE LIGHTING CONTROL

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CHECKED BY: CKD

DRAWN BY: TJB

SHEET TITLE

AND NOTES

#### **GENERAL NOTES**

- 1. THE ELECTRICAL CONTRACTOR SHALL BE RESPONSIBLE FOR ALL WORK REQUIRED FOR A COMPLETE, FULLY OPERABLE INSTALLATION. ALL WORK TO BE DONE IN ACCORDANCE WITH THE LATEST APPROVED ISSUE OF THE NEC AND APPLICABLE LOCAL CODES.
- 2. THE DRAWINGS SHOW THE GENERAL LAYOUT AND SOME OF THE DETAIL, BUT THEY DO NOT SHOW EVERY FITTING, BEND, ... ETC. ELECTRICAL CONTRACTOR SHALL PROVIDE ALL SUCH MATERIALS TO MAKE A COMPLETE INSTALLATION.
- 3. DO NOT SCALE DRAWINGS; ACTUAL FIELD MEASUREMENTS AND DIMENSIONS TAKE PRECEDENCE IN ALL CASES.
- 4. ALL WORK SHALL BE DONE IN ACCORDANCE WITH THE STANDARD GENERAL CONDITIONS OF THE CONSTRUCTION CONTRACT, AIA DOCUMENT 201, LATEST EDITION.
- 5. ELECTRICAL CONTRACTOR SHALL INSTALL ALL EQUIPMENT IN ACCORDANCE WITH MANUFACTURERS INSTRUCTIONS AND OR REQUIREMENTS FOR PROPER OPERATION AND MAINTENANCE.
- 6. ELECTRICAL CONTRACTOR SHALL BE RESPONSIBLE FOR TESTING OF ALL PHASES OF THE WORK AND TO DEMONSTRATE TO OWNER THAT THE EQUIPMENT IS IN FULL OPERATING ORDER.
- THE SCOPE OF WORK IS AS SHOWN ON THE PLANS AND DETAILED IN THE SPECIFICATIONS. ANY DEVIATIONS OR EXCLUSIONS FROM THIS MUST BE SUBMITTED TO ENGINEER FOR APPROVAL PRIOR TO BEING IMPLEMENTED.
- 8. ALL THE WIRE SIZES AND ARE BASED ON COPPER, ALUMINUM IS NOT TO BE USED.
- 9. ALL WIRING METHODS ARE TO BE IN ACCORDANCE WITH THE CURRENT ISSUE OF THE NATIONAL ELECTRICAL CODE, AND APPLICABLE LOCAL CODES. ADDITIONALLY, ALL WORK ON OR NEAR ENERGIZED CONDUCTORS OR EQUIPMENT SHALL BE IN ACCORDANCE WITH NFPA 70E, CHAPTER 1: SAFETY-RELATED WORK PRACTICES.
- 10. ALL WIRING IS TO BE CONCEALED.
- 11. PROVIDE INDEPENDENT SEISMIC SUPPORT OF ALL ELECTRICAL EQUIPMENT PER THE CURRENT ISSUE OF CT BUILDING CODE.
- 12. ELECTRICAL CONTRACTOR SHALL SECURE ALL PERMITS AND PAY FOR ALL REQUIRED FEES, INCLUDING ALL UTILITY
- 13. ELECTRICAL CONTRACTOR SHALL WARRANT AND GUARANTEE ALL MATERIALS AND WORKMANSHIP FOR A PERIOD OF ONE YEAR FROM THE DATE OF FINAL ACCEPTANCE BY THE OWNER.
- 14. ELECTRICAL CONTRACTOR SHALL PROVIDE PROOF OF LIABILITY AND PROPERTY INSURANCE TO THE OWNER, ALL DEDUCTIBLES SHALL BE PAID FOR BY THE ELECTRICAL CONTRACTOR IN THE EVENT OF A CLAIM.
- 15. PERSONNEL SAFETY IS OF PRIME IMPORTANCE. NO HAZARDOUS CONDITION MUST BE ALLOWED. EVERY CARE MUST BE TAKEN TO PROTECT CONSTRUCTION AND OTHER PERSONNEL. CLEANUP IS TO BE DONE ON A DAILY BASIS. ELECTRICAL CONTRACTOR TO REMOVE AND DISPOSE OF REFUSE FROM SITE.
- 16. ELECTRICAL CONTRACTOR SHALL PROVIDE SHOP DRAWINGS FOR APPROVAL FOR ALL LIGHTING FIXTURES, PANELS, SWITCHES, RECEPTACLES, ... ETC.
- 17. ELECTRICAL CONTRACTOR TO VERIFY LIGHTING FIXTURE MOUNTING REQUIREMENTS FOR VARIOUS CEILING TYPES AND ORDER APPROPRIATE HARDWARE.
- 18. COORDINATE EXACT PLACEMENT OF EQUIPMENT WITH ARCHITECTURAL, AND MECHANICAL PLANS, MAKE FIELD ADJUSTMENTS AS REQUIRED TO AVOID CONFLICTS, VERIFY WITH OWNER.
- 19. ELECTRICAL CONTRACTOR TO COORDINATE WITH ARCHITECTURAL AND MECHANICAL CONTRACTOR FOR ITEMS SUPPLIED BY THE MECHANICAL/OTHER DIVISIONS BUT INSTALLED BY THE ELECTRICAL CONTRACTOR. ELECTRICAL CONTRACTOR TO REVIEW ALL THE PLANS FOR THE PROJECT FOR ELECTRICAL WORK.
- 20. ELECTRICAL CONTRACTOR TO VERIFY LOADS, SETTINGS, OVERCURRENT PROTECTION... ETC TO INSURE COMPATIBILITY OF EQUIPMENT.
- 21. ELECTRICAL CONTRACTOR TO VERIFY ALL EQUIPMENT POWER NEEDS WITH THE ACTUAL SHOP DRAWINGS FOR THE EQUIPMENT TO BE USED, PRIOR TO STARTING ANY ELECTRICAL WORK.
- 22. ALL BALLASTS TO BE HPF AND HAVE THE LOWEST POSSIBLE ENERGY CONSUMPTION FOR THE GIVEN LAMP.
- 23. ALL ELECTRICAL PENETRATIONS TO BE FIREPROOFED TO MAINTAIN INTEGRITY OF FIRE WALLS/FLOORS/CEILINGS.
- 24. PROVIDE LAMICOID NAMEPLATES FOR ALL ELECTRICAL DISTRIBUTION AND DISCONNECT EQUIPMENT. ALTERNATE METHODS SHALL NOT BE ALLOWED. NAMEPLATES SHALL BE FASTENED TO PANEL WITH SCREWS.
- 25. THE DISPOSAL OF ALL UNUSED EXISTING ELECTRICAL EQUIPMENT REMOVED IS A PART OF THE SCOPE OF WORK. THE ELECTRICAL CONTRACTOR SHALL DISPOSE OF ALL SUCH EQUIPMENT, INCLUDING HAZARDOUS PCB CONTAINING BALLASTS, IN A MANNER CONSISTENT WITH STATE OF CT. DEPARTMENT OF ENVIRONMENTAL PROTECTION REGULATIONS, CURRENT ISSUE.
- 26. SHARED NEUTRALS ARE NOT TO BE USED. PROVIDE SEPARATE NEUTRALS FOR ALL CIRCUITS.
- 27. PRIOR TO ACQUISITION OR INSTALLATION GIVE WRITTEN NOTICE TO ARCHITECT AND ENGINEER OF ANY MATERIAL OR APPARATUS THAT IS INADEQUATE, UNSUITABLE FOR THE USE, IN VIOLATION OF LAWS, ORDINANCES, RULES, CODES OR ANY REGULATIONS OF AUTHORITIES HAVING JURISDICTION OR ANY NECESSARY ITEMS OF WORK THAT HAS BEEN OMITTED. CONTRACTOR AFFIRMS THAT ABSENT SUCH NOTICE, ALL SYSTEMS WILL FUNCTION SATISFACTORILY WITHOUT ADDITIONAL EXTRA COMPENSATION.
- 28. ALL PART NUMBERS ARE PROVIDED FOR THE CONVENIENCE OF THE CONTRACTOR. THEY ARE NOT TO BE CONSIDERED THE COMPLETE SPECIFICATION OF THE PRODUCT. THE PART NUMBER AND DESCRIPTION WILL BE THE COMPLETE SPECIFICATION. IN THE EVENT OF A DISCREPANCY BETWEEN THE TWO, THE MORE STRINGENT, MORE COSTLY FEATURE/PERFORMANCE WILL BE REQUIRED.
- 29. AT THE CONCLUSION OF THE PROJECT WHILE THE PROJECT IS OCCUPIED AND OPERATING NORMALLY, THE CONTRACTOR IS TO TAKE AND RECORD OPERATING CURRENTS IN THE DISTRIBUTION SYSTEM AND REPORT THESE READINGS TO THE ENGINEER FOR EVALUATION. ENGINEER SHOULD BE ADVISED WHEN THE READINGS ARE TO BE MADE SO THAT HE MAY ATTEND AND WITNESS SAME.
- 30. RISER DIAGRAMS ARE PROVIDED TO SHOW DIAGRAMMATIC GENERAL WIRING REQUIREMENTS. WIRING IS TO BE PROVIDED FOR THE PARTICULAR VENDOR/SYSTEM APPROVED FOR THE PROJECT. ALL WIRING IS TO BE CONCEALED.
- 31. ALL WIRING IN AIR PLENUM CEILINGS SHALL BE TEFLON COATED AND RATED FOR USE WITHIN THE PLENUM.
- 32. NO LOW VOLTAGE WIRING SHALL BE PERMITTED IN THE SAME RACEWAY AS POWER WIRING.
- 33. PROVIDE DRAG LINES IN ALL EMPTY RACEWAYS.
- 34. CIRCUIT NUMBERS ARE INDICATED FOR INTENT ONLY. THE ELECTRICAL CONTRACTOR SHALL ADJUST ACCORDINGLY IN THE FIELD, TO BALANCE CIRCUITS EVENLY ON ALL PHASES.
- 35. REFER TO ARCHITECTURAL DRAWINGS FOR THE EXACT LOCATION AND MOUNTING HEIGHTS OF ALL DEVICES, OUTLETS, AND LIGHT FIXTURES INCLUDING ALL DEVICES IN ACCESSIBLE UNITS.
- 36. FOR ALL TEL/DATA OUTLET LOCATIONS PROVIDE 2—GANG BOX WITH SINGLE GANG MUD RING. INSTALL TWO CAT—6 UTP 4—PAIR CABLES FROM OUTLET TO MINI DISTRIBUTION CENTER. PROVIDE CABLES, PORTS, TERMINATIONS, AND FACEPLATE. ALL PRODUCTS SHALL BE BY SIEMON. PROVIDE SIEMON RECOMMENDED TESTING AND CERTIFICATION. PROVIDE SINGLE CABLE FOR TELEPHONE OUTLETS.
- 37. DEBRIS REMOVAL FROM THE CONSTRUCTION SITE WILL BE COMPLETED BY A PREDETERMINED ROUTE AT TIMES COORDINATED WITH OWNER.

- 38. ELECTRICAL CONTRACTOR SHALL CREATE A TYPE WRITTEN CIRCUIT DIRECTORY TO BE PLACED IN EACH PANEL ASSOCIATED WITH THIS PROJECT WHICH SHALL INCLUDE PANEL NUMBER AND DATE.
- 39. ELECTRICAL CONTRACTOR SHALL COORDINATE WITH LATEST VERSION OF ALL EQUIPMENT VENDOR DRAWINGS AND PROVIDE ALL ITEMS LISTED AS PROVIDED AND/OR INSTALLED BY OWNER, CONTRACTOR, OR BY ANYONE OTHER THAN EQUIPMENT VENDOR.
- 40. ALL ELECTRONIC DOOR CONTROLS SHALL BE CONNECTED TO THE FIRE ALARM SYSTEM AND WIRED TO RELEASE/UNLOCK DOORS UPON FIRE ALARM AND/OR POWER OUTAGE.
- 41. ELECTRICAL CONTRACTOR SHALL PROVIDE CONTROLS FOR ALL LIGHT FIXTURES. EACH LIGHTED SPACE SHALL HAVE SWITCHES INSTALLED AT EACH ENTRANCE TO THE SPACE, INCLUDING ANY NECESSARY COMBINATION OF 3-WAY AND 4-WAY SWITCHES.
- 42. ELECTRICAL DEVICES SHALL BE ARRANGED PER ARCHITECTURAL DRAWINGS AND SPACED PER NEC MINIMUM REQUIREMENTS.
- 43. UNLESS OTHERWISE NOTED ALL BRANCH CIRCUIT CONDUCTORS SHALL BE COPPER AND SIZED PER NEC WITH A TEMPERATURE RATING OF 75° C. INCREASE CONDUCTOR SIZES AS NECESSARY FOR NEC REQUIRED DERATING, AND TO ADJUST FOR VOLTAGE DROP NOT EXCEEDING 2%.
- 44. COORDINATE WITH MECHANICAL CONTRACTOR FOR REQUIREMENTS OF ATC CIRCUITS AND OVERCURRENT PROTECTION

DEVICES AND PROVIDE HACR CIRCUIT BREAKERS AND/OR FUSES WITH SPECIFIED TIME DELAY AS REQUIRED.

- 45. HALF SHADED LIGHT FIXTURES SHALL BE EQUIPPED WITH AN INTEGRAL BATTERY BACKUP BALLAST UNLESS WIRED TO A CIRCUIT SPECIFIED ON THE LIFE SAFETY BRANCH OF POWER. REFER TO LIGHT FIXTURE SCHEDULE FOR ADDITIONAL INFORMATION.
- 46. EXIT SIGNS SHALL BE WIRED FOR CONSTANT ILLUMINATION AND CONNECTED TO LINE SIDE OF NEARBY LIGHTING CIRCUIT, AND IF AVAILABLE THEY SHALL BE WIRED TO A LIFE SAFETY LIGHTING CIRCUIT.
- 47. COORDINATE WITH FIRE ALARM VENDOR FOR APPROPRIATE INTENSITY SETTINGS ON ALL AUDIO/VISUAL FIRE ALARM DEVICES, FOR PROPER COVERAGE AT EACH LOCATION.
- 48. FIRE ALARM WIRING SHALL BE INSTALLED PER AHJ REQUIREMENTS AND ALL APPLICABLE STATE AND LOCAL CODES INCLUDING BUT NOT LIMITED TO NEPA CODES: 70, 70F, 72, AND 101
- INCLUDING, BUT NOT LIMITED TO, NFPA CODES: 70, 70E, 72, AND 101.

  49. ALL SMOKE/HEAT DETECTORS WITHIN THE PROJECT SHALL BE TESTED AND LABELED. PROVIDE VERIFICATION OF TEST
- RESULTS TO OWNER.

  50. PROVIDE FIRE ALARM AS—BUILT DRAWING SHOWING ALL DEVICE LOCATIONS, ADDRESSES, NODES, LOOPS, AND PIPING
- 51. ALL CIRCUIT BREAKERS SHALL HAVE AIC RATING EQUAL TO, OR GREATER THAN, THE AIC RATING OF THE PANEL IN WHICH THEY ARE INSTALLED. CIRCUIT BREAKERS SHALL NOT BE RELOCATED TO PANELS WITH GREATER AIC RATING THAN THE CIRCUIT BREAKER.
- 52. ALL NEW ELECTRICAL RECEPTACLES SHALL BE TESTED WITH AN ELECTRICAL RECEPTACLE ANALYZER APPROVED BY THE OWNER. A REPORT OF THE TEST RESULTS SHALL BE PROVIDED TO THE ENGINEER AND SHALL INDICATE ROOM NUMBER, RECEPTACLE ID, LINE VOLTAGE, CORRECT POLARITY, NEUTRAL TO GROUND VOLTS, GROUND TO GROUND VOLTS AND OHMS, TENSION, AND RECEPTACLE STATUS.
- 53. ALL CIRCUITS FOR DEVICES SERVING AUDIO VISUAL EQUIPMENT SHALL BE CONNECTED TO THE SAME PHASE OF ELECTRICAL POWER AND SERVED FROM THE SAME PANEL. ADJUST CIRCUIT ASSIGNMENTS AS REQUIRED. COORDINATE WITH OWNER'S A/V REPRESENTATIVE TO VERIFY DEVICES SERVING A/V EQUIPMENT.
- 54. CABLE TV OUTLETS SHALL BE PROVIDED WITH A BACKBOX, FACEPLATE, TERMINATION/UTILIZATION PORT, AND DEDICATED HOMERUN CABLE TO SOURCE. PROVIDE ALL TERMINATIONS.
- 55. PROVIDE (1) CABLE TV OUTLET IN EACH BEDROOM, (2) CABLE TV OUTLETS IN EACH LIVING ROOM, OFFICE, FITNESS ROOM, YOGA ROOM, AND COMMON ROOMS.
- 56. PROVIDE (2) TEL/DATA OUTLETS IN EACH LIVING ROOM, OFFICE, LOUNGE, FITNESS ROOM, YOGA, AND ALL COMMON
- 57. PROVIDE TELEPHONE OUTLETS IN EACH KITCHEN AND BEDROOM.

OR PATHWAYS.

- 58. PROVIDE CARBON MONOXIDE DETECTORS ON EACH FLOOR OF EACH UNIT.
- 59. ALL LIGHTING SHALL BE ENERGY STAR RATED AND CONFORM TO ALL LEED CERTIFICATION REQUIREMENTS.
- 60. THE ENTIRE ELECTRICAL INSTALLATION, INCLUDING LIGHTING, SHALL CONFORM TO ALL CONNECTICUT HOUSING FINANCE AUTHORITY "CHFA" STANDARDS.
- 61. ALL 120V, 15 AND 20 AMP, SINGLE POLE, CIRCUIT BREAKERS SHALL BE LISTED AS COMBINATION TYPE AFCI.
- 62. ALL 120V, 15 AND 20 AMP, RECEPTACLES SHALL BE LISTED TAMPER RESISTANT.
- 63. ALL ELECTRICAL WORK SHALL BE IN ACCORDANCE WITH 2011 NEC.
- 64. WALLS AND CEILINGS ARE FIRE RATED CONSTRUCTION. ALL LIGHT FIXTURES, DEVICES, BOXES, AND OTHER ELECTRICAL EQUIPMENT INSTALLED IN WALLS AND CEILINGS SHALL BE FIRE RATED OR IN A FIRE RATED ENCLOSURE TO MAINTAIN THE FIRE RATING OF THE WALL/CEILING WHERE INSTALLED.
- 65. PROVIDE ALL ADA AND CHFA REQUIRED DEVICES IN EACH UNIT DESIGNATED FOR HEARING IMPAIRED INCLUDING, BUT NOT BE LIMITED TO: ILLUMINATED DOOR CHIME AND AUDIO/VISUAL FIRE ALARM NOTIFICATION DEVICES. NOTIFICATION DEVICES SHALL BE WIRED TO THE SAME CIRCUIT AS SMOKE AND CARBON DIOXIDE DETECTORS, AND UPON ANY ONE ALARM ALL DEVICES IN THE UNIT SHALL ACTIVATED.

# Washington Village Phase 1

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SHEET TITLE

ELECTRICAL
GENERAL NOTES

F-002

		LIGHT	ING FIXTURE S	CHED	ULE			
TYPE	MANUFACTURER	CATALOG NUMBER	NOTES		LAMP DA	101010	VOLTAGE	MOUNTING
		Laure a avenues was		NO.	WATTS	TYPE		
A	ARTEMIDE	SCONCE WALL	FINISH & TRIM BY ARCH	1	18	CFL	120	SURFACE
A1	ARTEMIDE	LED E26/A19	FINISH & TRIM BY ARCH	2	17	LED	120	SURFACE
В	OXYGEN	2-6135-24 JOURNEY CEILING MOUNT	FINISH & TRIM BY ARCH	2	26	QUAD CFL	120	SURFACE
с	OXYGEN	2-6136-224 JOURNEY CEILING MOUNT	FINISH & TRIM BY ARCH	1	22 40	T5 CIRCLINE	120	SURFACE
D	OXYGEN	3-692-224MODULO CEILING MOUNT	FINISH & TRIM BY ARCH	1	8.9	LED	120	SURFACE
E	PHILIPS	EW PROFILE POWERCORE	FINISH & TRIM BY ARCH	1	10	LED	120	SURFACE
F	PLC LIGHTING	SLICK-120V (TR14-WH) WHITE	FINISH & TRIM BY ARCH	1	45	MR16	120	TRACK
G	OXYGEN	2-5137-24-BP224	FINISH & TRIM BY ARCH	1	54	Т5НО	120	SURFACE
G1	SPRING CITY ELECTRICAL	WSH-PF83	FINISH & TRIM BY ARCH	1	150	HPS	120	SITE
G2	KIM LIGHTING	1SA-SAR4-150MH120-BL	FINISH & TRIM BY ARCH	(1)	150	мн	120	SITE
н	PANASONIC	WHISPERGREEN FV- 08VKL1 80 CFM	FINISH & TRIM BY ARCH	2	18 4	CFL	120	RECESSED
J	LIGHTWAY	CSLC-11-A-1Q26-3-W2-WSA- ES	FINISH & TRIM BY ARCH	1	26	CFL	120	SURFACE
к	NEO RAY	14DIW - 21T5-04-1EB-SI-EB- SI-EM-GLR-S14	FINISH & TRIM BY ARCH	3	28	Т5	120	SURFACE
L	NEO RAY	PENTAFLEX TM 79PF1T5-16- 1EB-SI-GLR	FINISH & TRIM BY ARCH	-1	<u>a</u> :	T5	120	RECESSED
М	COOPER LIGHTING	ML709827ICAT120D 900 SERIES LED DIMMABLE MODULE	FINISH & TRIM BY ARCH	1	14	LED	120	RECESSED
N	PRECISION ARCH.	LMS01-PH-SE-4-CT-FO1M- 120-T5HO-DIM	FINISH & TRIM BY ARCH	1	54	Т5НО	120	PENDANT
P1	ARTEMIDE	TAGORA - 970 SUSPENSION	FINISH & TRIM BY ARCH	4	24	тъно	120	PENDANT
P2	ARTEMIDE	TAGORA - 570 SUSPENSION	FINISH & TRIM BY ARCH	4	36	TT5	120	PENDANT
Р3	ARTEMIDE	TAGORA - 270 SUSPENSION	FINISH & TRIM BY ARCH	2	26	CFL	120	PENDANT
Q	NEMO	LUNA 320 - MEDIUM F	FINISH & TRIM BY ARCH	1	20	LED	120	RECESSED
R	OXYGEN	2-6205-24 ECHO PENDANT	FINISH & TRIM BY ARCH	1	23	GU24	120	PENDANT
s	ARTEMIDE	LOGICO TRIPLE LINEAR SUSPENSION	FINISH & TRIM BY ARCH	3	17	LED	120	PENDANT
U	BELUX	SANTON AND THE SANTON TO S	FINISH & TRIM BY ARCH	1	70	HALOGEN	120	PENDANT
w	PROGRESS	ALPHA TRACK P9104-09 WITH 3X P6112-09 FIXTURES	FINISH & TRIM BY ARCH	TBD	TBD	тво	120	TRACK
x	BEGHELLI	BS100-T5HO	FINISH & TRIM BY ARCH	2	24	Т5НО	120	SURFACE
Y	LITE- TECH	LS-4-54T5HO - 120 EL	FINISH & TRIM BY ARCH	1	54	тъно	120	SURFACE
z	тво	тво	FINISH & TRIM BY ARCH	TBD	TBD	тво	120	TBD
<b>Z1</b>	SOVEREIGN	тво	FINISH & TRIM BY ARCH	TBD	TBD	TBD	TBD	TBD
<b>Z2</b>	BEGHELLI	XLP-S3	FINISH & TRIM BY ARCH	TBD	TBD	TBD	TBD	TBD
AA	INVUE	ENV-CO2-LED-E1-BL4-BK- PC-277-BBB	FINISH & TRIM BY ARCH	2	54	LED	120	TBD
ВВ	OXYGEN	Executation in the contract to	FINISH & TRIM BY ARCH	2	13	CFL	120	WALL
BBB	OXYGEN	2-707-16 NEOMA SCONCE	FINISH & TRIM BY ARCH	2	13	CFL	120	WALL
сс	OXYGEN	2-711-224 TELSHOR VANITY	FINISH & TRIM BY ARCH	2	26	CFL	120	WALL

#### LIGHT FIXTURE NOTES:

- 1. FOR PRICING, CONTRACTOR SHALL CARRY AN ALLOWANCE OF \$300 FOR EACH UNSPECIFIED LIGHT FIXTURE.
- 2. ALL LIGHTING FIXTURES SHALL BE ENERGY STAR RATED AND CONFORM TO ELECTRIC UTILITY COMPANY REQUIREMENTS.
- 3. REFER TO ARCHITECTURAL REFLECTED CEILING PLANS AND INTERIOR ELEVATIONS FOR EXACT LOCATIONS AND MOUNTING HEIGHTS OF ALL LIGHTING FIXTURES.
- 4. HALF-SHADED LIGHT FIXTURE INDICATES WIRED TO LIFE SAFETY CIRCUIT. INSTALL SUPERVISORY BY PASS RELAY FOR ALL LIGHTING CONNECTED TO LIFE SAFETY CICUITS. REFER TO DETAILS.
- 5. DIMMERS TO BE COMPATIBLE WITH LIGHTING FIXTURES ON CIRCUIT.
- 6. THE ELECTRICAL CONTRACTOR SHALL VERIFY ALL CEILING TYPES AND/OR COORDINATE ALL FIXTURE TRIMS PRIOR TO PURCHASE OF FIXTURES.
- 7. ALL FLUORESCENT BALLASTS SHALL BE ELECTRONIC PROGRAM START TYPE AND SUITABLE FOR LAMPS SERVED. ALL FIXTURES SHALL BE PROVIDED WITH ONE BALLAST (UNLESS OTHERWISE INDICATED).
- 8. ALL COMPACT FLUORESCENTS SHALL BE PROVIDED WITH HIGH POWER FACTOR BALLASTS.
- 9. ELECTRICAL CONTRACTOR SHALL FURNISH AND INSTALL ALL LIGHTING FIXTURES COMPLETE WITH MOUNTING HARDWARE AND LAMPS.
- 10. CATALOG NUMBER SHOWN REPRESENTS FIXTURE FAMILY ONLY. ITEM DESCRIPTION SHALL BE USED TO DETERMINE FINAL FIXTURE MODEL #.
- 11. ALL FLUORESCENT LAMPS SHALL HAVE A COLOR TEMPERATURE SPECIFIED BY ARCHITECT.
- 12. ALL BATTERY OPERATED EMERGENCY FIX TURES SHALL BE CHARGED FROM NEARBY LIFE SAFETY CIRCUITS, AND SHALL BE WIRED TO MONITOR THE LINE SIDE OF THE NORMAL POWER LIGHTING CIRCUIT SERVING THE AREA.
- 13. INTERIOR AND EXTERIOR LIGHTING MUST CONFORM TO CHFA REQUIREMENTS.
- 14. EXTERIOR LIGHTING SHALL BE CONTROLLED BY A PHOTOCELL AND WIRED THROUGH A TIME CLOCK.

	LEGEND OF C		AND CONDUCT	OR				
FEEDER SYMBOL	CONDUCTORS (SINGLE OR 3 PHASE, 3 WIRE) WITH GROUND	RACEWAY SIZE CONDUIT	CONDUCTORS (3 PHASE, 4 WIRE) WITH GROUND	raceway Size Conduit	NOMINAL AMPERE RATING			
(1)	3#4 & 1#10G.	1"		4 4 / 4 7	60			
$\frac{\langle 2 \rangle}{\langle 3 \rangle}$	3#4 & 1#8G.	1"	4#4 & 1#10G.	1 1/4"				
4	" "		4#4 & 1#8G.	1 1/4"	70			
(5)	3#1 & 1#8G.	1 1/2"		4.4/07	100			
$\frac{\langle 6 \rangle}{\langle 7 \rangle}$	3#1 & 1#6G.	1 1/2"	4#1 & 1#8G.	1 1/2"	-			
\(\frac{7}{8}\)	3η · α. · η σο.	1 1/2	4#1 & 1#6G.	2"	125			
9	3#1/0 & 1#6G.	1 1/2"			150			
(10)		0"	4#1/0 & 1#6G.	2"				
<u>\langle 11\rangle</u> \langle 12\rangle	3#2/0 & 1#6G.	2"	4#2/0 & 1#6G.	2"	175			
(13)	3#3/0 & 1#6G.	2"	1 1,12,70 00 1,1700.		l			
(14)			4#3/0 & 1#6G.	2"	200			
(15)	3#4/0 & 1#4G.	2"		0.4/0"	225			
<u> </u>	3#250 KCMIL & 1#4G.	2 1/2"	4#4/0 & 1#4G.	2 1/2"	-			
(18)			4#250 KCMIL & 1#4G.	3"	250			
(19)	3#350 KCMIL & 1#4G.	3"			300			
(20)	3#500 KCMIL & 1#3G.	7 1/2"	4#350 KCMIL & 1#4G.	3"	-			
<u>\langle 21\rangle</u> \langle 22\rangle	3#300 KCMIL & 1#36.	3 1/2"	4#500 KCMIL & 1#3G.	4"	350			
23>	3#600 KCMIL & 1#3G.	3 1/2"			400			
24>			4#600 KCMIL & 1#3G.	4"	400			
\(\frac{25}{26}\)	6#250 KCMIL & 2#2G.	2-2 1/2"	8#350 KCMI * 3#30	2-3"	500			
(27)	6#350 KCMIL & 2#1G.	2-3"	8#250 KCMIL & 2#2G.	2-3				
28>	. "		8#350 KCMIL & 2#1G.	2-3"	600			
(29)	6#600 KCMIL & 2#1/0G.	2-3 1/2"			800			
\(\sqrt{30}\)	0#400 VCMII 8-3#2/0C	3–3"	8#600 KCMIL & 2#1/0G.	2-4"	-			
32	9#400 KCMIL &3#2/0G.	J - J	12#400 KCMIL &3#2/0G.	3–3"	1000			
33	9#600 KCMIL & 3#3/0G.	3-3 1/2"	" " " " " " " " " " " " " " " " " " " "		1200			
<u>34</u>		. = . 4- **	12#600 KCMIL & 3#3/0G.	3–4"	1200			
\(\sqrt{35}\) \(\sqrt{36}\)	12#600 KCMIL & 4#4/0G.	4-3 1/2"	16#600 KCMIL & 4#4/0G.	4-4"	1600			

NOTES:

1. FEEDERS SHALL BE PROVIDED WITH MAC ADAPTERS AS REQUIRED TO COORDINATE WITH BREAKER LUG SIZES.

2. SEE SPECIFICATIONS FOR ACCEPTABLE CONDUCTOR TYPES.

HP	EIA (1)	NEMA (2)	OD (7)	HOD (0)	FUSE	S (3)	ø WIRE	GROUND	CONDUIT	
HP	FLA (1)	STARTER	C.B. (3)	MCP (2)	NEC	T.D.	(4)	WIRE (5)	(6)	
1/2	2.4	1	20	7	10	4	12	12	3/4	
3/4	3.5	1	20	7	10	5	12	12	3/4	
1	4.6	1	20	7	15	10	12	12	3/4	
1 1/2	6.6	1	20	7	20	10	12	12	3/4	
2	7.5	1	20	15	25	15	12	12	3/4	
3	10.6	1	30	15	30	20	10	10	3/4	
5	16.7	1	40	30	50	30	10	10	3/4	
7 1/2	24.2	1	50	30	70	40	8	10	3/4	
10	30.8	2	70	50	90	50	6	8	3/4	
15	46.2	3	100	70	150	80	4	8	1	
20	59.4	3	150	100	175	100	2	6	1 1/4	
25	74.8	3	175	100	225	125	1	6	1 1/2	
30	88	4	200	150	250	150	1/0	6	1 1/2	
40	114	4	250	150	350	200	2/0	4	2	
50	143	5	300	150	400	250	4/0	4	2	
60	169	5	400	250	500	300	250KCMIL	3	2 1/2	
75	211	5	400	400	600	350	400KCMIL	3	3	
100	273	6	500		800	450	600KCMIL	2	4	

## Washington Village Phase 1

# 13 Day Street Building A

Norwalk, CT

Trinity Washington Village Limited Partnership &

the Norwalk Housing Authority



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N — 09-15-2014 PERMIT/ PRICING 06-13-2014 PRICING 11-18-2013 40% CHFA 09-19-2013 CAM/ SPECIAL PERMIT MARK DATE DESCRIPTION

PROJECT NO.: 21222/CENTEK #13232.01
DRAWN BY: TJB
CHECKED BY: CKD

SHEET TITLE

ELECTRICAL SCHEDULES


#### ELECTRICAL WORK NOTES

INSTALL RECEPTACLES IN NEMA-3 LOCKABLE ENCLOSURE WITH LABEL STATING: "FOR TELCO USE ONLY". ENCLOSURE SHALL BE LOCATED CONVENIENT TO TELCO DEMARC. COORDINATE EXACT LOCATION WITH TELEPHONE COMPANY AND ARCHITECT.

GENERAL NOTE:


1. EACH CONDENSING UNIT CIRCUIT SHOWN SHALL ORIGINATE IN THE LOAD CENTER OF THE APARTMENT SERVED. REFER TO PANEL SCHEDULE FOR ADDITIONAL INFORMATION.

2. FOR ALL CAMERAS, PROVIDE WIRELESS RELAY TO BUILDING B.

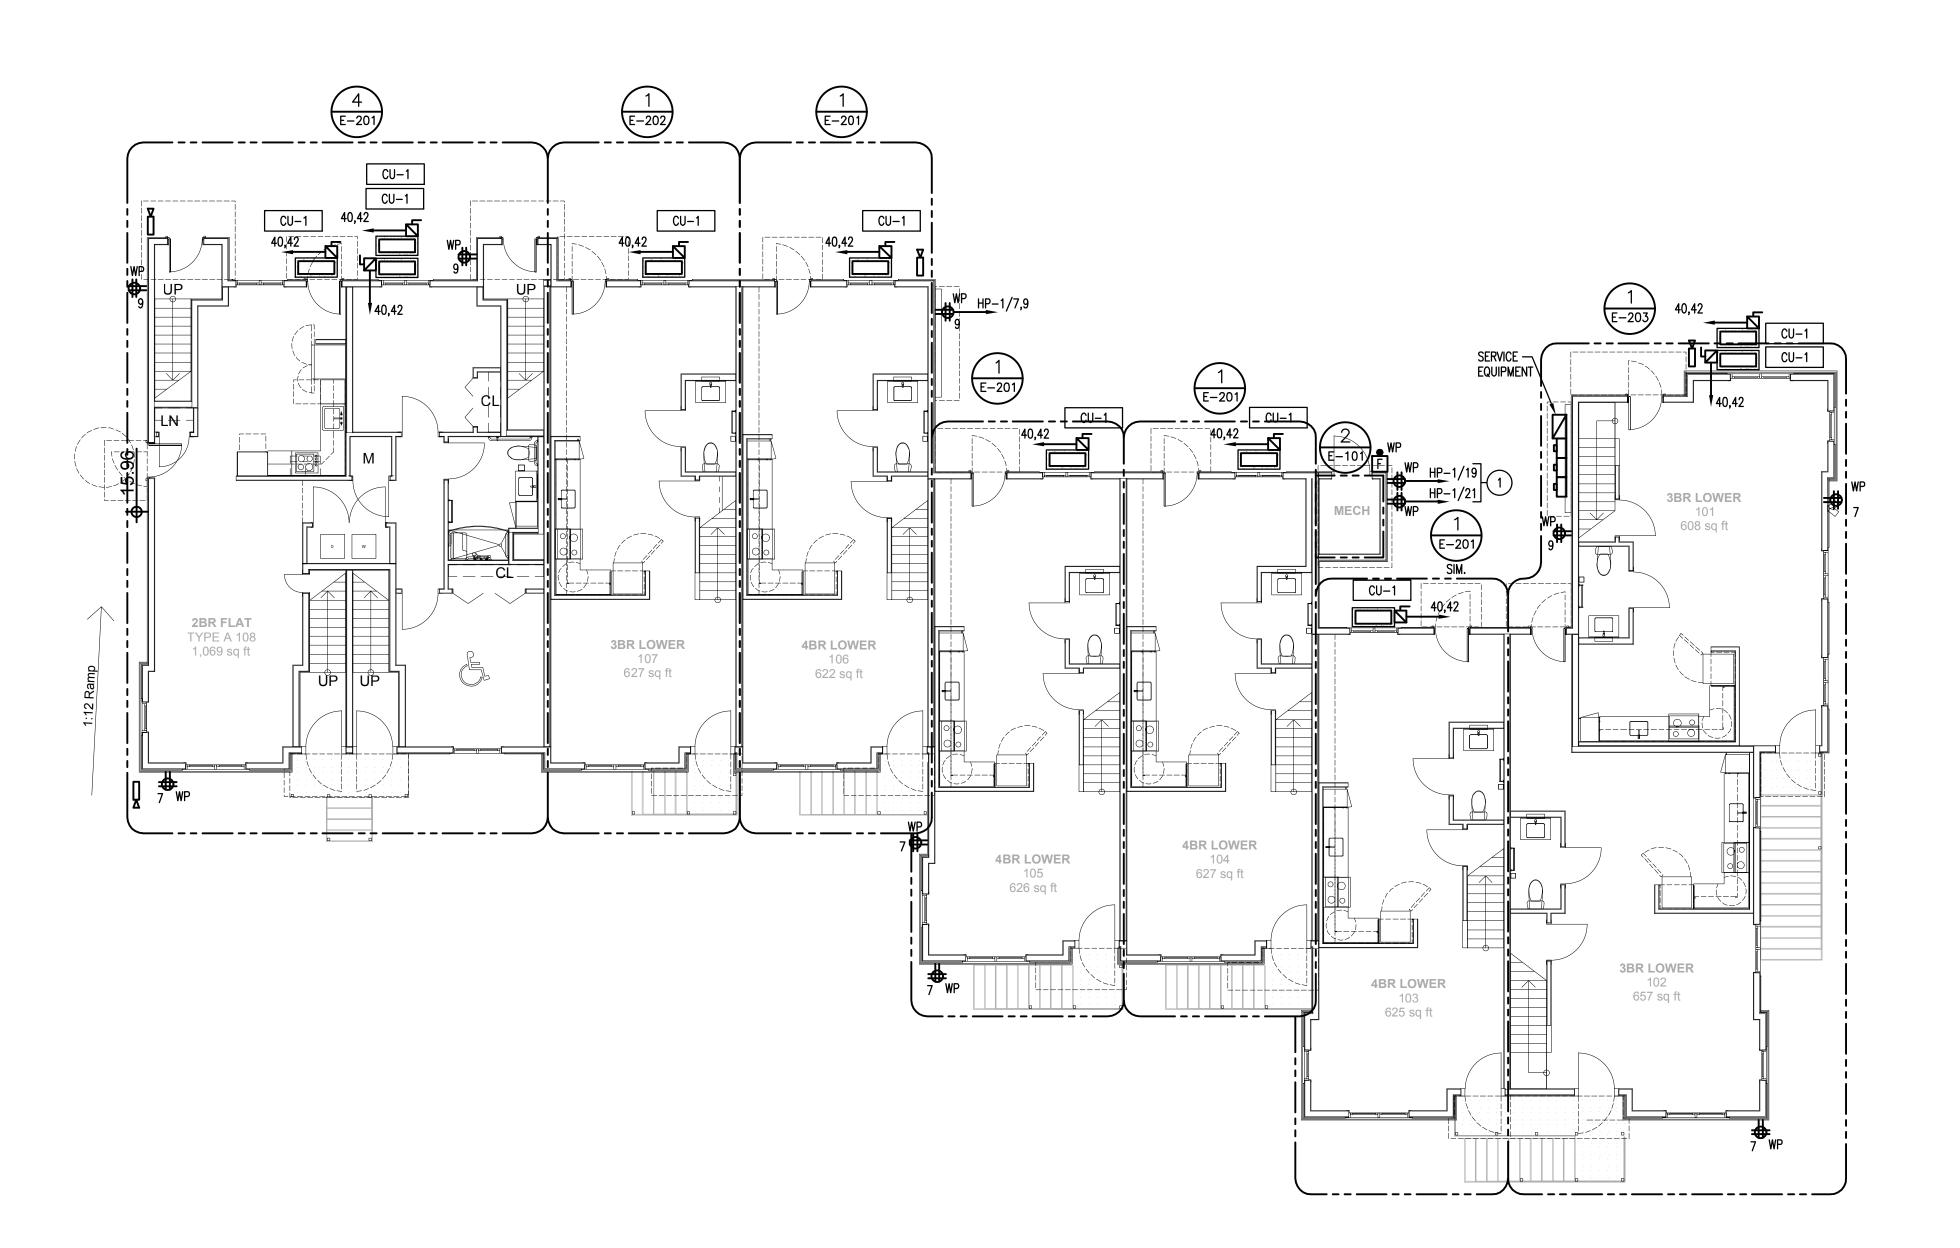

1 FIRST FLOOR PLAN - ELECTRICAL

SCALE: 1/8"=1'-0"

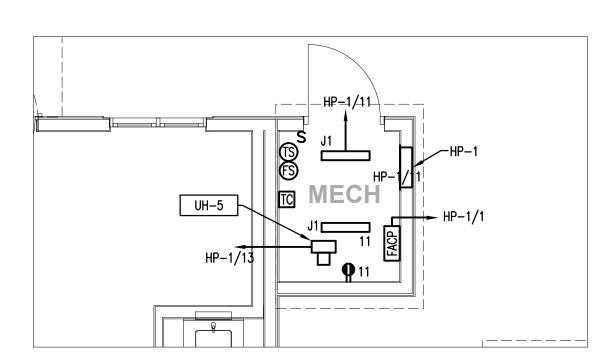

2 FIRST FLOOR MECHANICAL ROOM PLAN - ELECTRICAL
SCALE: 1/4"=1'-0"

## Washington Village Phase 1

#### 13 Day Street Building A

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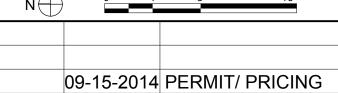
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SHEET TITLE

BUILDING A FIRST FLOOR PLANS- ELECTRICAL

E-101

PROJECT NORTH

1 SECOND FLOOR PLAN - ELECTRICAL

SCALE: 1/8"=1'-0"

## Washington Village Phase 1

## 13 Day Street Building A

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SHEET TITLE

BUILDING A SECOND FLOOR PLAN - ELECTRICAL



1 THIRD FLOOR PLAN - ELECTRICAL

SCALE: 1/8"=1'-0"

## Washington Village Phase 1

## 13 Day Street Building A

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DRAWN BY: TJB
CHECKED BY: CKD

SHEET TITLE

BUILDING A THIRD FLOOR PLAN - ELECTRICAL

PROJECT NORTH

1 RADON FAN WITH ALARM WIRING, LOCATED IN ATTIC. GENERAL NOTE:

. COORDINATE ALL WORK WITH ALL OTHER TRADES. REFER TO OTHER TRADE'S DRAWINGS FOR ADDITIONAL INFORMATION.

# Washington Village Phase 1

# 13 Day Street Building A

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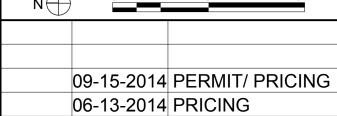
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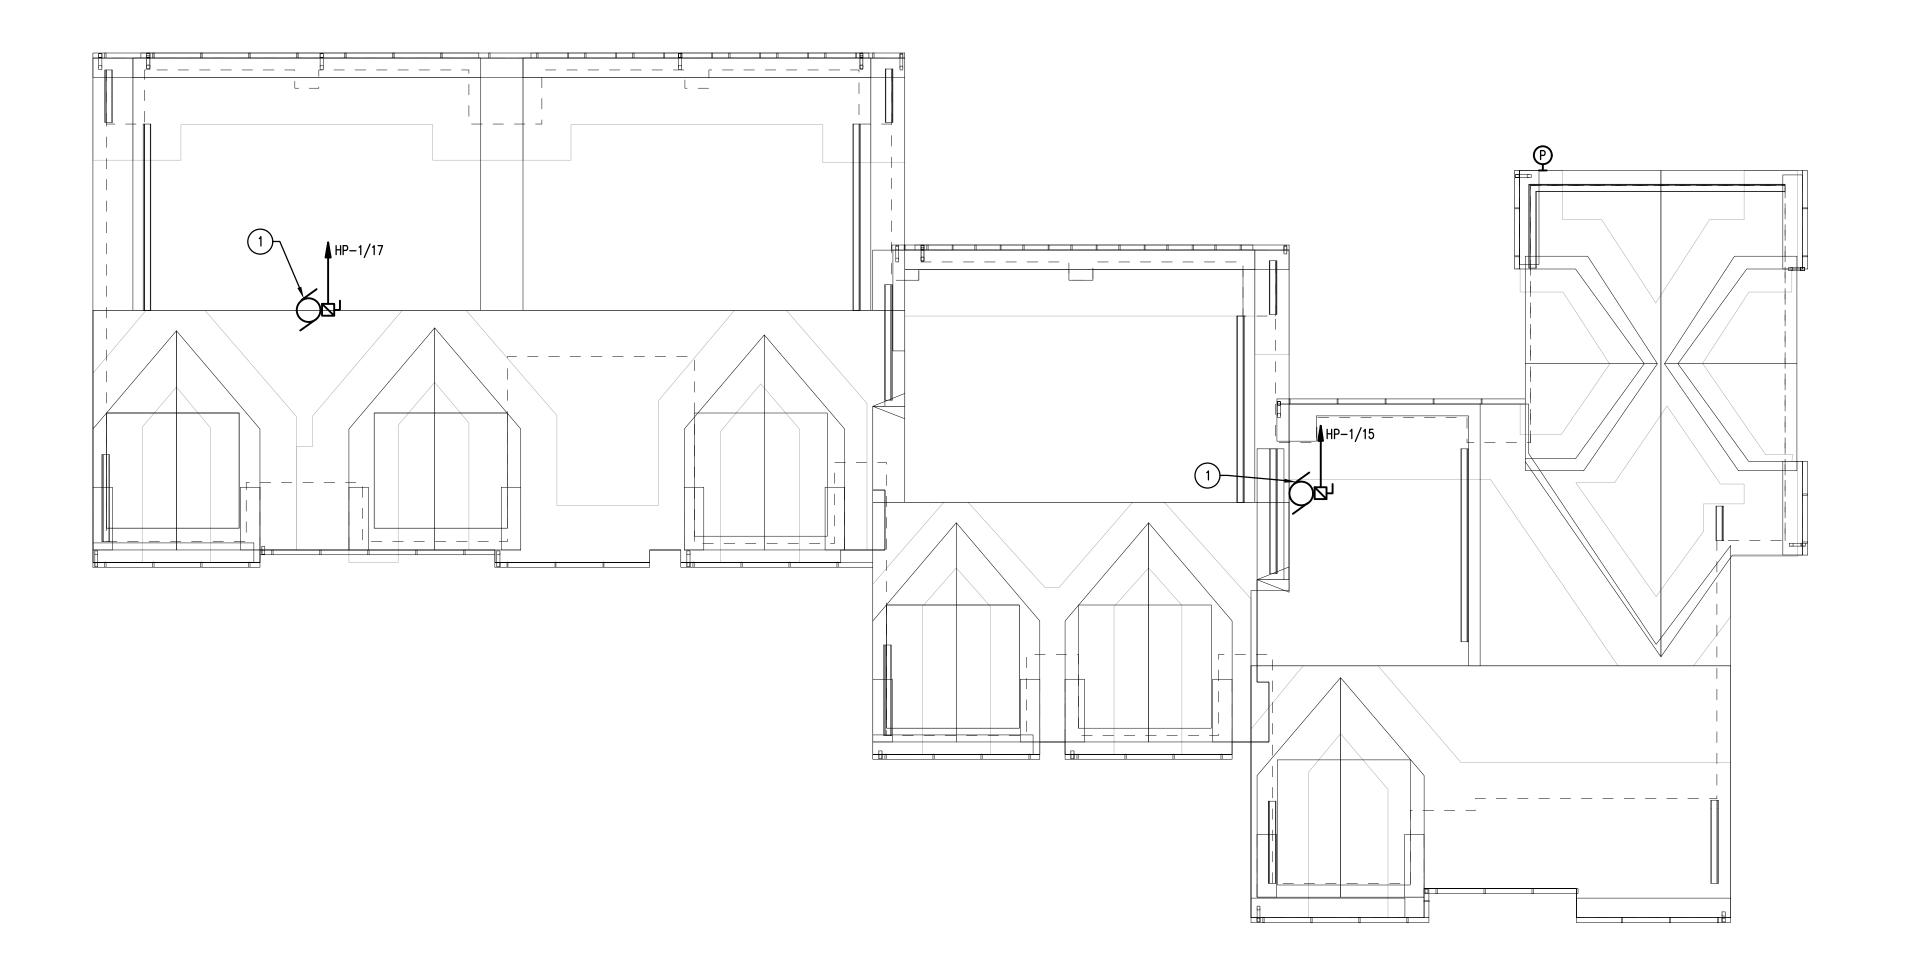
11-18-2013 40% CHFA 09-19-2013 CAM/ SPECIAL PERMIT MARK DATE DESCRIPTION

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SHEET TITLE

**BUILDING A ROOF PLAN** - ELECTRICAL

PROJECT NORTH



1 ROOF PLAN - ELECTRICAL

SCALE: 1/8"=1'-0"

SITE LIGHTING PLAN - ELECTRICAL

SCALE: 1"=10'-0"

#### ELECTRICAL WORK NOTES

1 PROVIDE 1"C, 2#6, #6G. TYPICAL FOR ENTIRE BRANCH CIRCUIT. FIXTURES SHALL BE CONTROLLED VIA TIMECLOCK AND PHOTOCELL.

GENERAL NOTE:

I. COORDINATE ALL WORK WITH ALL OTHER TRADES. REFER TO OTHER TRADE'S DRAWINGS FOR ADDITIONAL INFORMATION.

## Washington Village Phase 1

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SHEET TITLE

CHECKED BY: CKD

SITE LIGHTING PLAN- ELECTRICAL

PROJECT NORTH

#### ELECTRICAL WORK NOTES

1 PROVIDE 20A, 208V, 2P CIRCUIT WITH 3 #12, 1 #12 G. GENERAL NOTE:

DINING ROOM

- . COORDINATE ALL WORK WITH ALL OTHER TRADES. REFER TO OTHER TRADE'S DRAWINGS FOR ADDITIONAL INFORMATION.
- 2. REFER TO 4 BEDROOM UNIT FOR TYPICAL CIRCUIT ASSIGNMENTS.

# Washington Village Phase 1

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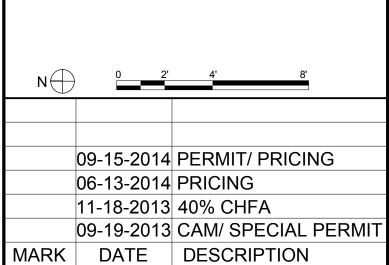
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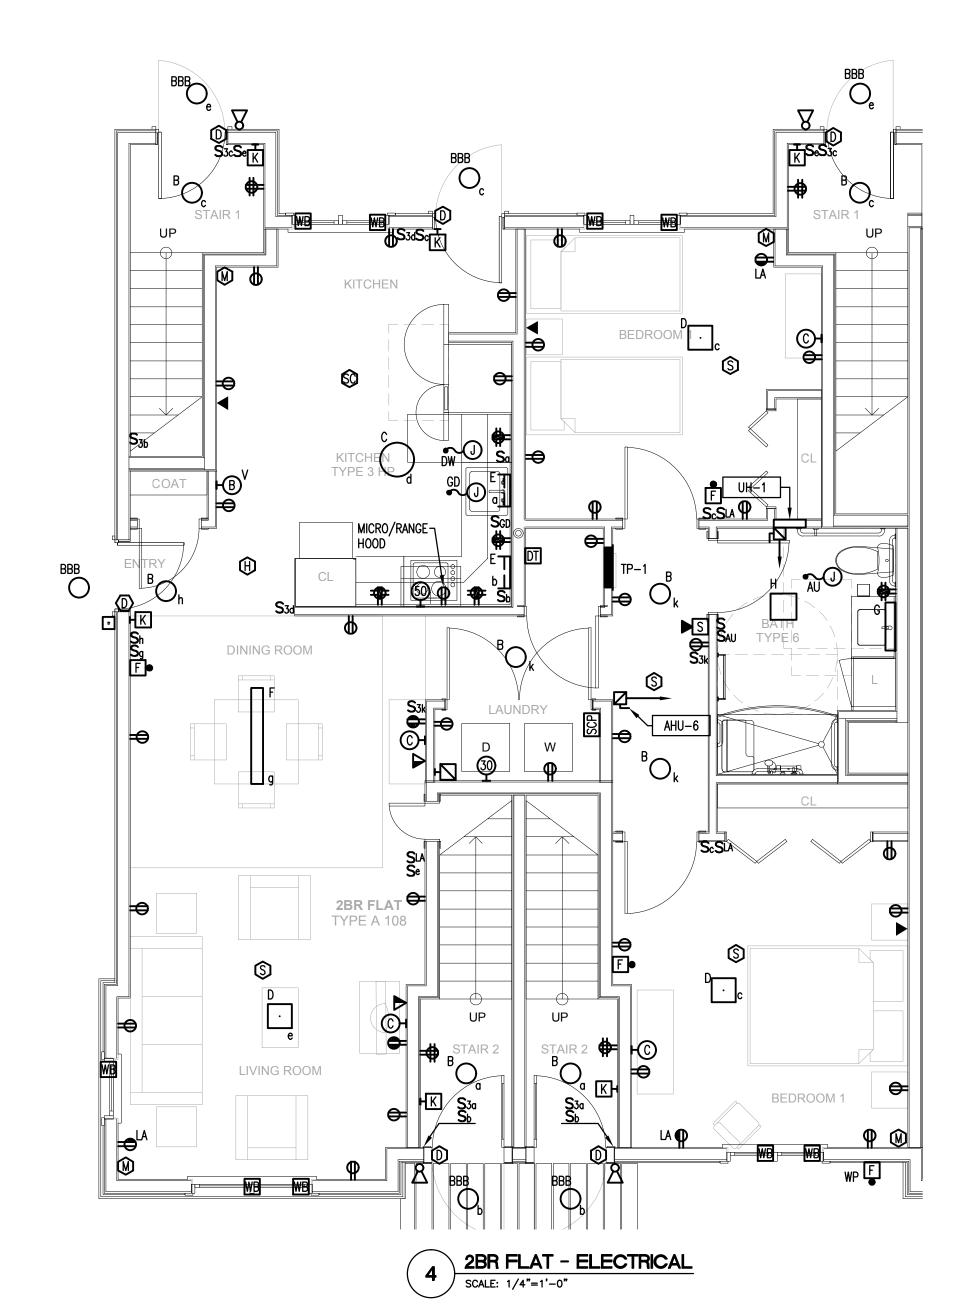



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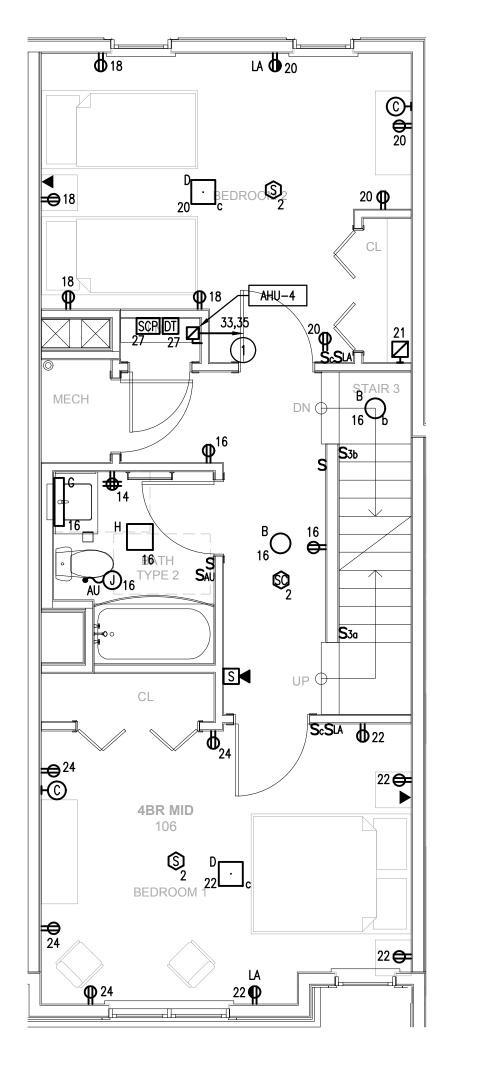
SHEET TITLE

TYPICAL UNIT PLANS **BUILDING A ELECTRICAL** 

E-201





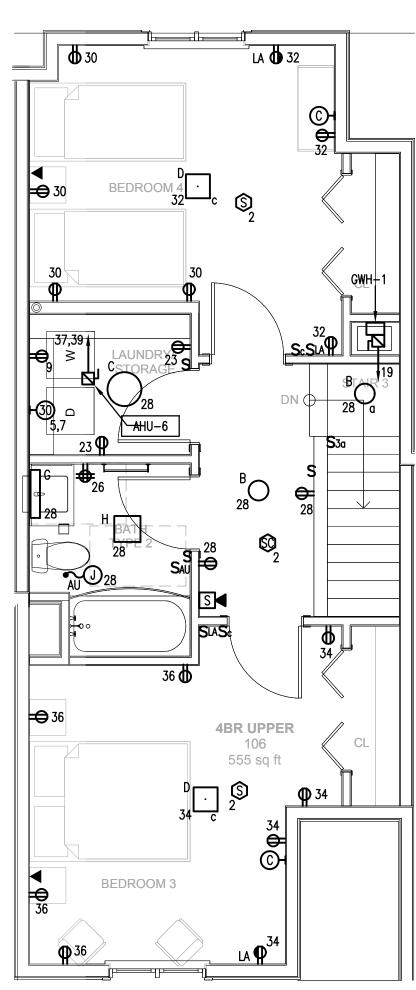








**4BR LOWER** 106

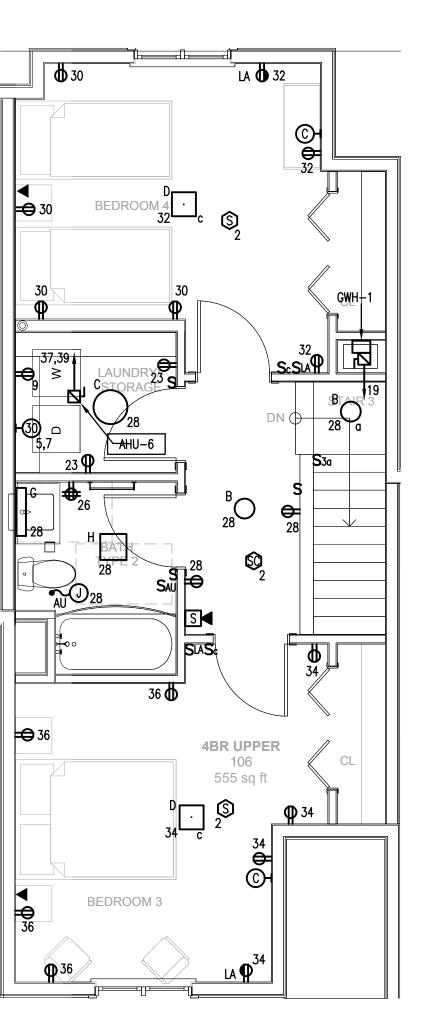

TOWNHOUSE THIRD FLOOR PLAN - ELECTRICAL

SCALE: 1/4"=1'-0"

(FOUR BEDROOM TOWNHOUSE)



#### ELECTRICAL WORK NOTES

GENERAL NOTE:


. COORDINATE ALL WORK WITH ALL OTHER TRADES. REFER TO OTHER TRADE'S DRAWINGS FOR ADDITIONAL INFORMATION.

2. REFER TO 4 BEDROOM UNIT FOR TYPICAL CIRCUIT ASSIGNMENTS.


TOWNHOUSE THIRD FLOOR PLAN - ELECTRICAL

(THREE BEDROOM TOWNHOUSE)

SCALE: 1/4"=1'-0"

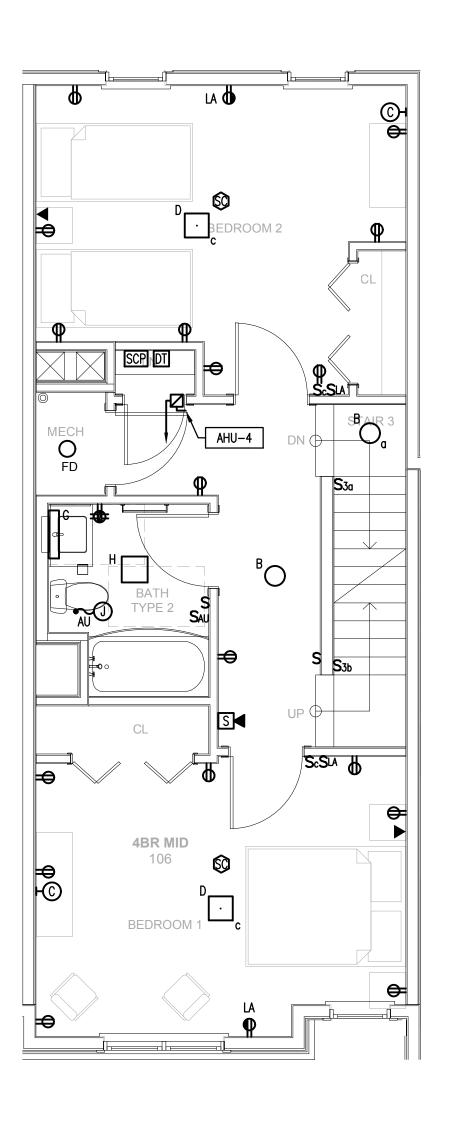



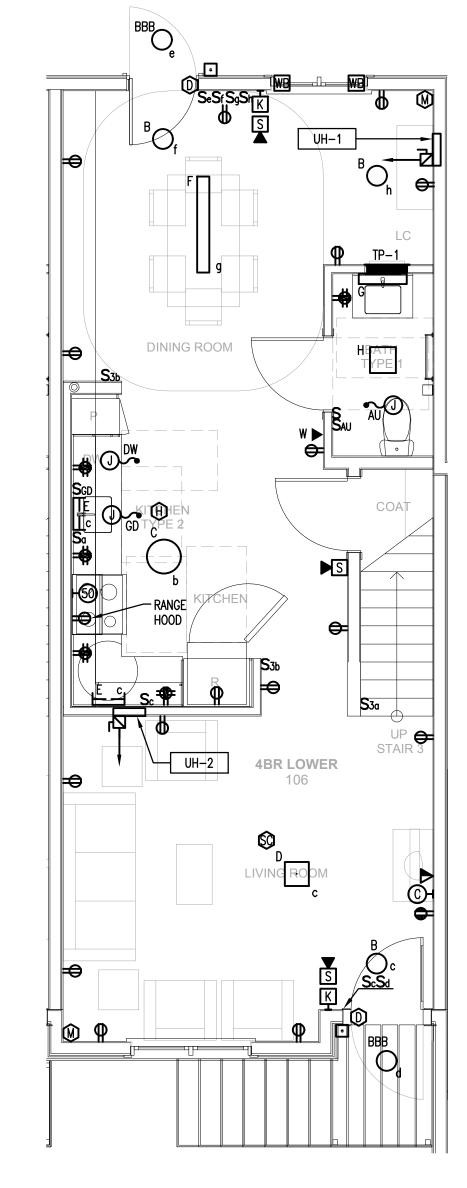

TOWNHOUSE FIRST FLOOR PLAN - ELECTRICAL

SCALE: 1/4"=1'-0" (THREE BEDROOM TOWNHOUSE) (THREE BEDROOM TOWNHOUSE)

# Washington Village Phase 1

13 Day Street Building A

Norwalk, CT

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the Norwalk Housing Authority




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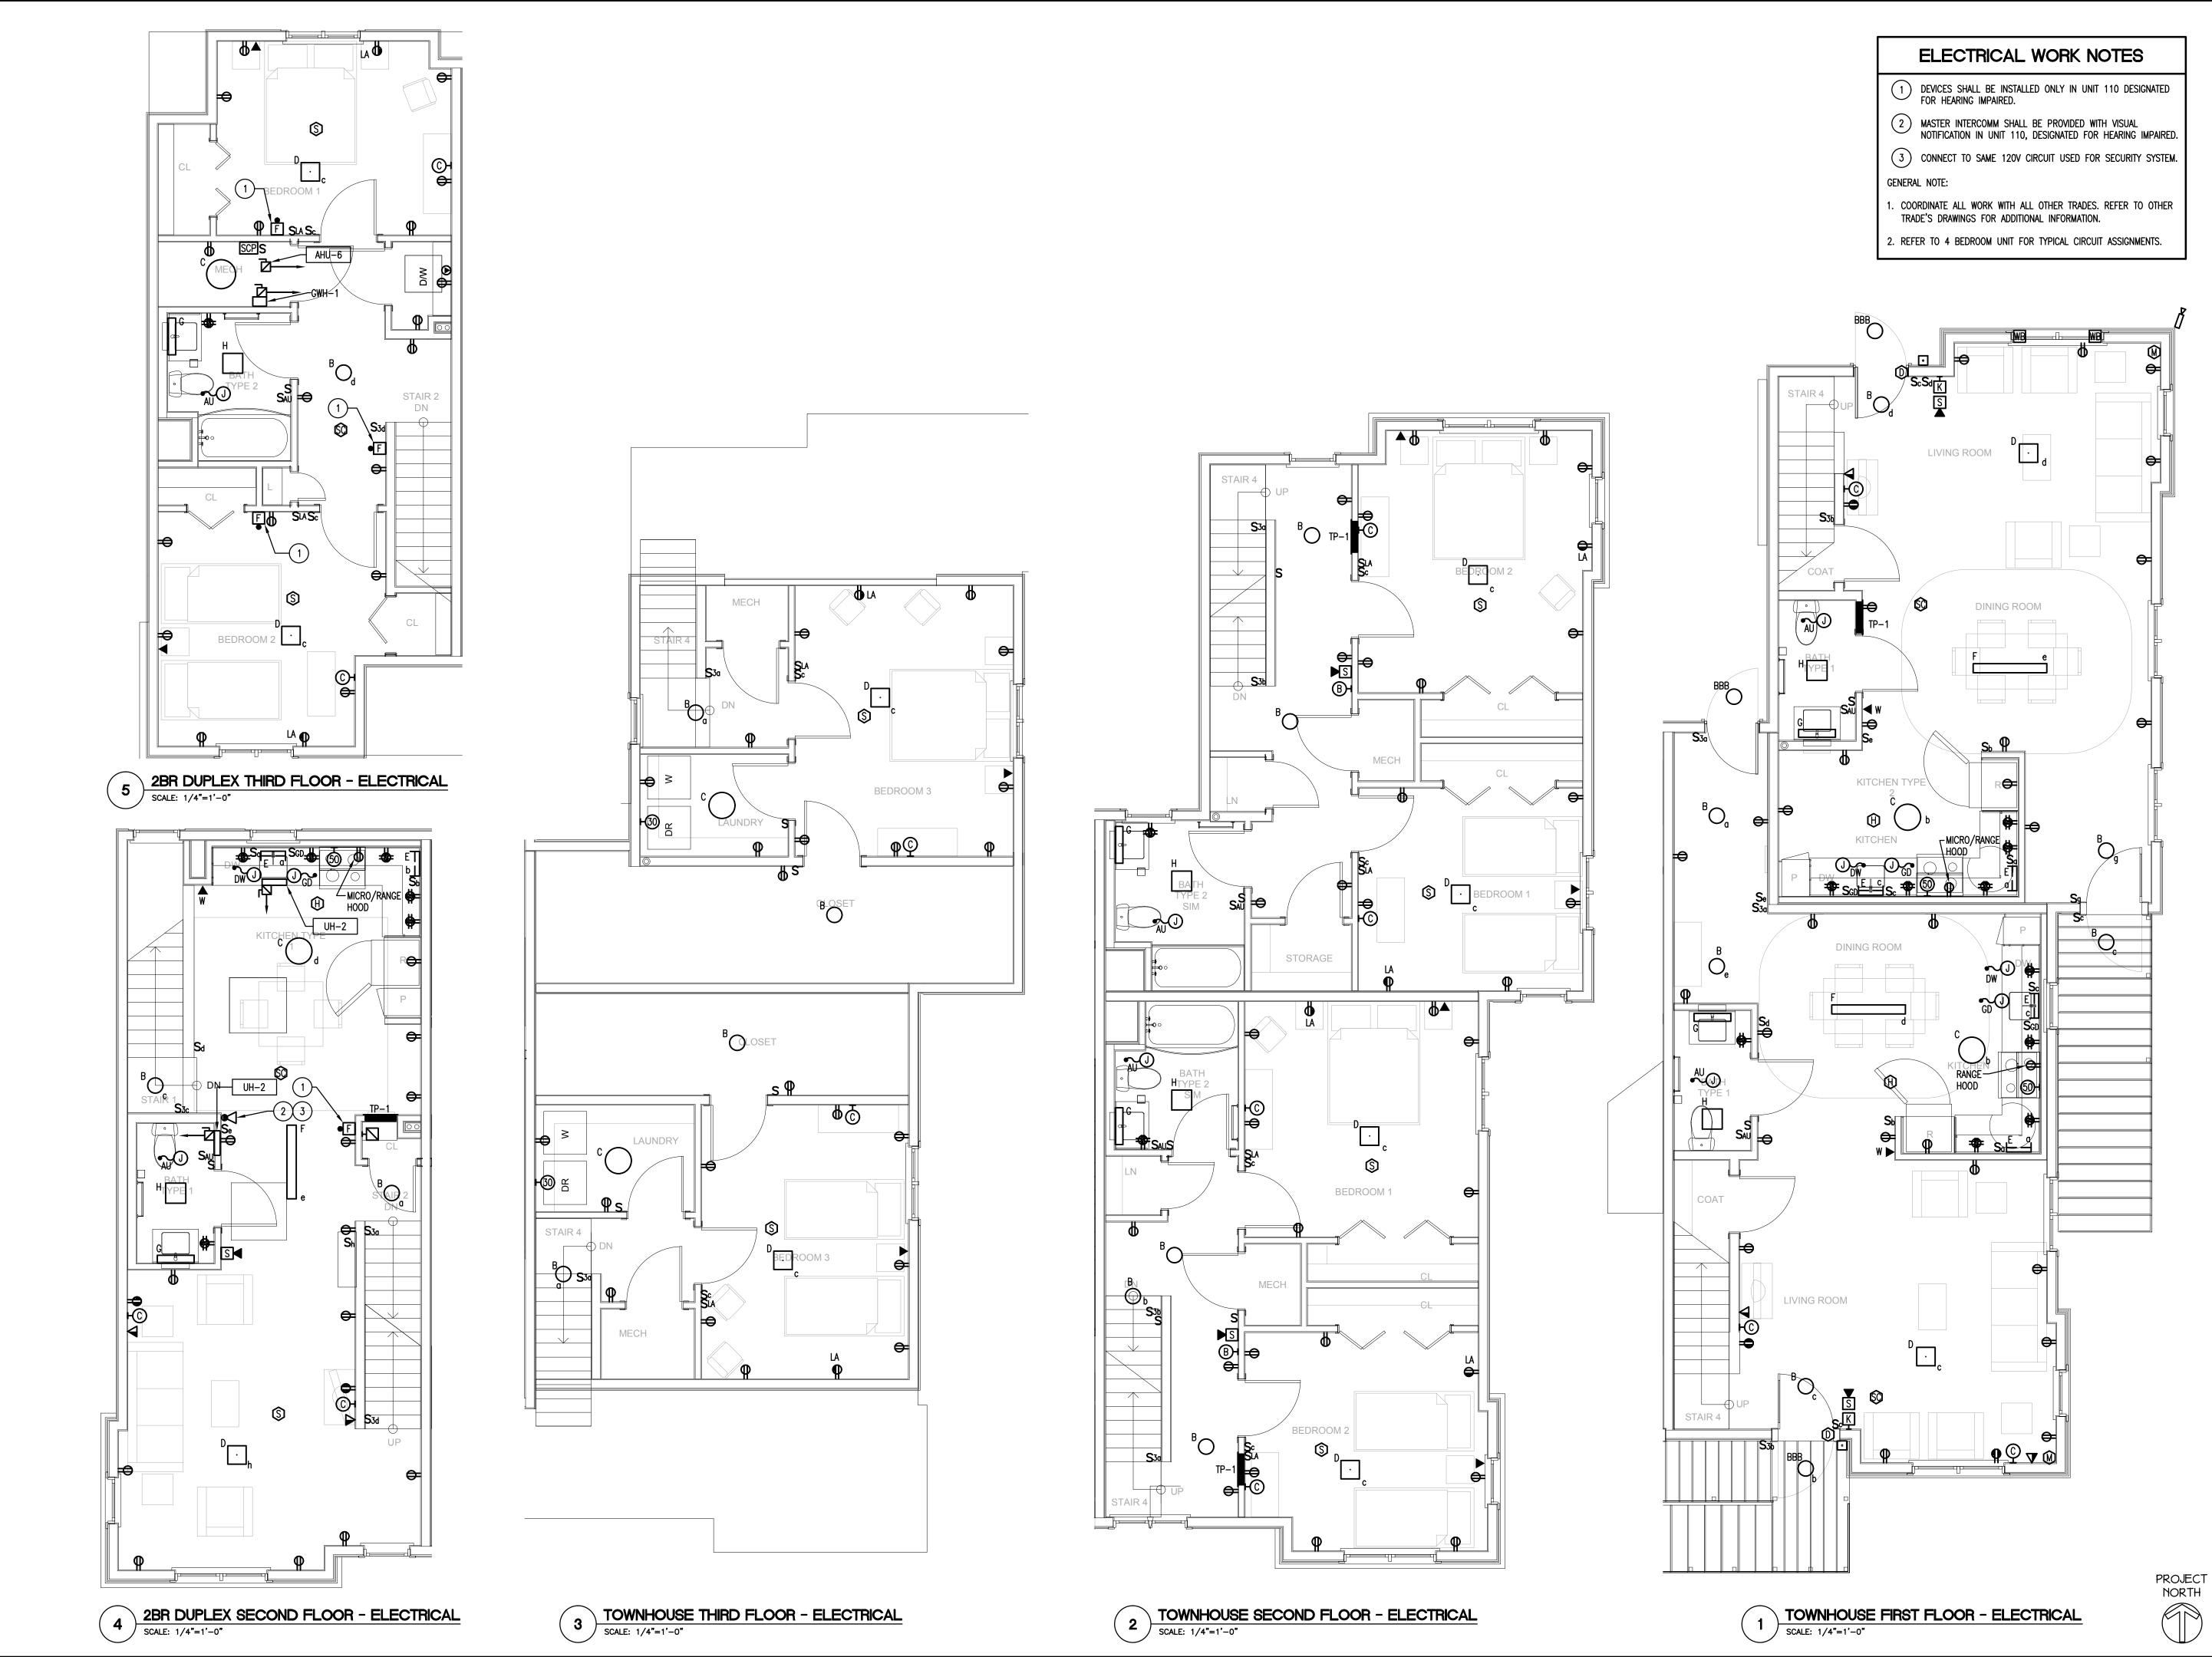


PROJECT NO.: 21222/CENTEK #13232.01 DRAWN BY: TJB CHECKED BY: CKD

SHEET TITLE

TYPICAL UNIT PLANS **BUILDING A** ELECTRICAL

PROJECT NORTH

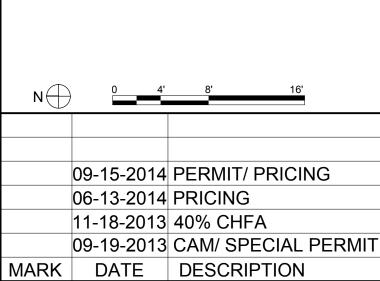

# Washington Village Phase 1

13 Day Street Building A

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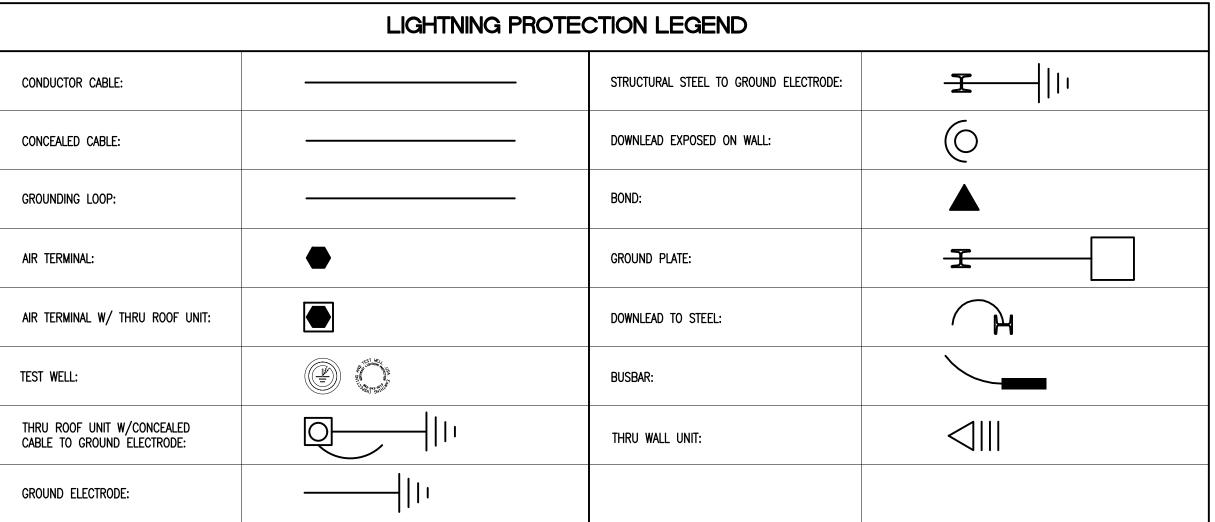
CHECKED BY: CKD

TYPICAL UNIT PLANS BUILDING A ELECTRICAL

	LIGHTNING PROTEC	CTION LEGEND	
CONDUCTOR CABLE:		STRUCTURAL STEEL TO GROUND ELECTRODE:	<del>I  </del>    -
CONCEALED CABLE:		DOWNLEAD EXPOSED ON WALL:	0
GROUNDING LOOP:		BOND:	
AIR TERMINAL:		GROUND PLATE:	<u> </u>
AIR TERMINAL W/ THRU ROOF UNIT:		DOWNLEAD TO STEEL:	H
TEST WELL:		BUSBAR:	
THRU ROOF UNIT W/CONCEALED CABLE TO GROUND ELECTRODE:		THRU WALL UNIT:	
GROUND ELECTRODE:	<del></del>		

## GENERAL NOTES

- 2. BOND WATER MAIN, ELECTRIC, CABLE TV, PHONE GROUNDS AND GAS OR OIL LINES IF SO STATED IN THE CONTRACT.
- 3. REFER TO PROJECT SPECIFICATIONS FOR DETAILED REQUIREMENTS OF LIGHTNING PROTECTION SYSTEM.



# MARK DATE DESCRIPTION



- PROVIDE CONTINUITY TO ALL METALLIC AND/OR ELECTRICALLY GROUNDED BODIES WITHIN 6 FEET OF THE MAIN LIGHTNING PROTECTION CONDUCTOR.

# Washington Village Phase 1

# 13 Day Street Building A

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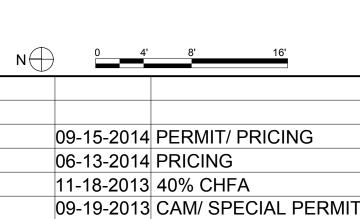
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PROJECT NO.: 21222/CENTEK #13232.01 DRAWN BY: TJB

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SHEET TITLE

**BUILDING A** ROOF PLAN -LIGHTNING PROTECTION

PROJECT NORTH


ROOF PLAN (BUILDING A) - ELECTRICAL LIGHTNING PROTECTION

SCALE: 1/8"=1'-0"

9<del>:12 | > | 9:12 |</del>

DS DS DS DS

## 1 BUILDING A ELECTRICAL RISER SCALE: NONE

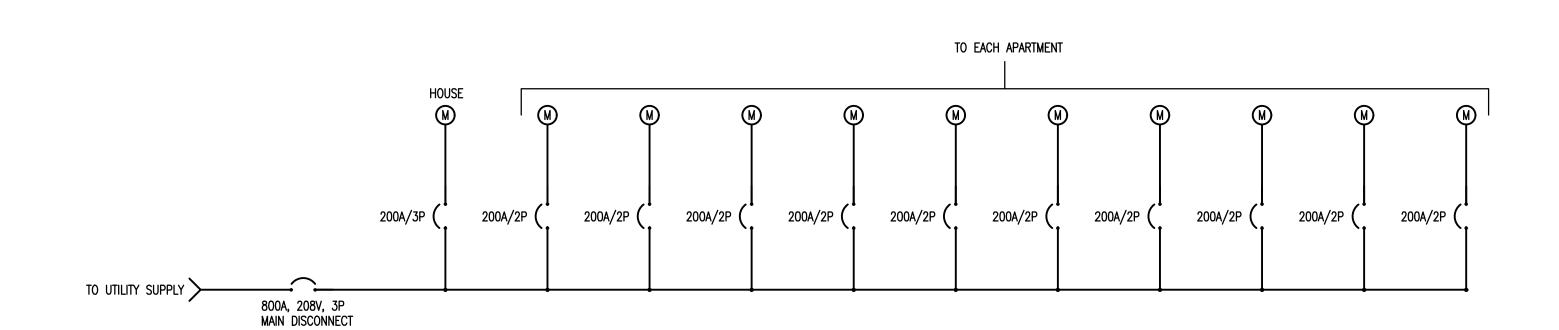

BUILDING A ELECTRIC UTILITY ONE LINE DIAGRAM

SCALE: NONE

#### ELECTRICAL RISER DIAGRAM NOTES

- CONDUITS AND CONDUCTORS FROM UTILITY COMPANY TRANSFORMER. COORDINATE WITH SITE ENGINEER AND UTILITY COMPANY.
- 800A, 208Y/120V, 3P, 4W, NEMA-3R, SE RATED, MAIN CIRCUIT BREAKER ENCLOSURE WITH 800A MAIN CIRCUIT BREAKER. AIC RATING SHALL BE GREATER THAN AVAILABLE FAULT CURRENT FROM UTILITY, AND SHALL NOT BE LESS THAN 65 KAIC.
- 3/0 SERVICE GROUND PER NEC. PROVIDE ALL NEC BONDING CONNECTIONS, INCLUDING TO WATER MAIN AND LIGHTNING PROTECTION.
- TWO 3-GANG AND ONE 4-GANG, NEMA-3R, MULTI-METER BRANCH UNITS. EACH BRANCH UNIT SHALL BE 120/208V, 3-PHASE INCOMING, AND 120/208V SINGLE PHASE OUTGOING, WITH 208V, 200A, 2P CIRCUIT BREAKERS PROVIDED FOR EACH UNIT. METER SOCKETS SHALL BE RINGLESS WITH LEVER BYPASS. ADDITIONAL OPTIONS/FEATURES SHALL BE PER UTILITY COMPANY REQUIREMENTS.
- 1-GANG BRANCH UNITS. NEMA-3R, 120/208V, 3P INCOMING, AND 120/208V 3P OUTGOING, WITH 208V, 200A, 3P CIRCUIT BREAKERS FOR HOUSE SERVICE. METER SOCKET SHALL BE RINGLESS WITH LEVER BYPASS. ADDITIONAL OPTIONS/FEATURES SHALL BE PER UTILITY COMPANY REQUIREMENTS.
- 6 NEW POWER PANEL: NEMA-1, FLUSH MOUNT, DOOR-IN-DOOR, COPPER BUS, BOLT ON BREAKERS, 42 POSITION, 200A, 240V, SINGLE PHASE, ALL SPACES POPULATED WITH 20A, 1P, SPARE BREAKERS, 200A MAIN CIRCUIT BREAKER, AIC RATING TO EXCEED AVAILABLE FAULT CURRENT.
- HOUSE PANEL: NEMA-1, FLUSH MOUNT, DOOR-IN-DOOR, COPPER BUS, BOLT ON BREAKERS, 42 POSITION, 200A, 240V, 3 PHASE, ALL SPACES POPULATED WITH 20A, 1P, SPARE BREAKERS, 200A MAIN CIRCUIT BREAKER, AIC RATING TO EXCEED AVAILABLE FAULT CURRENT.
- 8) ADJUST CONDUIT AND CONDUCTOR SIZES AS REQUIRED FOR MAXIMUM VOLTAGE DROP OF 2%.

#### **GENERAL NOTES:**

- 1. COORDINATE ALL REQUIREMENTS WITH UTILITY COMPANY AND PROVIDE ALL ELEMENTS NOT PROVIDED BY UTILITY COMPANY. ALL MATERIALS AND EQUIPMENT MUST BE UTILITY COMPANY APPROVED.
- ALL RESIDENTIAL UNIT ELECTRICAL PANELS SHALL BE SHOP PAINTED A CUSTOM COLOR SELECTED BY ARCHITECT.
  PROVIDE PANEL COVERS WITH PAINTABLE FINISH.
- 3. PROVIDE LABEL AT EACH METER INDICATING EACH UNIT NUMBER, AND THE HOUSE SERVICE.
- 4. PROVIDE FAULT CURRENT STUDY AND INSTALL LABEL INDICATING AVAILABLE FAULT CURRENT AND DATE OF STUDY, PER NEC REQUIREMENTS.
- 5. PROVIDE ARC FLASH WARNING LABEL ON ALL SERVICE AND DISTRIBUTION EQUIPMENT PER NEC REQUIREMENTS.
- 6. COORDINATE WITH SITE UTILITY PLAN.
- 7. INSTALL EXPANSION COUPLINGS WHERE CONDUITS EXTEND ABOVE GRADE.
- 8. METER BRANCH UNIT ARRANGEMENT SHOWN APPROXIMATE. ADJUST AS REQUIRED BY MFG AND TO AVOID CONFLICTS.

## Washington Village Phase 1

# 13 Day Street Building A

Norwalk, CT

Trinity Washington Village Limited Partnership

the Norwalk Housing Authority



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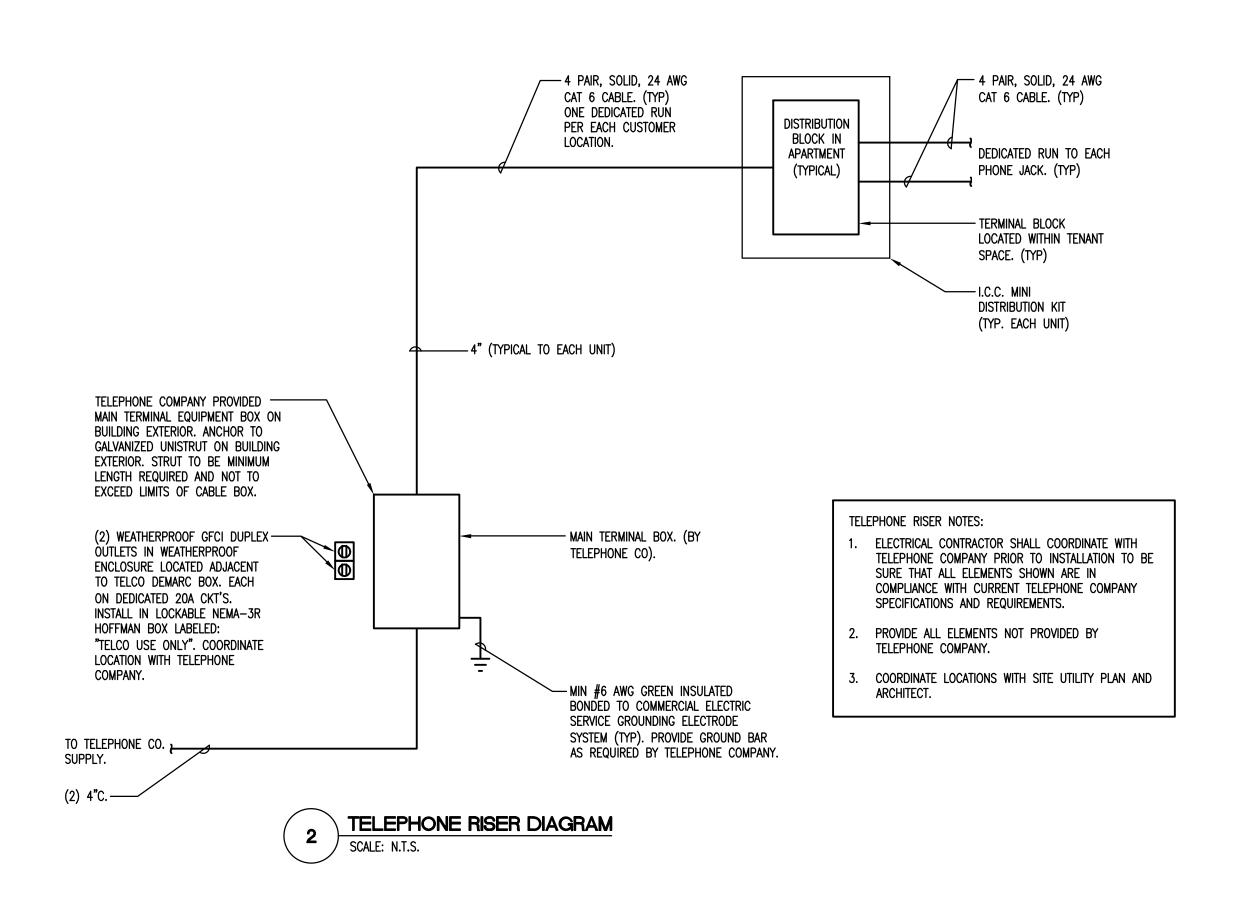
09-15-2014 PERMIT/ PRICING 06-13-2014 PRICING

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09-19-2013 CAM/ SPECIAL PERMIT
MARK DATE DESCRIPTION

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SHEET TITLE

ELECTRICAL RISER
DIAGRAM
(BUILDING A)



Washington Village Phase 1

13 Day Street Building A

Norwalk, CT

Trinity Washington Village Limited Partnership

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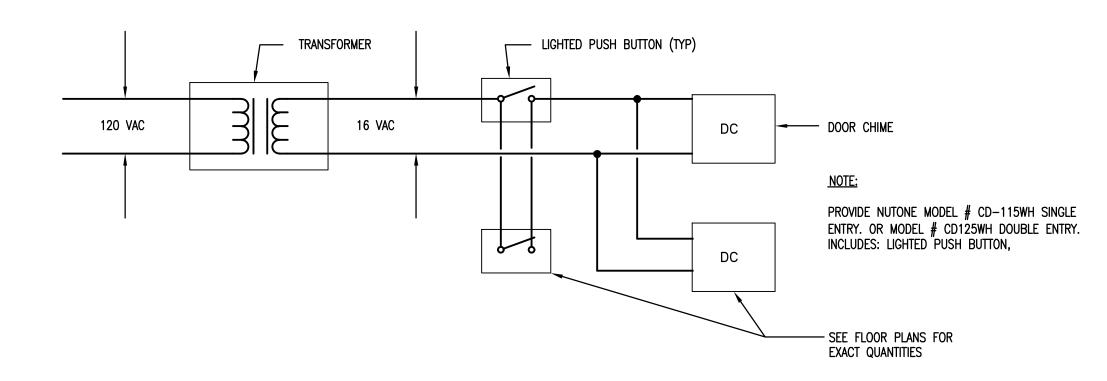
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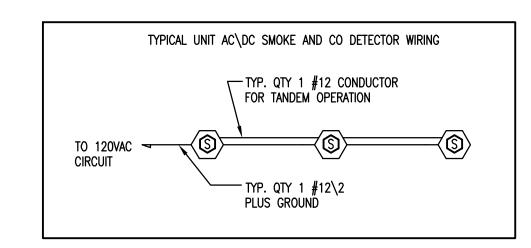
TELEPHONE AND CABLE RISER DIAGRAMS


## 1 DOOR CHIME SCHEMATIC (HANDICAPPED UNITS) SCALE: N.T.S.

AND TRANSFORMER (TYP)




## 3 DOOR CHIME SCHEMATIC SCALE: N.T.S.




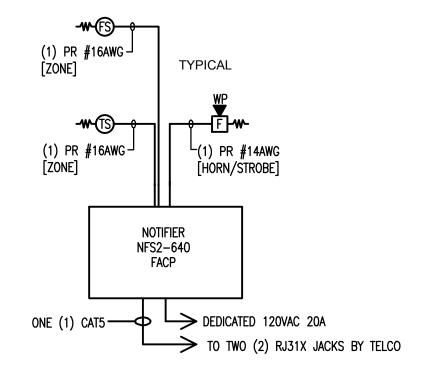

## 5 BUILDING A FIRE ALARM RISER DIAGRAM SCALE: N.T.S.

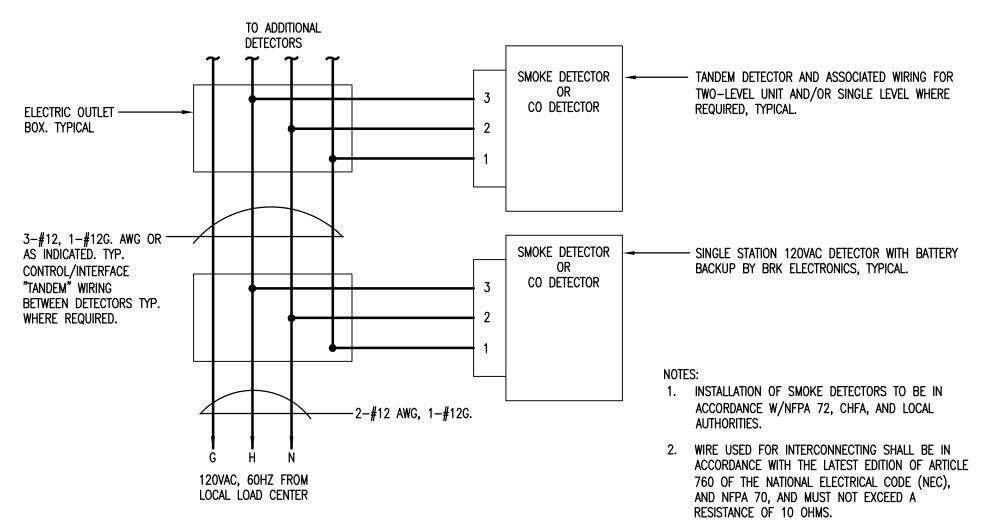

## 2 SMOKE AND CARBON MONOXIDE ALARM (TANDEM WIRING DIAGRAM) SCALE: N.T.S.

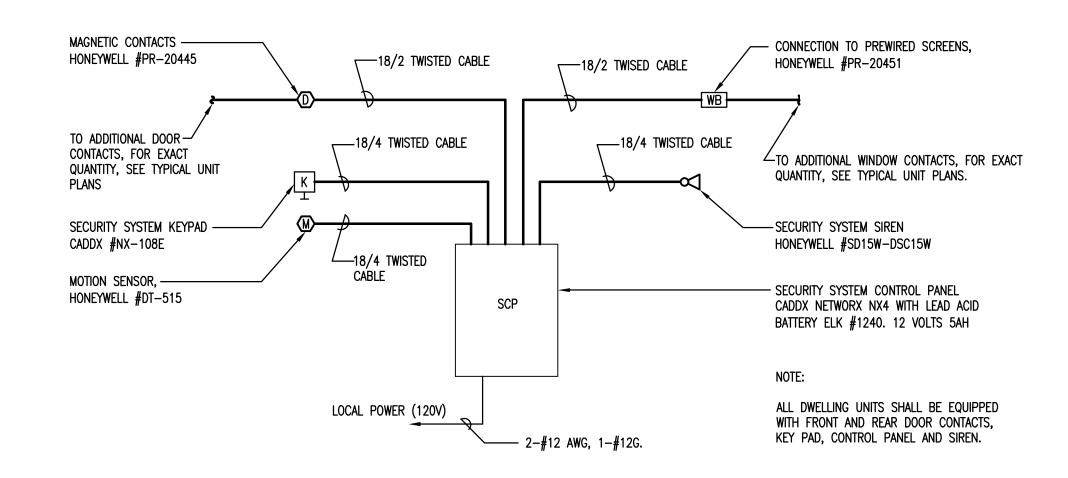

## 4 ONE-LINE UNIT SECURITY SYSTEM (TYP) SCALE: N.T.S.

## Washington Village Phase 1

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ELECTRICAL RISER DIAGRAMS

VOLTAGE:	120/208	PHASE:	3	WIRE:	4			TOTAL WAT	TS, L1	2,330	j:	PANEL	NO.	HP-1	Т
MAIN BUS:	225	AMPS		1				TOTAL WAT	TS, L2	2,380	Į.	1			
MAIN BREAKER:	200	A FRAM	E	200	A TRIP			TOTAL WAT	TS, L3	1,660	1	LOC.		MECH RM	Π
MOUNTING:								TOTAL WAT	TS	6,370				AND THE RESIDENCE OF THE PARTY	
NOTES:	225A, 20	)8Y/120V,	3P, 4W	, 65 KAI	c, 42 POS	SITION, DO	OOR-	N-DOOR, 225A	MCB, B	OLT-ON	BREAK	ERS, COP	PER BU	is.	
	w	ATTS LO	AD			L	.1 L	2 L3 Y			v	ATTS LO	AD		
DIRECTORY	L1	L2	L3	CKT.	AMPS				AMPS	CKT.	L1	L2	L3	DIRECTORY	
FIRE ALARM	250			1	20		•		20	2	900			SITE LIGHTING	Ī
SITE LIGHTING		1,200		3	20			$\overline{}$		4				SPACE	Т
SITE LIGHTING			1,200	5	20			$\overline{}$		6				SPACE	Т
RECEPT - EXTERIOR	900	. 1	į i	7	20		•	$\top$		8				SPACE	Π
RECEPT - EXTERIOR		900		9	20			$\Box$		10				SPACE	Т
RECEPT/LTG - MECH RM			360	11	20			$\overline{}$		12				SPACE	Т
UH-5	100			13	20					14				SPACE	Т
RADON FAN		100		15	20					16				SPACE	Π
RADON FAN			100	17	20			$\overline{}$		18				SPACE	П
RECEPT - TELCO	180			19	20		•	$\top$		20				SPACE	П
RECEPT - TELCO		180		21	20			$\Box$		22				SPACE	П
SPARE			j	23	20	$\sim$		$\neg$		24			Ĵ	SPACE	
SPARE				25	20		•			26				SPACE	Т
SPARE				27	20			$\top$		28				SPACE	
SPARE				29	20			$\overline{}$		30				SPACE	Т
SPARE			1	31	20					32				SPACE	Π
SPARE				33	20			$\Box$		34				SPACE	П
SPARE				35	20					36				SPACE	Т
SPARE				37	20					38				SPACE	Ī
SPARE				39	20					40				SPACE	
SPARE				41	20					42				SPACE	П

VOLTAGE:	240/120	PHASE:	_ 1	WIRE:	3	PAI	PANEL NO.		TP-1			
MAIN BUS:	200	AMPS				TOTAL WATTS, L1		22	,288			
MAIN BREAKER:					A TRIP TOTAL WATTS, L2				21,628		LOC:	PER PLAN
MOUNTING:	FLUSH		NOTES		TOTAL WATTS							
NOTES:	200A, 120/240, SINGLE PHASE, 3W, 65 KAIC, 42 POSITION, DOOR-IN-DOOR, 200A MCB, BOLT-ON BREAKERS. FRONT COVER/TRIM SHALL HAVE PAINTABLE FINISH AND BE FIELD PAINTED AN ARCH APPROVED COLOR.											
	WATTS LOAD			320	L <sup>1</sup>	1 L2 Y Y		007		WATT	SLOAD	
DIRECTORY	L1	L2	CKT.	AMPS				AMPS	CKT.	L1	L2	DIRECTORY
OVEN	4,000		1	50/2P			$\overline{}$	20	2	250		SMOKE / CO DETECTORS
OVEN		4,000	3	30/2P	$\neg$	1	$\overline{}$	20	4		400	REC - 1ST FL BATHROOM
DRYER	2,500		5	30/2P				20	6	900		REC - DINING
DRIER		2,500	7	30/25	$\Box$	1		20	8		350	LTG - KITCHEN/DINING
WASHING MACHINE	1,200		9	20	$\overline{}$		$\Box$	20	10	1,000		REC/LTG - FAMILY ROOM
DISHWASHER		1,200	11	20	$\Box$	•	$\Box \frown$	20	12		1,000	REC/LTG - FAMILY ROOM
MICROWAVE	1,200		13	20	$\sim$		$\sim$	20	14	180		REC - 2ND FL BATHROOM
RECEPT - KITCHEN		1,500	15	20		1	$\overline{}$	20	16		900	REC/LTG - 2ND FLOOR
RECEPT - KITCHEN	1,500		17	20	$\overline{}$		$\overline{}$	20	18	720		REC/LTG - 2ND FL BEDRM
WATER HEATER - GWH-1		200	19	20	$-\Box$	•	$\overline{}$	20	20		800	REC/LTG - 2ND FL BEDRM
RECEPT - NET MEDIA CTR	360	6	21	20	$\sim$		$\sim$	20	22	720		REC/LTG - 2ND FL BEDRM
RECEPT - LAUNDRY		1,500	23	20	$\Box$	•	$\overline{}$	20	24		800	REC/LTG - 2ND FL BEDRM
REC - FRIDGE	1,200		25	20	-		$\overline{}$	20	26	180		REC - 3RD FL BATHROOM
SECURITY/DOORBELL		500	27	20	$-\Box$	1	$_{\sim}$	20	28		1,100	REC/LTG - 3RD FLOOR
GARBAGE DISPOSAL	1,500		29	20	$\sim$		$\overline{}$	20	30	720		REC/LTG - 3RD FL BEDRM
UNIT HEATERS			31	20	$-\Box$	_		20	32		800	REC/LTG - 3RD FL BEDRM
AHU-4	200		33	20/2P	$-\Box$		-	20	34	800		REC/LTG - 3RD FL BEDRM
nos.e		200	35	LUILI	$-\bigcirc \bot$	_		20	36		720	REC/LTG - 3RD FL BEDRM
AHU-6	350		37	20/2P	$\sim$		-	20	38			SPARE
		350	39		$\neg \Box$	_		30/2P	40		2,808	CU-1
SPARE			41	20	0				42	2,808		

## Washington Village Phase 1

## 13 Day Street Building A

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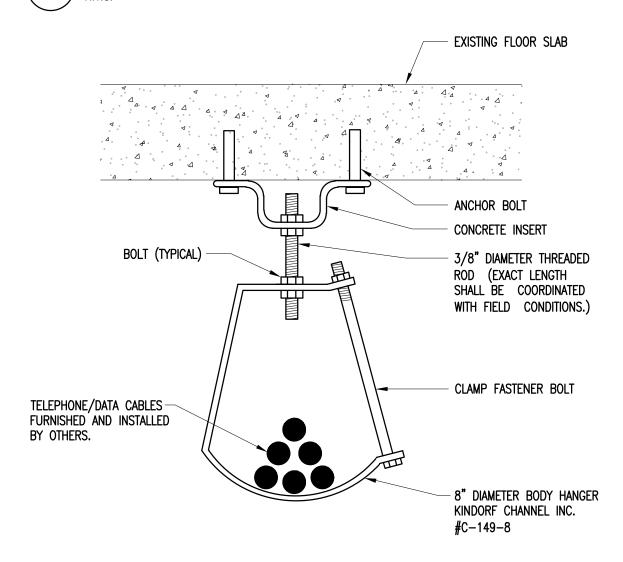
BUILDING A ELECTRICAL PANELBOARD SCHEDULES

PROJECT NORTH


#### NOTES:

- 1. REFER TO SPECIFICATIONS FOR FOR ADDITIONAL NAMEPLATE REQUIREMENTS.
- 2. PROVIDE WARNING LABEL ON ALL SWITCHBOARDS, DISTRIBUTION PANELS, PANELBOARDS IN ACCORDANCE WITH NEC 110.16.


#### 1 DETAIL OF HOUSE PANEL FLASH PROTECTION WARNING SIGN N.T.S.



4 CABLE HOOK SUPPORT SYSTEM N.T.S.

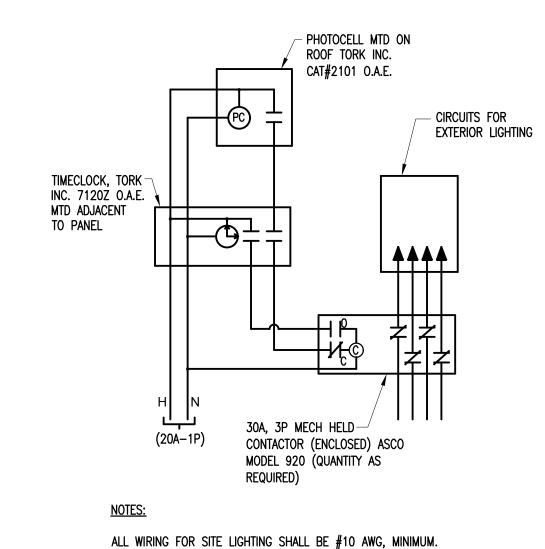


7 EXTERIOR SITE LIGHTING CONTROL WIRING DIAGRAM

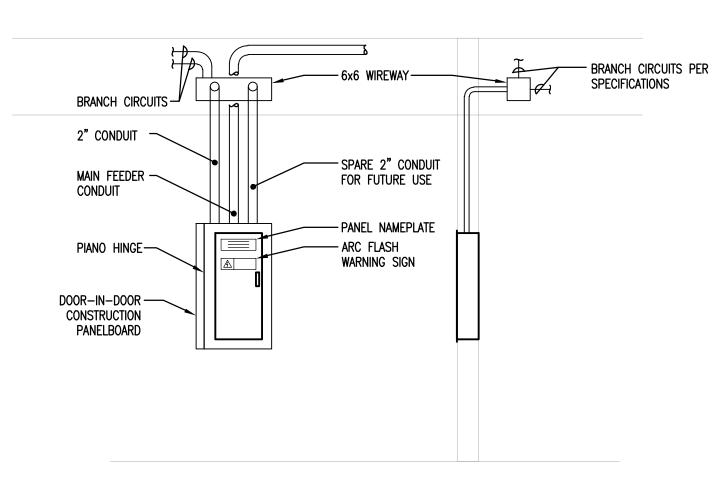



2 TYPICAL PANELBOARD DETAIL

N.T.S.

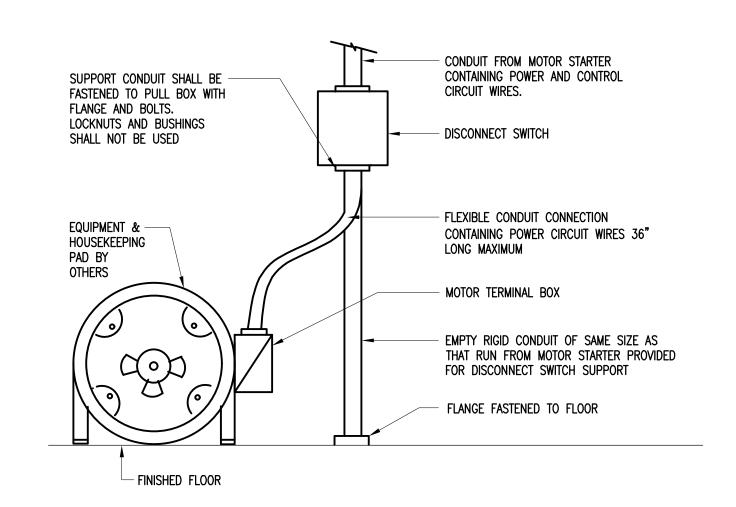


5 DETAIL OF MOTOR DISCONNECT SWITCH MOUNTING
N.T.S.

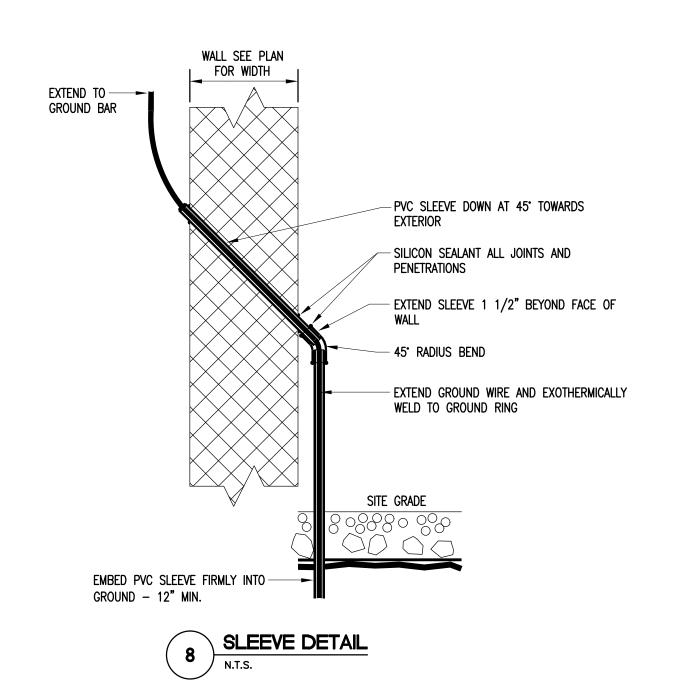

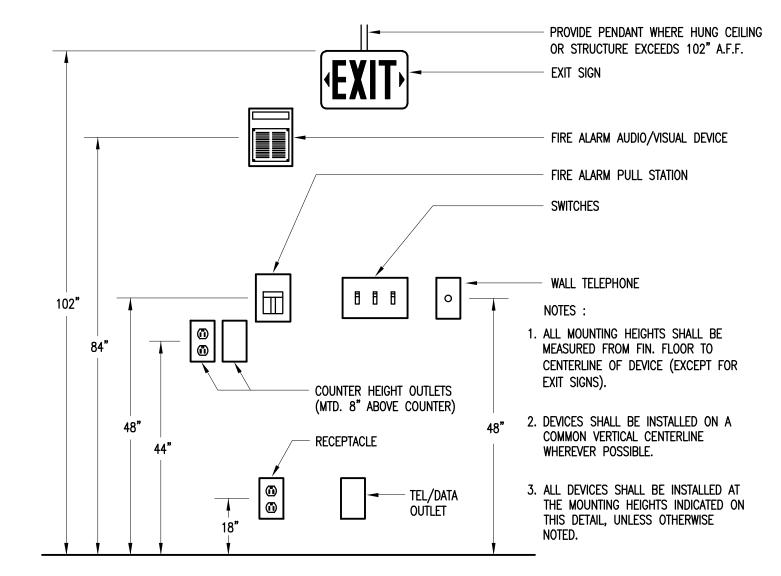


3 TYPICAL DEVICE MOUNTING HEIGHTS DETAIL

N.T.S.

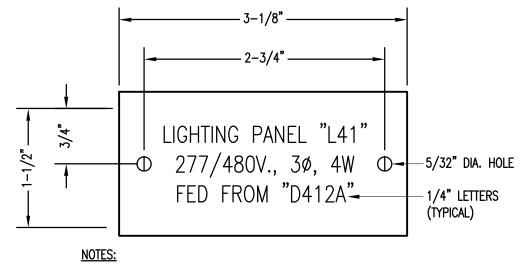

- 1. REFER TO SPECIFICATIONS FOR ADDITIONAL NAMEPLATE REQUIREMENTS.
- 2. NAMEPLATE TO BE 1/16" WHITE PLASTIC WITH BLACK CENTER LAMINATION. FACE TO BE WHITE, ENGRAVED LETTERS TO BE BLACK.
- 3. SECURE NAMEPLATE TO SURFACES WITH (2) FLAT HEAD BRASS SCREWS.

6 DETAIL OF HOUSE PANEL NAMEPLATE

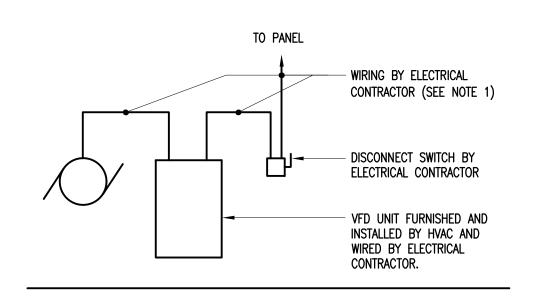

NOTE:

1. REFER TO MOTOR WIRING SCHEDULE FOR WIRE AND CONDUIT SIZE REQUIREMENTS FOR EACH FAN MOTOR, UNLESS OTHERWISE NOTED ON POWER PLAN. COORDINATE WITH MANUFACTURERS SPECIFICATIONS.

9 VFD UNIT WIRING SCHEMATIC

N.T.S.

## Washington Village Phase 1

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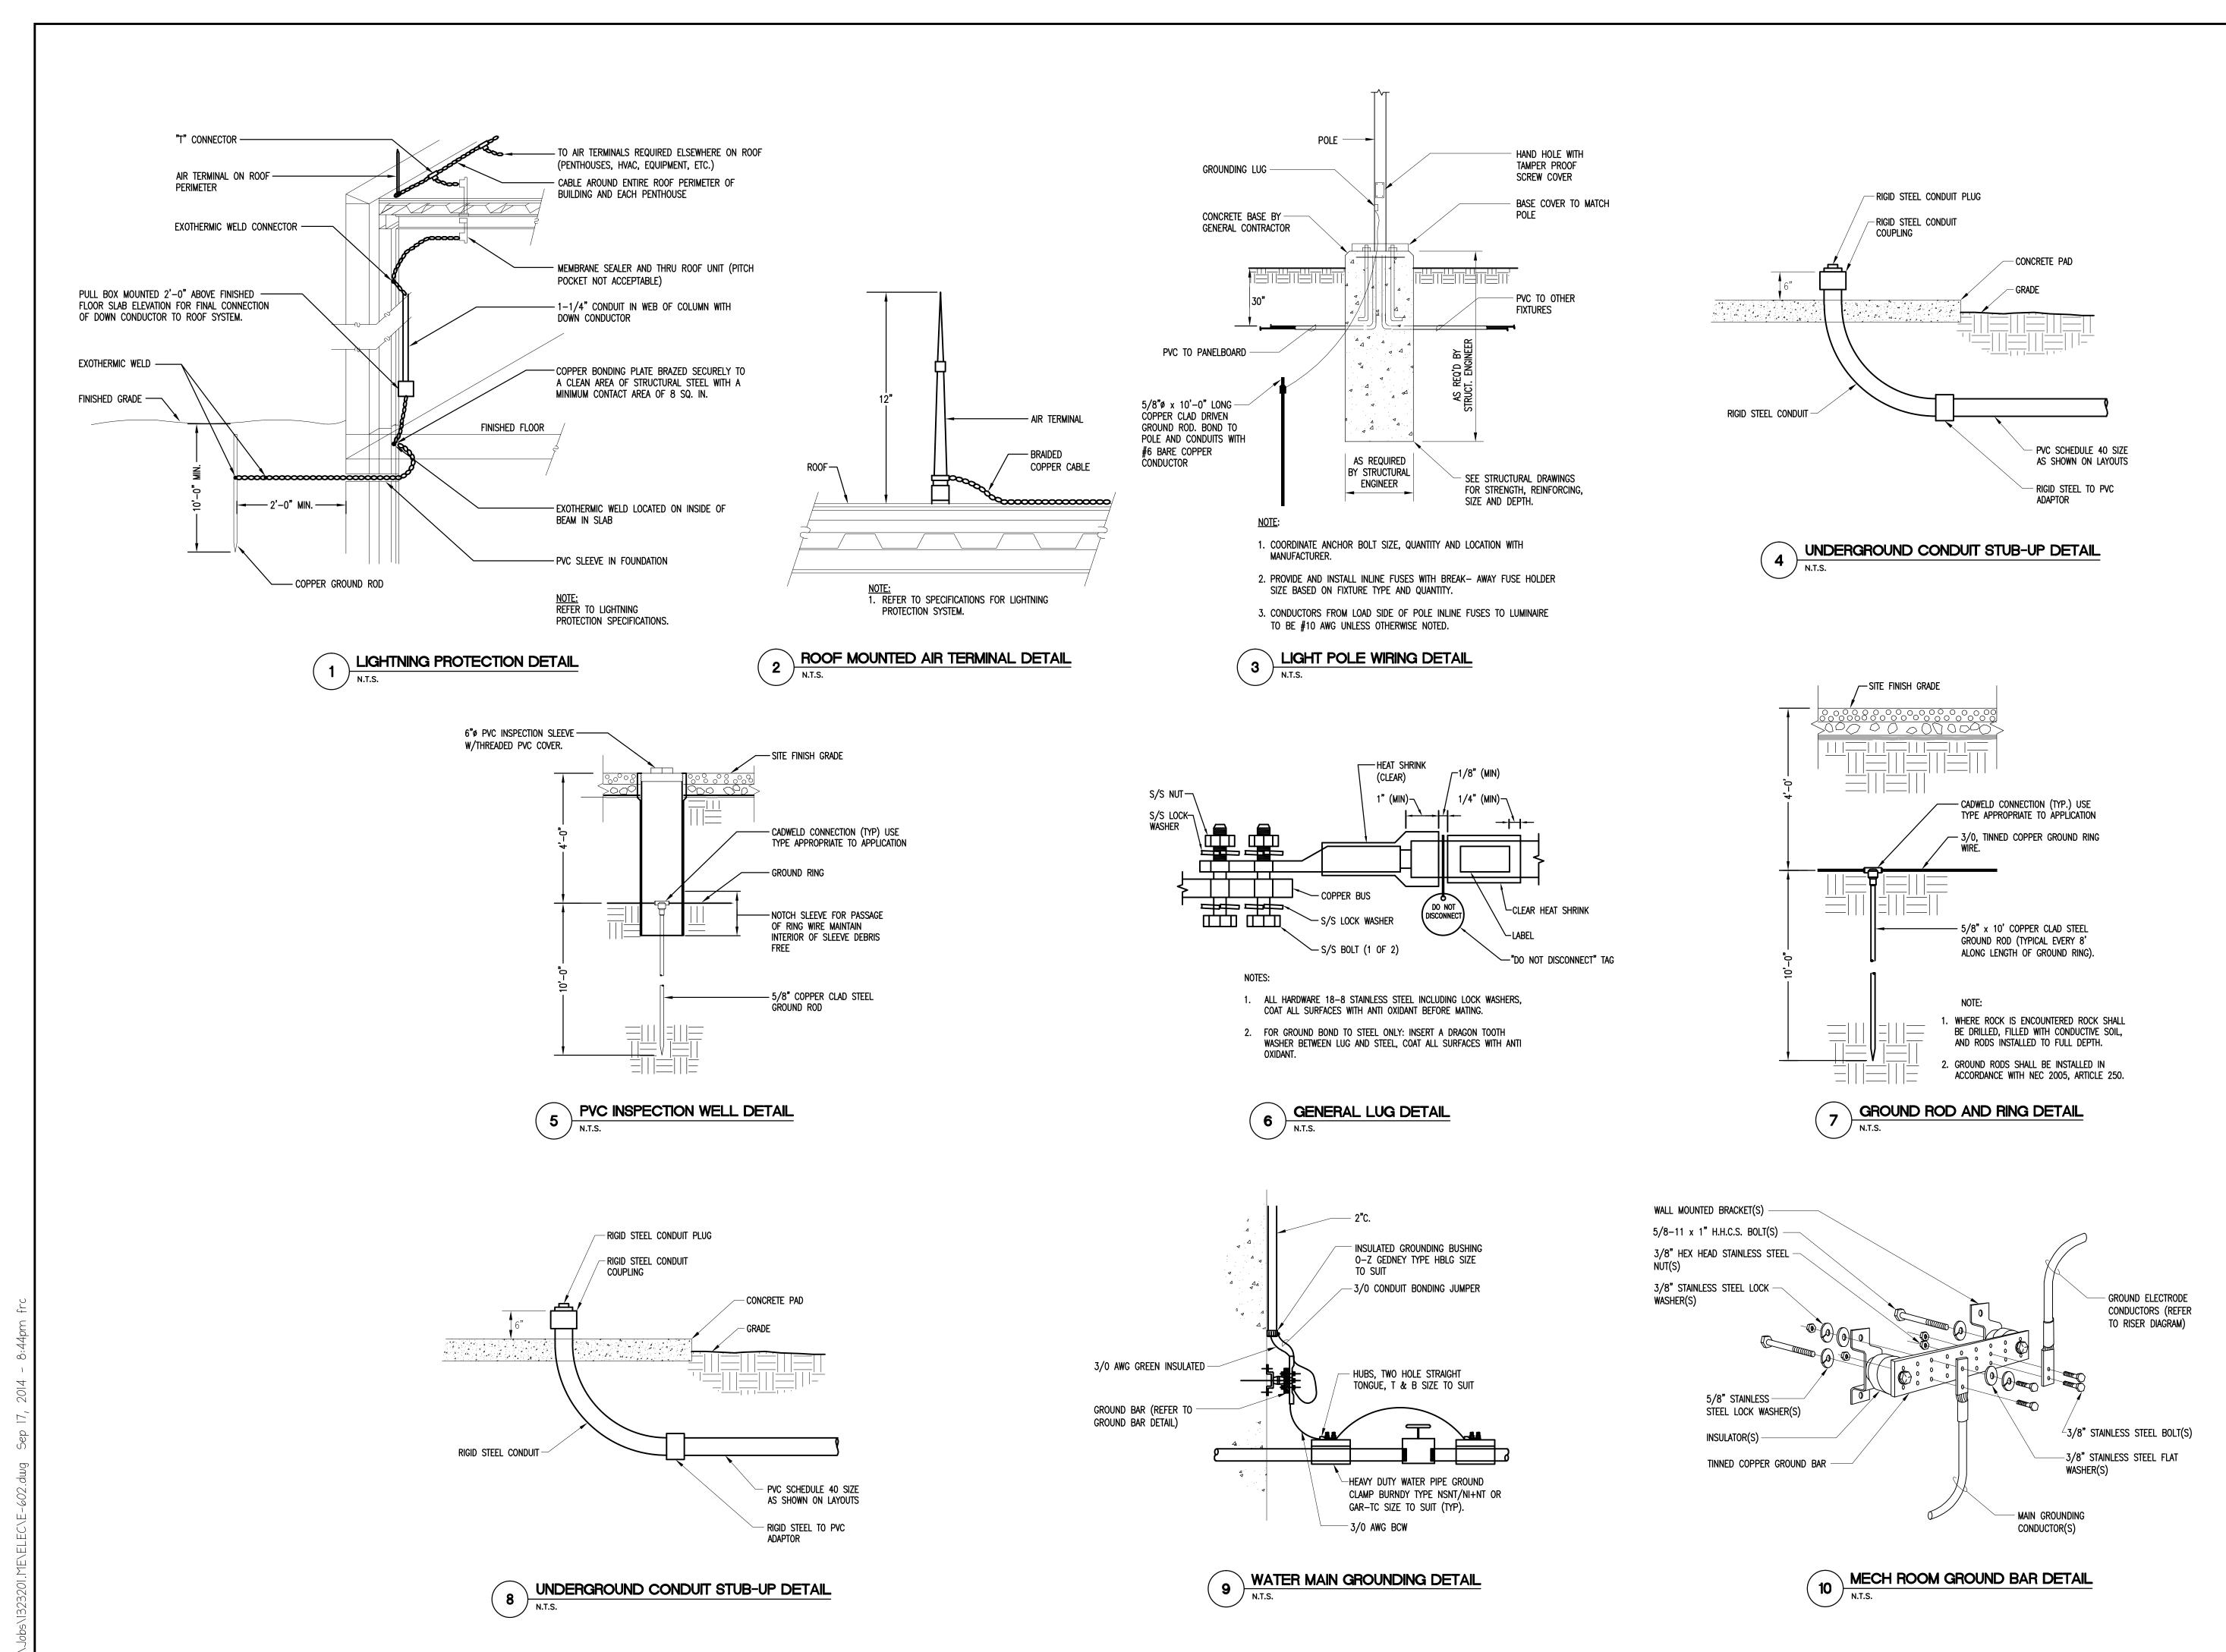
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